

# PROPOSED HARDSTAND AREA FOR WILLFAB SUPER FUND 38-40 ENTERPRISE CRESCENT MUSWELLBROOK, NSW 2333

MUSWELLBROOK SHIRE COUNCIL  
DEVELOPMENT CONSENT  
This document forms part of  
Council's Notice of Determination  
  
DA 2020-22  
Approval Date: 22-Sep-20  
  
Delegated Officer: ALISA EVANS



LOCALITY PLAN  
REFERENCE: SIXMAPS

PROPOSED HARDSTAND  
TO SUBJECT LOT 20  
DP: 1119843

DRAWING SCHEDULE:

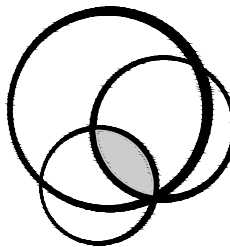
DWG No	DRAWING TITLE	REV	DATE	
19-027-C00	COVER SHEET, LOCALITY PLAN & INDEX SCHEDULE	D	05/08/20	D
19-027-C01	GENERAL NOTES SHEET 1 OF 1	A	10/01/20	
19-027-C02	EXISTING SITE FEATURES	B	05/08/20	B
19-027-C03	SEDIMENTATION AND EROSION PLAN - STAGE 1.0 & 2.0 WORKS	C	05/08/20	C
19-027-C03.1	SEDIMENTATION AND EROSION PLAN - STAGE 3.0 - 4.0 WORKS	A	05/08/20	A
19-027-C03.2	SEDIMENTATION AND EROSION PLAN - STAGE 5.0 WORKS	A	05/08/20	A
19-027-C04	SEDIMENTATION AND EROSION CONTROL	A	10/01/20	
19-027-C05	PROPOSED EARTHWORKS PLAN	C	05/08/20	C
19-027-C06	PROPOSED GRAVEL PLAN AND LEVELS	D	05/08/20	D
19-027-C06.1	HARDSTAND CROSS SECTIONS SHEET 1 OF 1	A	05/08/20	A
19-027-C06.2	HARDSTAND CROSS SECTIONS SHEET 1 OF 2	A	05/08/20	A
19-027-C07	PROPOSED HARDSTAND PLAN	D	05/08/20	D
19-027-C08	TYPICAL SECTIONS - SHEET 1	D	05/08/20	D
19-027-C08.1	TYPICAL SECTIONS - SHEET 2	A	05/08/20	A
19-027-C09	DRIVEWAY PLAN AND LONGSECTION	D	05/08/20	D
19-027-C10	TURNING TEMPLATE	B	04/02/20	
19-027-C11	BASIN PLAN AND LONGSECTION	D	05/08/20	D
19-027-C12	BASIN CROSS SECTIONS SHEET 1 OF 1	C	05/08/20	C
19-027-C13	PIPE PLAN AND LONGSECTIONS	C	05/08/20	C
19-027-C14	PIPE DETAILS AND SECTIONS	D	05/08/20	D
19-027-C15	LANDSCAPE PLAN	B	05/08/20	B

REV	DESCRIPTION	DATE	BY	REV	DESCRIPTION	DATE	BY
D	GENERAL AMENDMENTS	05/08/20	CH				
C	GENERAL AMENDMENTS	16/06/20	CH				
B	INCREASE HARDSTAND AREA	04/02/20	BC				
A	ISSUED FOR APPROVAL	10/01/20	CH				

WILLFAB SUPERFUND  
c/o GRAEME RAY  
PO BOX 136  
LAMBTON, NSW, 2099

PROPOSED HARDSTAND  
38-40 ENTERPRISE CRESCENT  
MUSWELLBROOK, NSW 2333

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COVER SHEET, LOCALITY  
PLAN AND INDEX

Scale  
Horizontal:

CIVIL DRAWING			
Designed	BH	Approved on behalf of RHM Consulting Engineers	
Drawn	CH	Project Engineer/Director	05/08/20 Date
Datum	NIL	Drawing No:	Rev
Date	JULY 20	19-027-C00	D



GENERAL

- G1

IF IN DOUBT ASK.
- G2

THESE DRAWINGS SHALL BE READ IN CONJUNCTION WITH ALL ARCHITECTURAL AND OTHER CONSULTANTS DRAWINGS TO INCLUDE SURVEY & GEOTECHNICAL REPORTS AND SPECIFICATIONS AND SUCH OTHER WRITTEN INSTRUCTIONS AS MAY BE ISSUED DURING THE COURSE OF THE CONTRACT. ANY DISCREPANCY SHALL BE REFERRED TO THE ENGINEER PRIOR TO PROCEEDING WITH THE WORK.
- G3

MATERIAL & WORKMANSHIP SHALL BE IN ACCORDANCE WITH THE RELEVANT S.A.A. CODES AND RELEVANT AUTHORITIES.
- G4

ALL DIMENSIONS AND REDUCED LEVELS MUST BE VERIFIED ON SITE PRIOR TO THE COMMENCEMENT OF WORK.
- G5

SUBSTITUTIONS MUST BE APPROVED BY THE ENGINEER.
- G6

UNLESS NOTED OTHERWISE ALL LEVELS SHOWN ARE TO THE AUSTRALIAN HEIGHT DATUM. GRID LINES TO MGA. NOTE CORRECT FACTOR APPLY.
- G7

SERVICE INFORMATION SHOWN IS BASED ON PLANS SUPPLIED BY AUTHORITIES AND IS APPROXIMATE ONLY. PRIOR TO THE COMMENCEMENT OF ANY WORKS, THE CONTRACTOR SHALL LOCATE ALL UNDERGROUND SERVICES AND COMPLY WITH ALL REQUIREMENTS OF THOSE AUTHORITIES.
- G8

EXISTING SURFACE CONTOURS, WHERE SHOWN, ARE INTERPOLATED AND MAY NOT BE ACCURATE.
- G9

PRIOR TO THE PLACEMENT OF ANY FILL, PAVEMENT OR BUILDING, THE EXPOSED SUBGRADE SHALL BE COMPACTED TO A MINIMUM OF 100% STANDARD COMPACTION IN ACCORDANCE WITH TEST 'E1.1' OF A.S. 1289 FOR THE TOP 300MM. ANY SOFT SPOTS SHALL BE REMOVED AND REPLACED WITH GRANULAR FILL TO THE ENGINEERS APPROVAL AND COMPACTED IN ACCORDANCE WITH THE COMPACTION REQUIREMENTS SET OUT BELOW.
- G10

GRADE EVENLY BETWEEN FINISHED SURFACE SPOT LEVELS. FINISHED SURFACE CONTOURS ARE SHOWN FOR CLARITY. WHERE FINISHED SURFACE LEVELS ARE NOT SHOWN, THE SURFACE SHALL BE GRADED SMOOTHLY SO THAT IT WILL DRAIN AND MATCH ADJACENT SURFACES OR STRUCTURES.
- G11

UNLESS NOTED OTHERWISE, ALL DOWNPIPES SHALL BE CONNECTED TO PITS OR MAIN STORMWATER DRAINS WITH UPVC PIPES OF THE FOLLOWING SIZES LAID AT A MINIMUM GRADE OF 1 IN 100:

A. 100 DIA. FOR DOMESTIC CONSTRUCTION.

B. 150 DIA. FOR COMMERCIAL / INDUSTRIAL CONSTRUCTION.

C. CONNECTION TO BE PRESSURISED.
- G12

UNLESS NOTED OTHERWISE ALL MAIN STORMWATER DRAINS SHALL BE CONSTRUCTED USING ONE OF THE FOLLOWING TYPES OF PIPES WITH RUBBER RING JOINTS:

A. CLASS 2 RCP IN ACCORDANCE WITH A.S. 1342

B. UPVC IN ACCORDANCE WITH A.S. 1260

ANY OTHER TYPES OF PIPE MUST BE REFERRED TO COUNCIL FOR APPROVAL PRIOR TO USE. IF UPVC, OR OTHER PIPES ARE TO BE USED, APPROVAL MUST BE GIVEN BY THE ENGINEER FOR CLASS, BEDDING AND BACKFILL REQUIREMENTS.
- G13

GENERALLY FOR TRENCHING WORKS THE CONTRACTOR MUST:

A. COMPLY WITH THE GENERAL PROVISIONS OF THE 'OCCUPATIONAL HEALTH SAFETY ACT 2000.

B. COMPLY WITH THE 'OCCUPATIONAL HEALTH & SAFETY CODE OF PRACTISE FOR SAFETY PRECAUTIONS IN TRENCHING OPERATIONS'.

C. FULFILL ALL WORK COVER REQUIREMENTS'.
- G14

ANY STRUCTURES, PAVEMENTS OR SURFACES DAMAGED, DIRTIED OR MADE UNSERVICEABLE DUE TO CONSTRUCTION WORK SHALL BE REINSTATED TO THE SATISFACTION OF THE ENGINEER.
- G15

AUSPEC SPECIFICATION TO APPLY
- G16

MINIMUM BEARING PRESSURE TO SUBGRADE 100kPa

1. ALL EROSION CONTROL MEASURES TO BE INSTALLED PRIOR TO THE COMMENCEMENT OF ANY SITE WORK.

2. ALL EROSION CONTROL MEASURES MUST BE INSPECTED AFTER EACH RAINFALL EVENT. SILT SHALL BE REMOVED TO AN APPROVED LOCATION.

3. SEDIMENT FENCES, TRAPS & FILTERS SHALL BE INSTALLED IN ACCORDANCE WITH THE APPROVED EROSION CONTROL PLANS PREPARED BY THE CONTRACTOR.

4. SEDIMENT FENCES, TRAPS & FILTERS SHALL BE MAINTAINED IN THE LOCATION SHOWN ON THE DRAWING UNTIL SUCH TIME THAT ALL WORK IS COMPLETED AND A SUITABLE GRASS COVER IS ESTABLISHED.

REINFORCED CONCRETE

- RC1

ALL WORKMANSHIP AND MATERIALS SHALL BE IN ACCORDANCE WITH AS 3600 CURRENT EDITION WITH AMENDMENTS, EXCEPT WHERE VARIED BY THE CONTRACT DOCUMENTS.
- RC2

READYMIX CONCRETE SUPPLY SHALL COMPLY WITH AS 1379.
- RC3

CONCRETE QUALITY - MINIMUM - REFER TO RELEVANT DRAWINGS.
- ALL THE REQUIREMENTS OF THE ACSE CONCRETE SPECIFICATION DOCUMENT 1 (LATEST EDITION)SHALL APPLY TO THE FORMWORK, REINFORCEMENT AND CONCRETE UNLESS NOTED OTHERWISE.
- ELEMENT

STRENGTH

SLUMP

MAX. AGG. SIZE

CEMENT TYPE
- FOUNDATION PIERS

32

80

20

Portland
- 25

80

20

Portland

COMPRESSIVE STRENGTH  
SAMPLE, TEST, AND ASSES TO AS 1379. ALL TESTING TO BE CONDUCTED BY A NATA REGISTERED LABORATORY.  
THE MINIMUM FREQUENCY OF SAMPLING OF THE CONCRETE AT EACH STAGE SHALL BE IN ACCORDANCE WITH THE FOLLOWING:  
NO. OF BATCHES SUPPLIED TO THE PROJECT PER DAY  
1  
2 to 5  
6 to 10  
11 to 20  
For each additional 10 samples  
1  
NO. OF SAMPLES TAKEN  
1  
2  
3  
4  
A SAMPLE SHALL CONSIST OF FOUR CYLINDERS, TWO OF WHICH SHALL BE TESTED AT 28 DAYS ,ONE AT 7 DAYS AND ONE AT 4 DAYS'. IF THE CONTRACTOR REQUIRES EARLY STRENGTH RESULTS, ADDITIONAL CYLINDERS SHALL BE TAKEN IN THE SAMPLE AS REQUIRED AND AT THE COST OF THE CONTRACTOR.

OTHER QUALITY PARAMETERS  
SAMPLE, TEST AND ASSES TO AS 1379 SECTION 5.  
SLUMP: TEST NOT LESS THAN ONE SAMPLE FOR EACH BATCH BEFORE PLACING CONCRETE FROM THAT BATCH IN THE WORK. TAKE THE SAMPLES AT THE POINT OF DISCHARGE ON SITE.  
DRYING SHRINKAGE: THE MAXIMUM TOTAL DRYING SHRINKAGE LIMIT FOR THE CONCRETE SHALL BE AN AVERAGE OF 0.070% AT 56 DAYS AND NO SINGLE RESULT SHALL EXCEED 0.075%. MEASUREMENT SHALL BE IN ACCORDANCE WITH AS1012 PART 13 AND BE CONDUCTED BY A NATA REGISTERED LABORATORY. REFER TO RELEVANT FLOOR DRAWINGS FOR SPECIFIC SHRINKAGE REQUIREMENT  
REJECTION: REMOVE THE CONCRETE FROM THE SITE.

- RC4

NO ADMIXTURES SHALL BE USED IN CONCRETE UNLESS APPROVED IN WRITING.
- RC5

DEPTH OF BEAMS ARE GIVEN FIRST AND INCLUDE SLAB THICKNESSES. SLABS AND BEAMS SHALL BE CAST TOGETHER UNLESS NOTED OTHERWISE.
- RC6

CONCRETE SIZES DO NOT INCLUDE THICKNESSES OF APPLIED FINISHES.
- RC7

NO HOLES, CHASES OR EMBEDMENTS OTHER THAN THOSE SHOWN ON THE DRAWINGS SHALL BE MADE IN CONCRETE ELEMENTS WITHOUT THE PROJECT ENGINEERS APPROVAL.
- RC8

CONCRETE SHALL BE KEPT FREE OF SUPPORTING MASONRY WITH A PRE-GREASED GALVANISED STEEL SLIP JOINT, VERTICAL FACES SHALL BE SEPARATED BY 10MM JOINTEX (OR EQUAL).
- RC9

CONSTRUCTION JOINTS SHALL BE LOCATED TO THE SATISFACTION OF THE PROJECT ENGINEER. THE BUILDER SHALL ALLOW FOR ALL NECESSARY CONSTRUCTION JOINTS.
- RC10

SLABS WHERE NOTED ON PLANS. MAINTAIN SLAB AND BEAM DEPTHS AS SHOWN. PROVIDE 0MM PRECAMBER TO POST TENSIONED SLABS U.N.O. ON PLANS. 50MM COVER TO CONDUIT MINIMUM.
- RC11

PROVIDE UPWARD CAMBER TO FORMWORK OF REINFORCED CONCRETE CANTILEVERS OF L/200 WHERE L IS THE PROJECTION BEYOND COLUMN OR WALL FACE, AND TO FORMWORK OF CONDUITS AND PIPES WHEN CAST IN SLABS OR WALLS ARE TO BE PLACED BETWEEN THE REINFORCEMENT LAYERS. WHERE THERE IS ONLY ONE LAYER OF REINFORCEMENT, PROVIDE
- RC12

THE FINISHED CONCRETE SHALL BE A DENSE HOMOGENEOUS MASS, COMPLETELY FILLING THE FORMWORK THOROUGHLY EMBEDDING THE REINFORCEMENT AND FREE OF STONE POCKETS. ALL CONCRETE INCLUDING SLABS ON GROUND AND FOOTINGS SHALL BE COMPACTED WITH MECHANICAL VIBRATORS.
- RC13

SLABS AND BEAMS SHALL BE CONSTRUCTED TO BEAR ONLY ON THE BEAMS, COLUMNS, WALLS ETC. SHOWN ON THE DRAWINGS. ALL OTHER BUILDING ELEMENTS SHALL BE KEPT 12MM MINIMUM CLEAR FROM SOFFITS OF STRUCTURE.
- RC14

CURING OF ALL CONCRETE IS TO BE ACHIEVED BY KEEPING SURFACES CONTINUOUSLY WET FOR A PERIOD OF 3 DAYS, AND PREVENTION OF LOSS OF MOISTURE FOR A TOTAL OF 7 DAYS FOLLOWED BY A GRADUAL DRYING OUT. APPROVED SPRAYED ON CURING COMPOUNDS THAT COMPLY WITH AS 3799 MAY BE USED WHERE FLOOR FINISHES WILL NOT BE AFFECTED. (REFER MANUFACTURERS SPECIFICATION). POLYTHENE SHEETING OR WET HESSIAN MAY BE USED TO RETAIN MOISTURE WHERE PROTECTED FROM WIND AND TRAFFIC.
- RC15

CONSTRUCTION SUPPORT PROPPING IS TO BE LEFT IN PLACE WHERE NEEDED TO AVOID OVERTRESSING THE STRUCTURE DUE TO CONSTRUCTION LOADING. NO BRICKWORK OR PARTITION WALLS ARE TO BE CONSTRUCTED ON SUSPENDED LEVELS UNTIL ALL PROPPING IS REMOVED AND THE SLAB HAS ABSORBED ITS DEAD LOAD DEFLECTION.

1. NO EARTHWORKS SHALL BE CARRIED OUT DURING HIGH WINDS OR AS DIRECTED BY MID-COAST COUNCIL/ PROJECT MANAGER

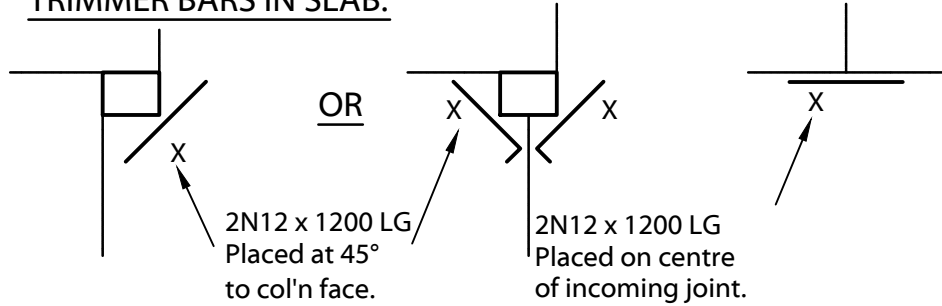
2. DURING EARTHWORKS THE CONTRACTOR SHALL HAVE A WATER CART OR SIMILAR APPROVED ON SITE AND MUST PROGRESSIVELY WATER DOWN EXCAVATION AND FILL AREAS TO MINIMISE DUST.

3. ALL VEHICLE TRAVEL PATHS AND ROADS SHALL BE REGULARLY WATERED TO MINIMISE DUST AND DIRT ON ROAD SURFACES.

SLABS ON GRADE

SO G1 ALL RE-ENTRANT CORNERS AT PENETRATIONS FOR SUMPS, PITS, COLUMN BLOCKOUTS AND THE LIKE, TO HAVE N12 TRIMMER BARS PLACED AT 45 DEGREES TO CORNER OR IN EACH DIRECTION AT CORNERS UNLESS NOTED IN A DIFFERENT ARRANGEMENT ON PLAN.

TRIMMER BARS IN SLAB:



TRIMMER BARS TO BE TIED TO U/S OF SLAB MESH.

PROVIDE SUB-FLOOR DRAINAGE TO HYDRAULIC ENGINEERS DETAILS.

PRIOR TO PLACEMENT OF SLAB, SUBGRADE SHALL BE COMPACTED TO A MINIMUM OF 98% STANDARD COMPACTION IN ACCORDANCE WITH TEST 'E1.1' OF AS 1289 FOR THE TOP 300MM. ANY SOFT SPOTS SHALL BE REMOVED AND REPLACED WITH SITE WON MATERIAL TO THE ENGINEERS APPROVAL.

SO G2 ENSURE SLABS ARE CURED AS PER NOTE RC14.

SO G3 SAWJOINTS TO BE INSTALLED AS SHOWN WITHIN 12 HOURS OF POURING.

EARTHWORK NOTES

1. IF IN DOUBT, THEN ASK.

2. ALL WORKS IN ACCORDANCE TO AS 3798-2007 'GUIDELINES ON EARTHWORKS FOR COMMERCIAL & RESIDENTIAL DEVELOPMENTS'.

3. MIN COMPACTION TO ALL FILLED AREAS TO BE 98% STD UNLESS NOTED OTHERWISE COMPACTION UNDER BUILDING PLATFORM TO BE 100% STD.

4. ALL CUT MATERIAL TO BE LAID IN ROW ON THE SITE FOR DRYING. THIS MATERIAL SHOULD BE INSPECTED AND ASSESSED BY THE GEOTECHNICAL ENGINEER TO DETERMINE IF THE MATERIAL IS SUITABLE FOR FILLING RE-LAID IN ACCORDANCE WITH AS 3798'

5. THE CONTRACTOR MUST ENSURE ADEQUATE TEMPORARY DRAINAGE DURING THE WORKS TO MINIMISE THE IMPACT OF WET WEATHER. SUCH METHODS AS THE INSTALLATION OF SUMP PITS, CROSS FALLS AND SEALINGS (COMPACTION) OF EXPOSED SURFACE FALLS PART OF THE EARTHWORKS CONTRACTOR RESPONSIBILITIES.

6. SEDIMENTATION AND EROSION CONTROL MUST BE PUT IN PLACE PRIOR TO CONSTRUCTION AND MAINTAINED THROUGHOUT THE WORKS.

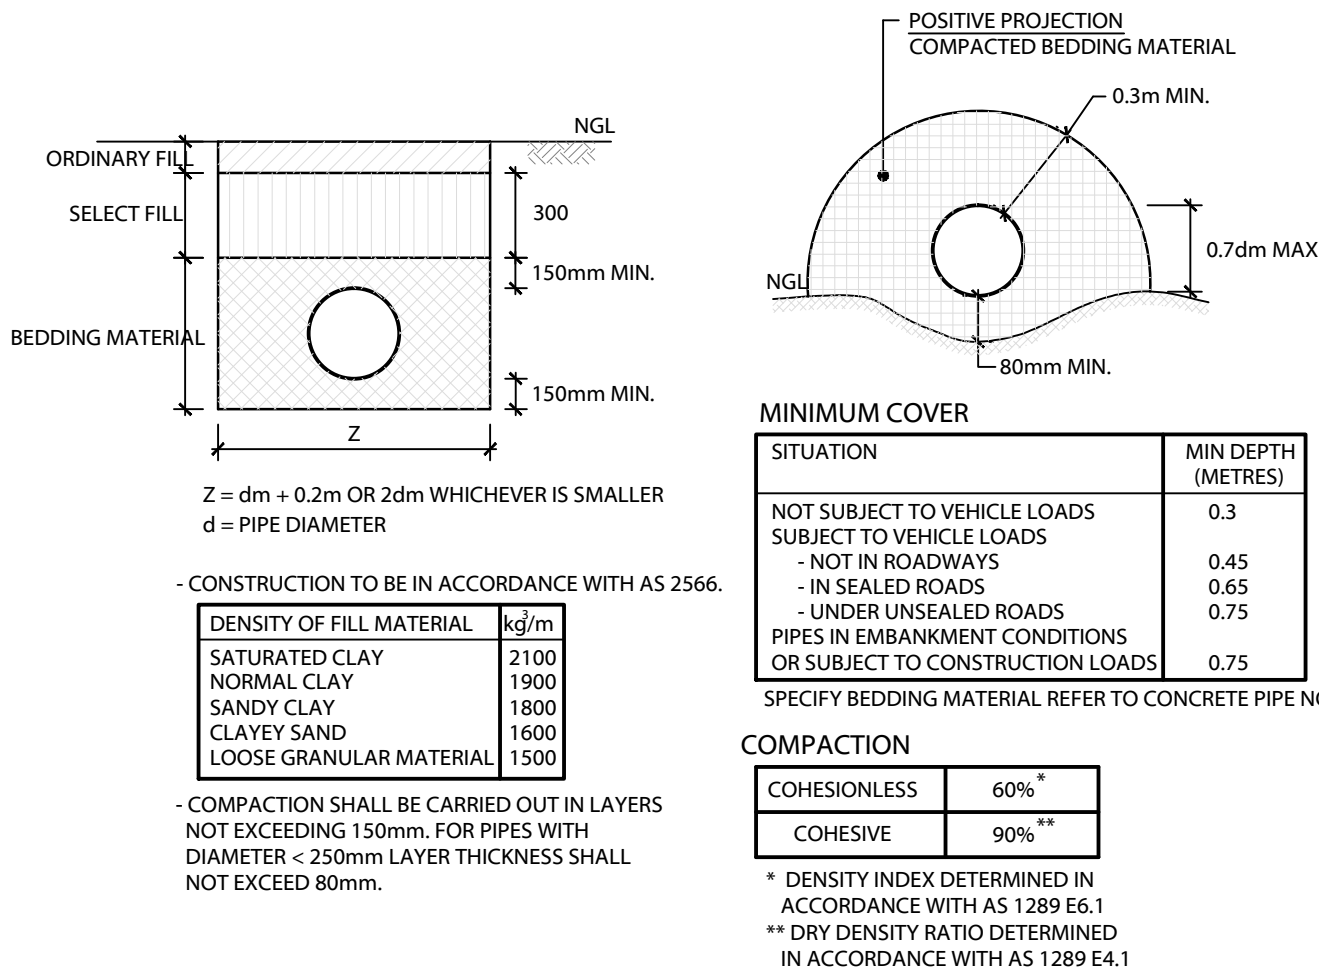
7. ADOPTED BOXOUT DEPTHS ARE TABULATED BELOW.

8. FREQUENCY OF COMPACTION TESTING IN ACCORDANCE WITH AS 3798 TABLE & ASSOCIATED SPECIFICATION.

9. FINISHED SUB-GRADE SHOULD BE INSPECTED AND PROOF ROLLED IN THE PRESENCE OF A GEOTECHNICAL ENGINEER WITH ALL SIGNIFICANT DEFLECTION TO BE OVER EXCAVATED AND REPLACED WITH SUITABLE FILL TO A MINIMUM DEPTH OF 300MM. REPLACE WITH CLEAN FILL GREATER THAN CBR-25% AND COMPACT TO 98% STD.

10. FINAL BATTER TO BE NO STEEPER THAN 4 IN 1 (HORIZONTAL TO VERTICAL)

SUPPORT FOR PLASTIC & PVC PIPES



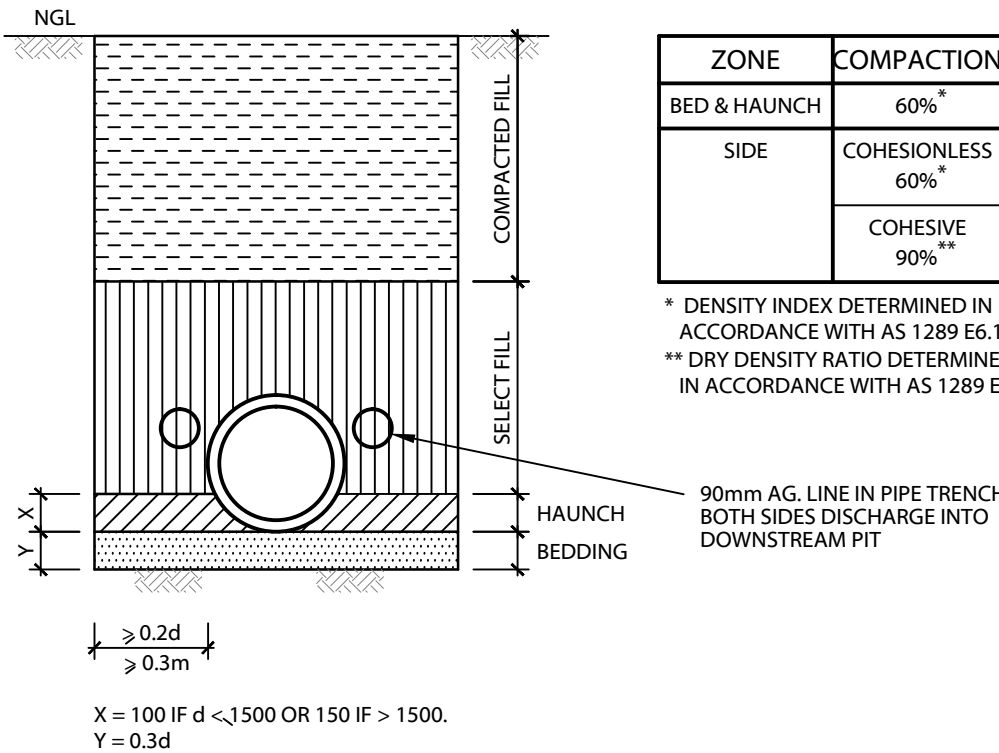
GRADING SPECIFICATION OF PIPE BACKFILL

BED & HAUNCH		SELECT	
SIEVE	WT PASSING %	SIEVE	WT PASSING %
19	100	19	100
2.36	100-50	9.50	100-50
0.60	90-20	2.36	100-30
0.30	60-10	0.60	50-15
0.15	25-0	0.075	25-0
0.075	10-0		

SUPPORT FOR CONCRETE PIPES

GRADING SPECIFICATION OF PIPE BACKFILL

BED & HAUNCH		SELECT	
SIEVE	WT PASSING %	SIEVE	WT PASSING %
19	100	19	100
2.36	100-50	9.50	100-50
0.60	90-20	2.36	100-30
0.30	60-10	0.60	50-15
0.15	25-0	0.075	25-0
0.075	10-0		



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DEVELOPMENT CONSENT  
This document forms part of  
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DA 2020-22  
Approval Date: 22-Sep-20

Delegated Officer: ALISA EVANS

GENERAL NOTES SHEET  
1 OF 1

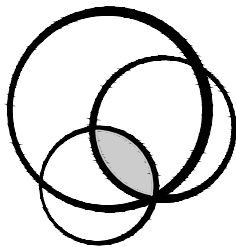
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Horizontal:

CIVIL DRAWING			
Designed	BH	Approved on behalf of RHM Consulting Engineers	
Drawn	CH	10/01/20	
		Date	
		Project Engineer/Director	
		Drawing No:	
		Rev	
		Date	
		DEC 19	
		19-027-C01	
		A	

WILLFAB SUPERFUND  
c/o GRAEME RAY  
PO BOX 136  
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PROPOSED HARDSTAND  
38-40 ENTERPRISE CRESCENT  
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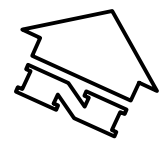
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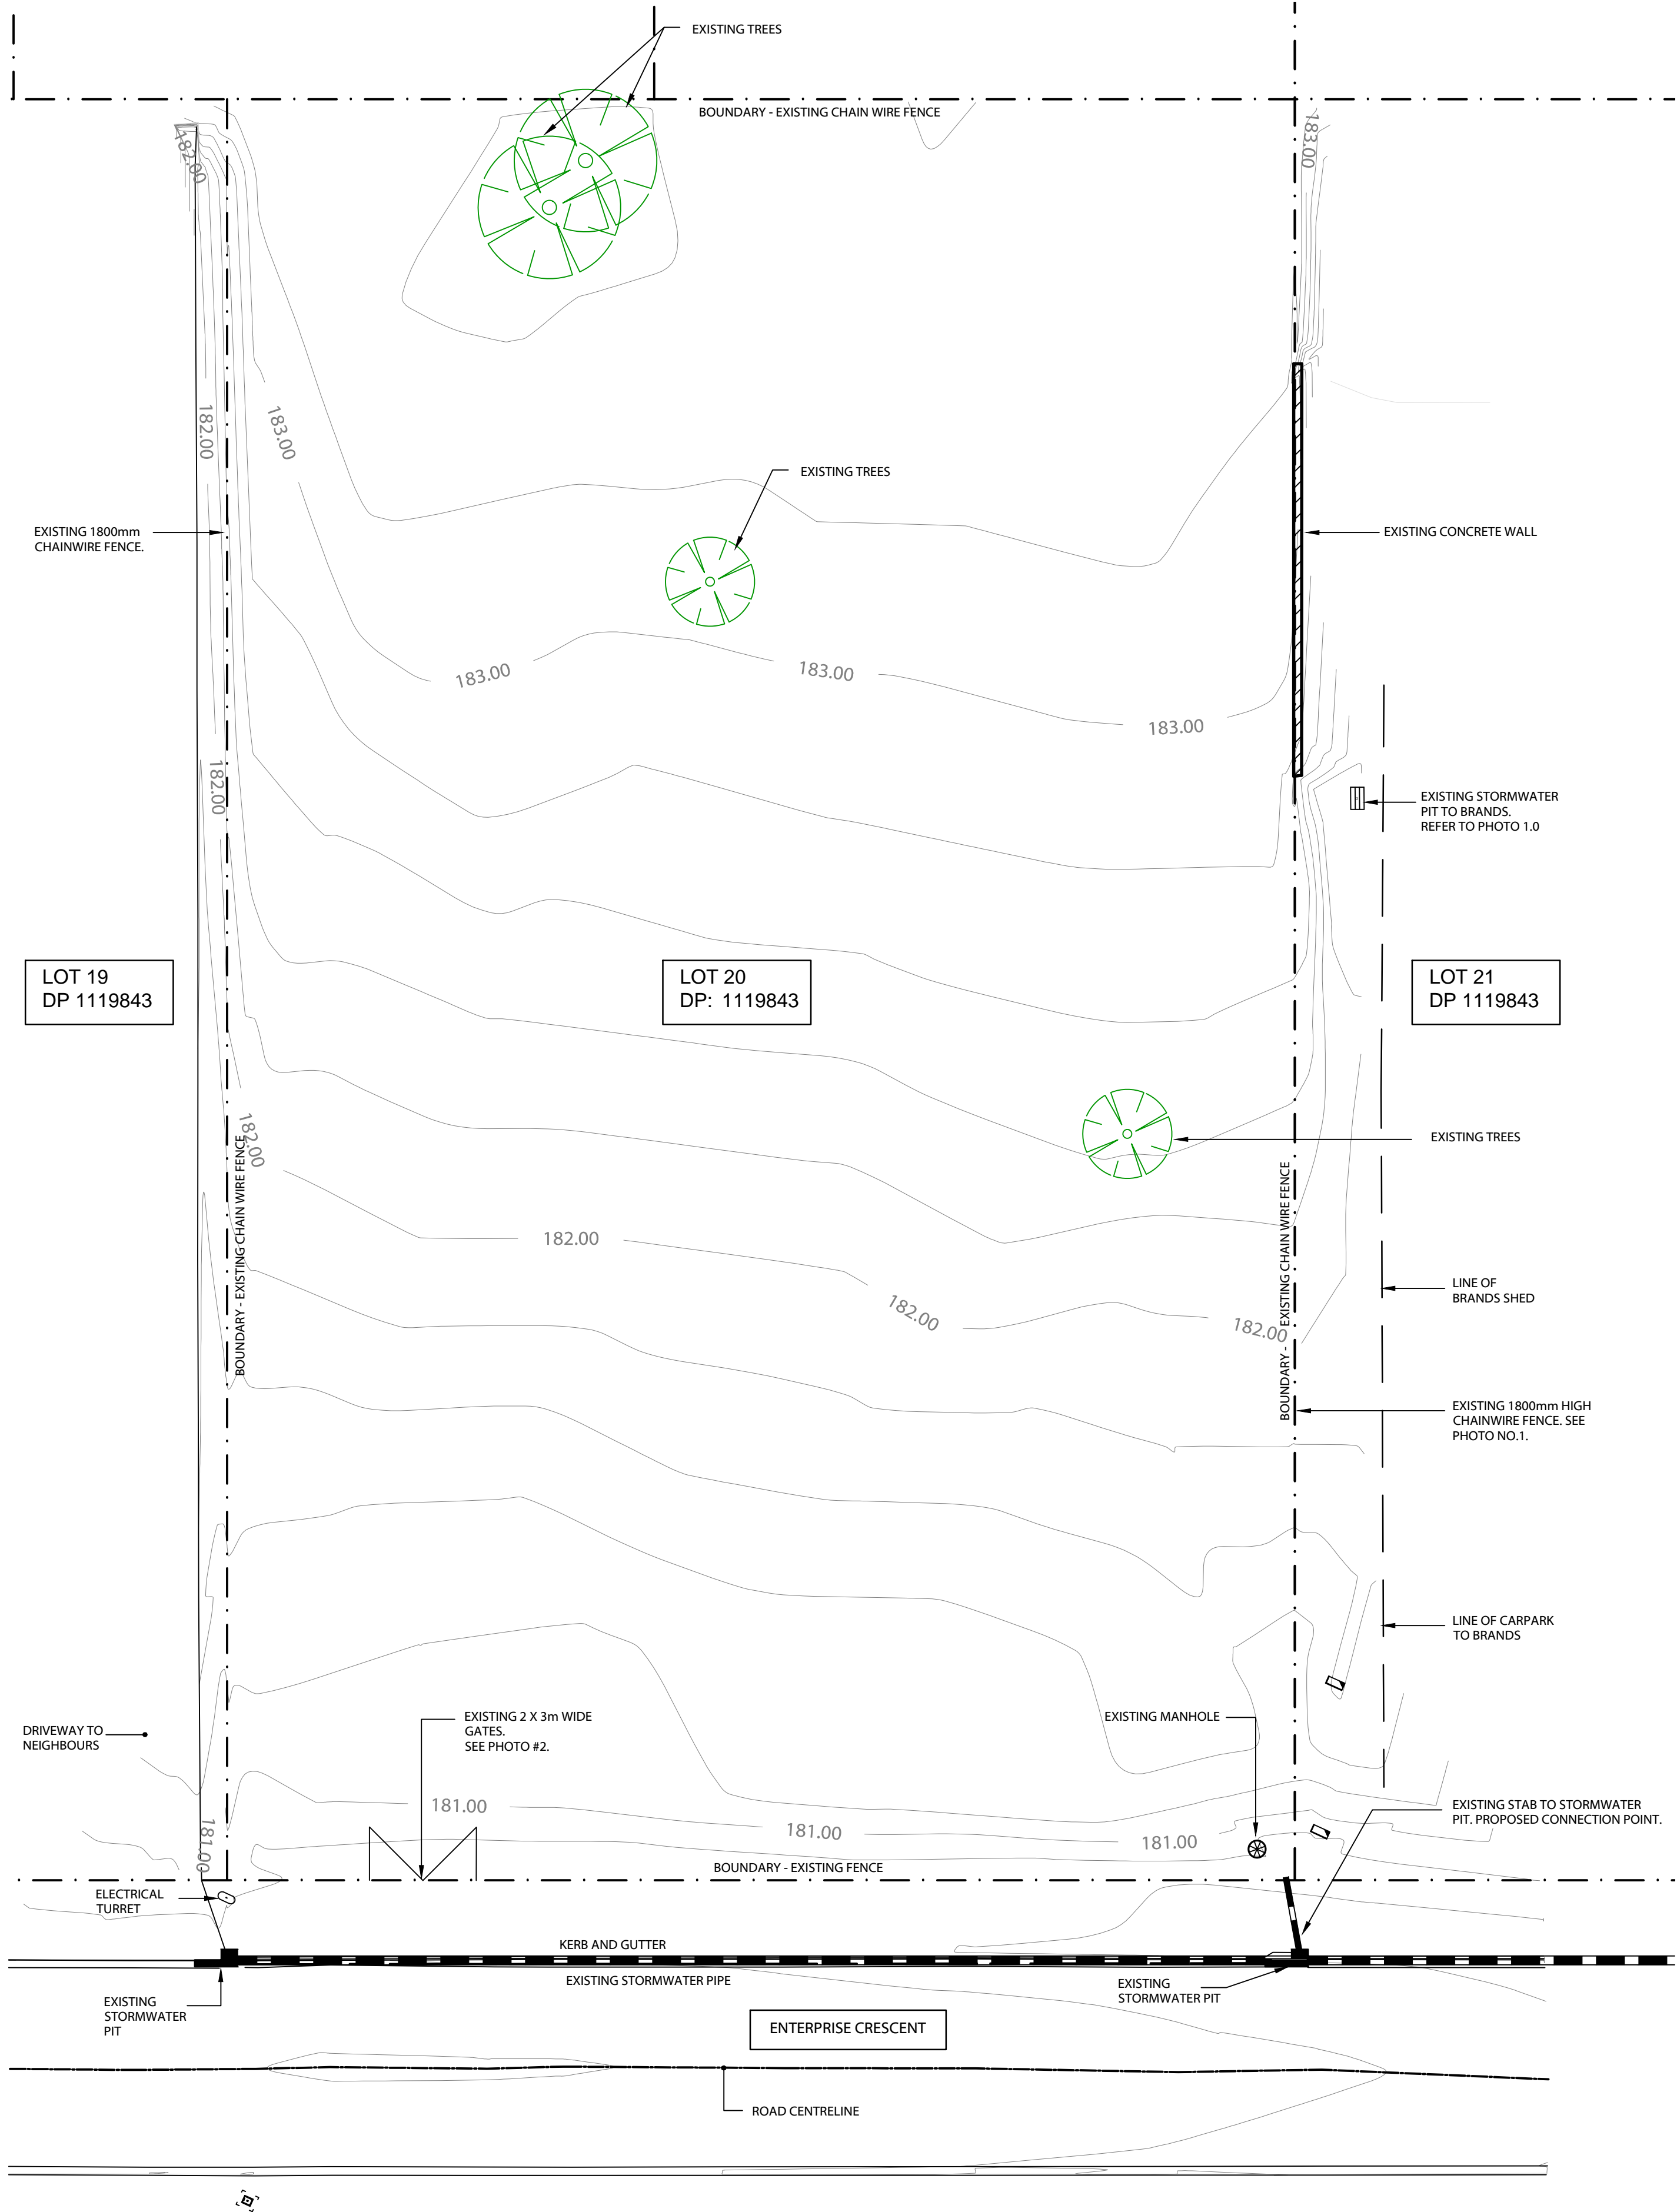
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MAINTAIN EXISTING  
2x3m GATE AT  
CURRENT LOCATION  
UNTIL DRIVEWAY IS  
COMPLETED



EXISTING SITE FEATURES

SCALE 1:250 (A1)  
NOTE: NO VEHICULAR CROSSOVER TO LOT



PHOTO 1.0 - Boundary Fence East and  
Stormwater Drainage to Brands



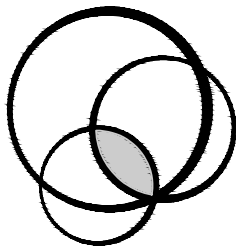
PHOTO 2.0 - Boundary Fence West  
and Front Gate

REV	DESCRIPTION	DATE	BY	REV	DESCRIPTION	DATE	BY
B	GENERAL AMENDMENTS	05/08/20	CH				
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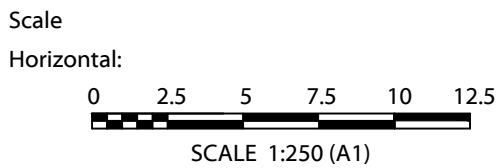
PROPOSED HARDSTAND  
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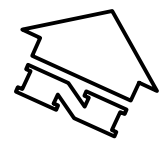
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EXISTING SITE  
FEATURES



CIVIL DRAWING					
Designed	BH	Approved on behalf of RHM Consulting Engineers		05/08/20	
Drawn	CH	Project Engineer/Director		Date	
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CONSTRUCTION PHASE - Stage 1.0 to Stage 2.0

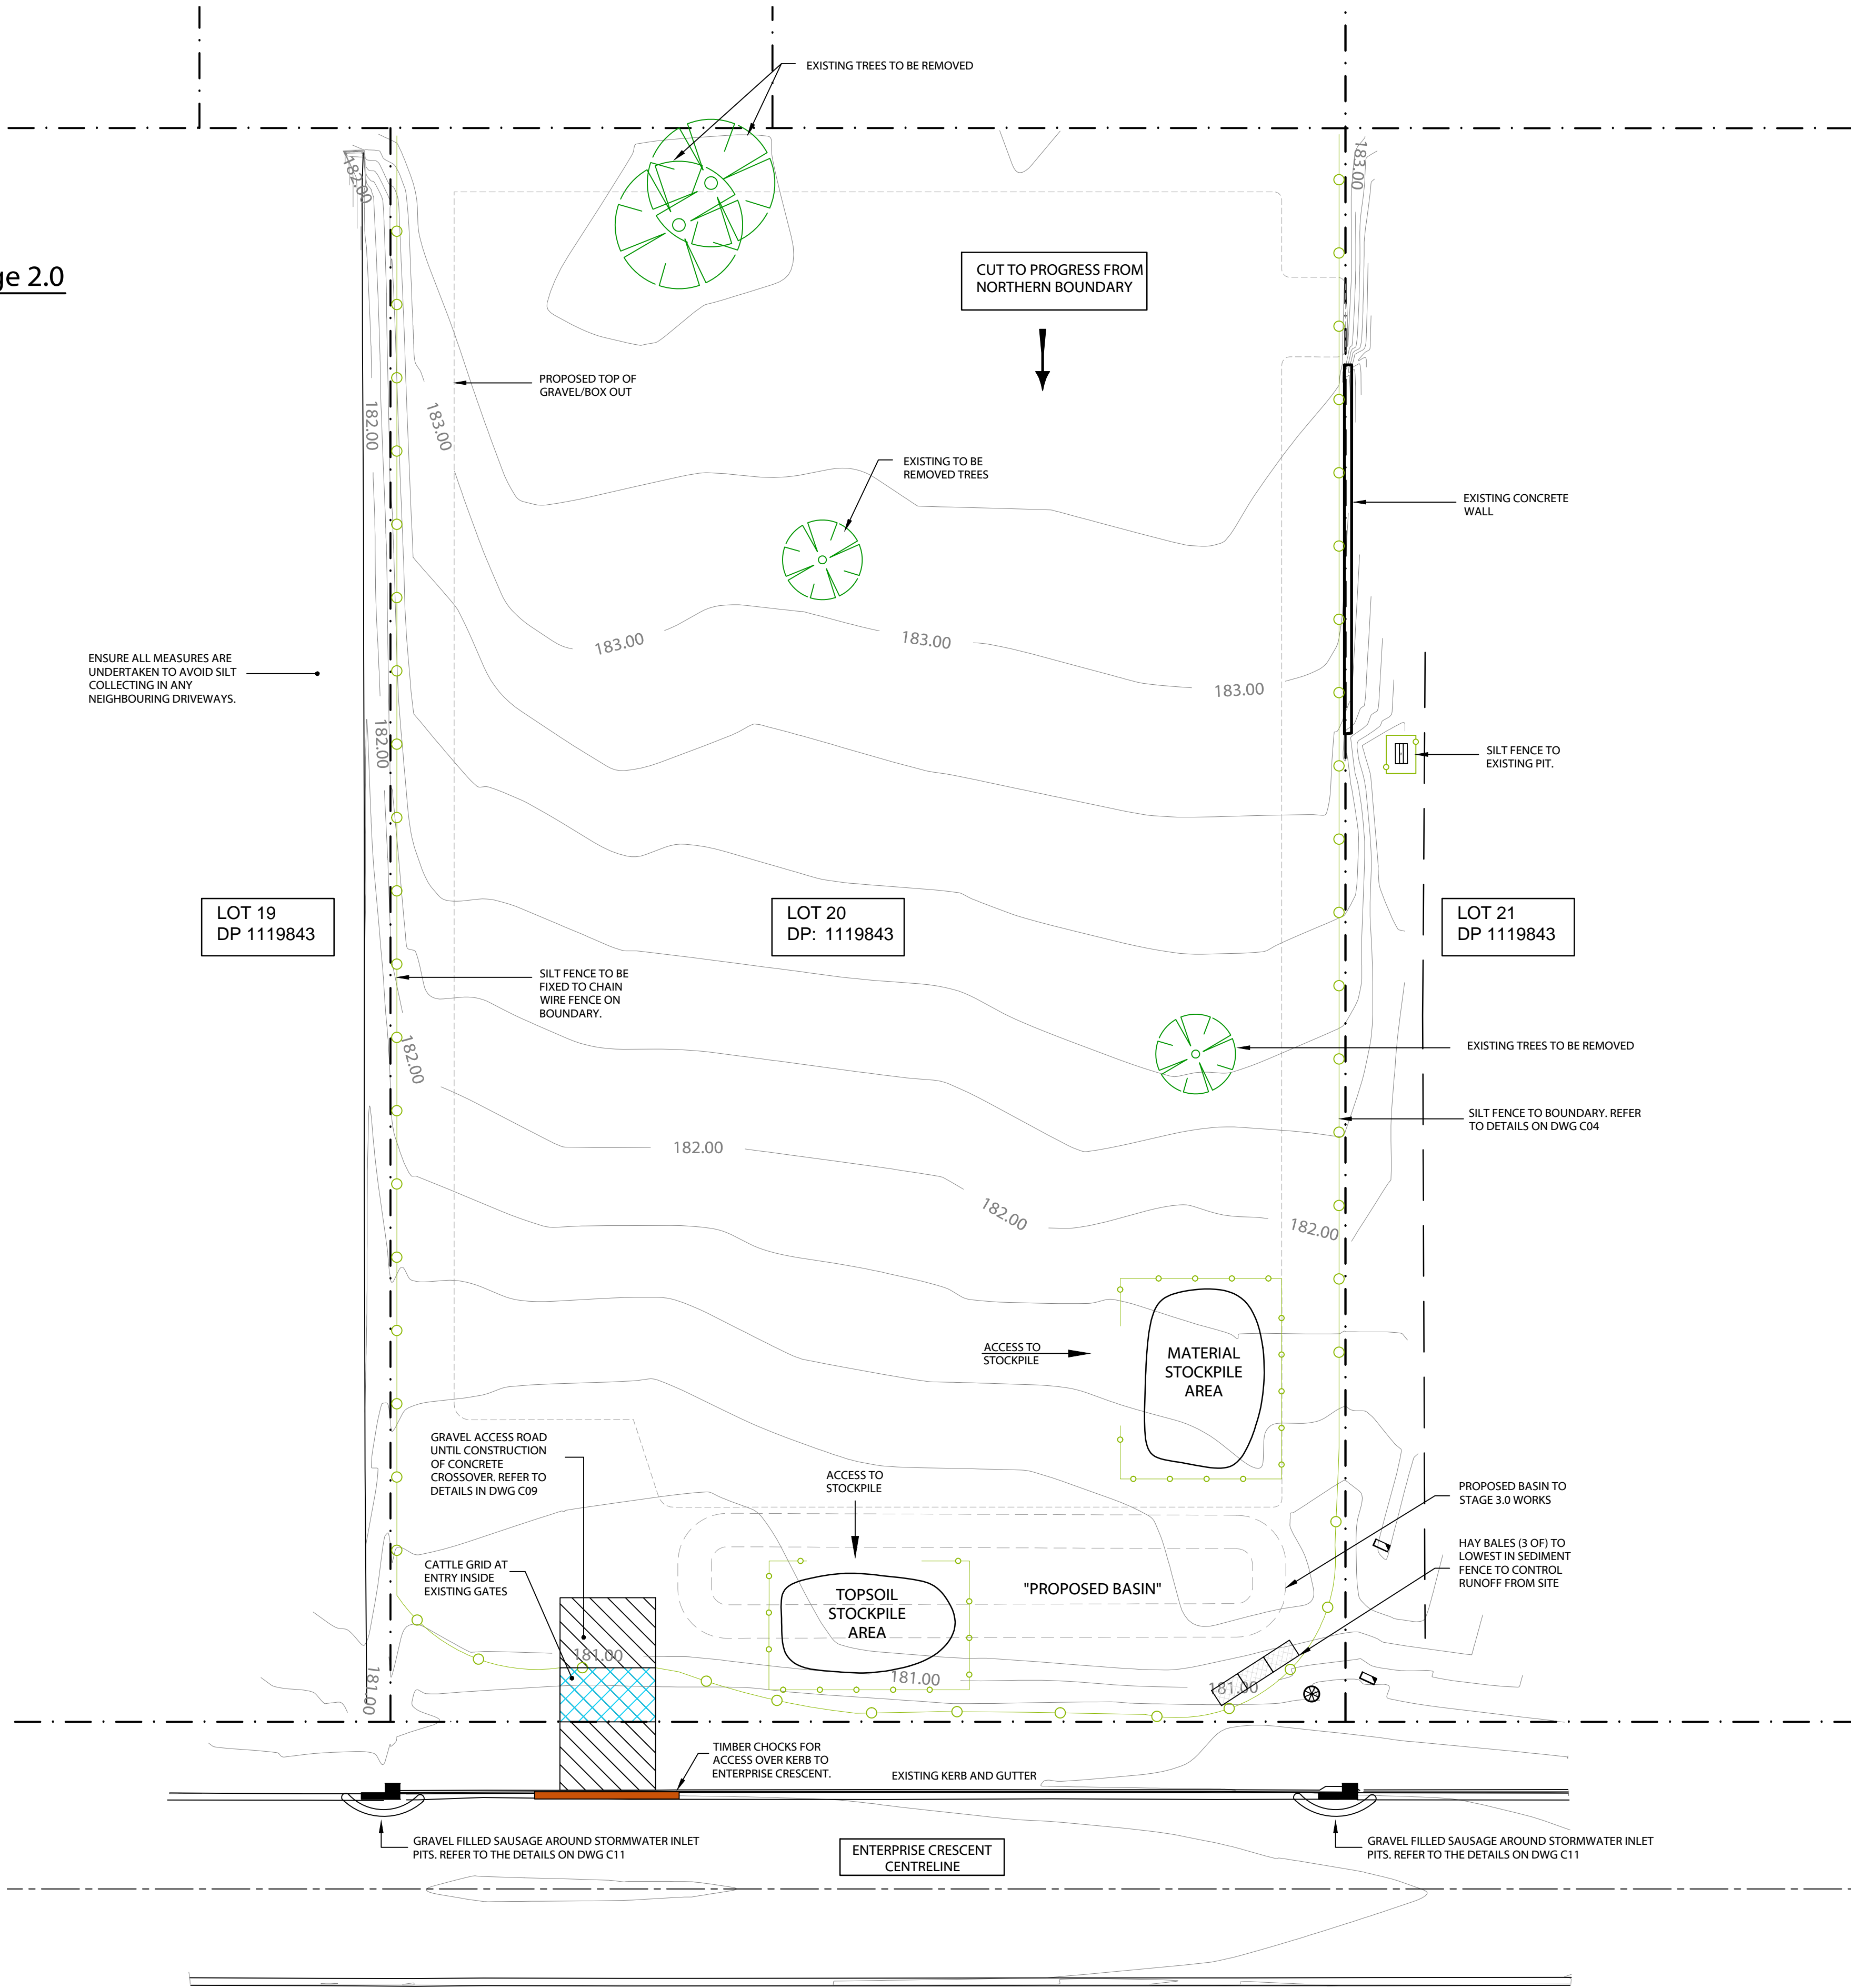
SUGGESTED CONSTRUCTION PHASE TO INCLUDE

- STAGE 1.0
- a. CONSTRUCT TEMPORARY CROSSOVER WITH TIMBER BOARDS, KERB AT EXISTING ENTRY.
  - b. INSTALL TEMPORARY GRAVEL DRIVEWAY.
  - c. INSTALL CATTLE GRID AT ENTRY.
  - d. INSTALL SEDIMENTATION AND EROSION CONTROLS AS PER DRAWING.



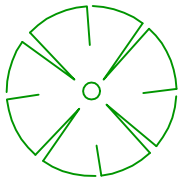
- STAGE 2.0
- a. REMOVE TREES
  - b. CUT TOPSOIL TO STOCKPILE AS SHOWN ON C03.
  - c. CUT SITE TO FILL COMPACT IN 150mm LAYERS TO DETAILS. CUT TO COMMENCE AT NORTHERN END OF THE LOT.

MAINTAIN EXISTING 2x3m GATE AT CURRENT LOCATION UNTIL DRIVEWAY IS COMPLETED

ENSURE ALL MEASURES ARE UNDERTAKEN TO AVOID SILT COLLECTING IN ANY NEIGHBOURING DRIVEWAYS.



LEGEND:

-  DENOTES SILT FENCE. REFER TO DETAILS.
-  DENOTES GRAVEL FILLED SOCKETS TO STORMWATER INLET PITS WITHIN ENTERPRISE CRESCENT.
-  DENOTES TREES TO BE REMOVED

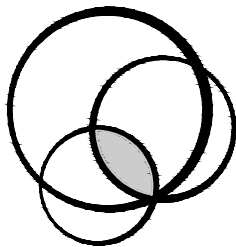
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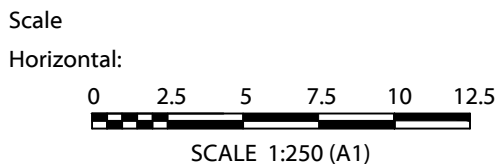
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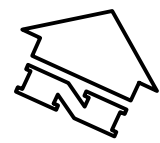


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ABN 82 153 018 800

SEDIMENTATION AND  
EROSION PLAN  
STAGE 1.0 - 2.0 WORKS



CIVIL DRAWING					
Designed	BH	Approved on behalf of RHM Consulting Engineers		05/08/20	
Drawn	JP	Project Engineer/Director		Date	
Datum	NIL	Drawing No:		Rev	
Date	JULY 20	19-027-C03		C	



CONSTRUCTION PHASE - Stage 3.0 to Stage 4.0

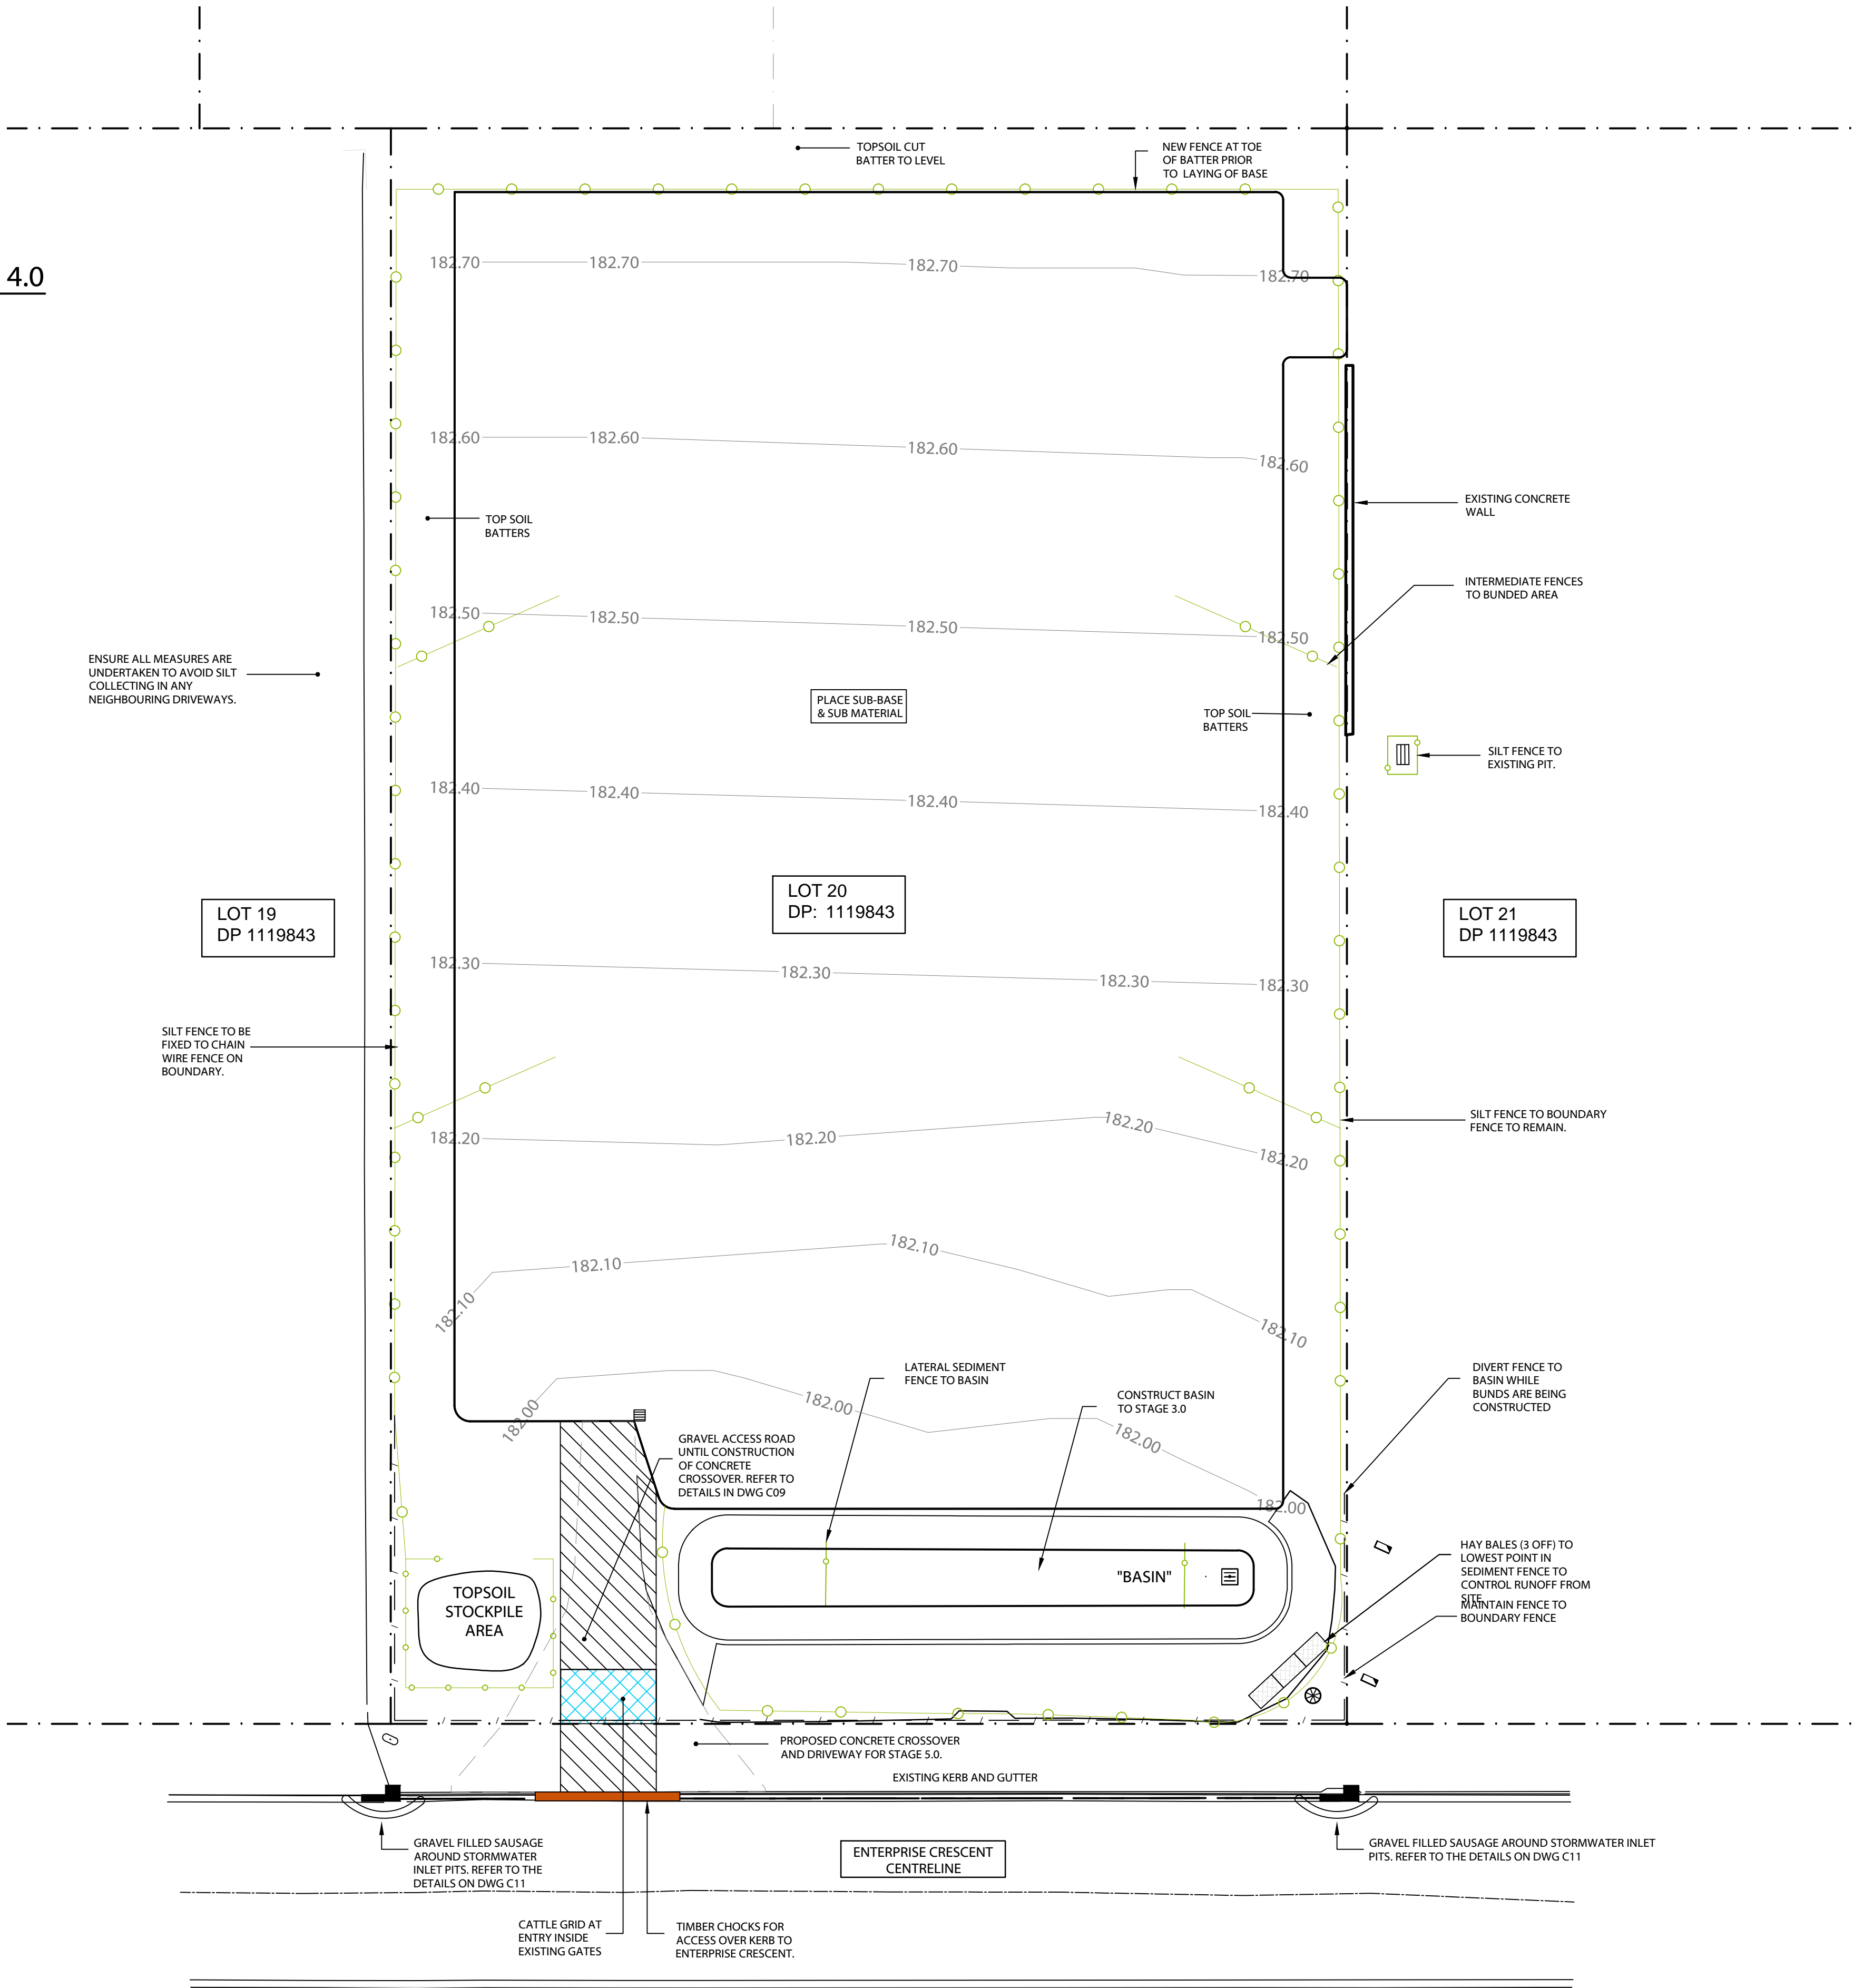
SUGGESTED CONSTRUCTION PHASE TO INCLUDE

- STAGE 3.0
- a. REMOVE TOP SOIL FROM STOCKPILE AND PLACE ON BATTERS
  - b. RELOCATE TOP SOIL STOCKPILE AS SHOWN
  - c. LAY Ø225 OUTLET PIPE AND PIT AT BASIN
  - d. LAY Ø150 OUT PIPE, PIT AND TRENCH GRATE ACCESS DRIVEWAY.
  - e. CONSTRUCT DETENTION BASIN WITH SURPLUS CUT

- STAGE 4.0
- a. PLACE AND LAY SUB BASE AND BASE MATERIAL
  - b. INSTALL DRAINAGE PITS
  - c. CREATE BUNDS TO PERIMETER
  - d. REINSTATE SEDIMENTATION FENCES TO BASIN AS SHOWN

MAINTAIN EXISTING 2x3m GATE AT CURRENT LOCATION UNTIL DRIVEWAY IS COMPLETED

ENSURE ALL MEASURES ARE UNDERTAKEN TO AVOID SILT COLLECTING IN ANY NEIGHBOURING DRIVEWAYS.



LEGEND:

- DENOTES SILT FENCE. REFER TO DETAILS.
- DENOTES GRAVEL FILLED SOCKETS TO STORMWATER INLET PITS WITHIN ENTERPRISE CRESCENT.
- CATTLE GRID
- TEMPORARY GRAVEL ACCESS DRIVEWAY

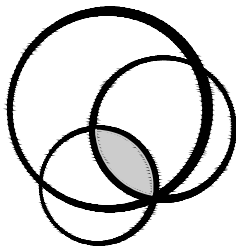
MUSWELLBROOK SHIRE COUNCIL  
DEVELOPMENT CONSENT  
This document forms part of  
Council's Notice of Determination  
  
DA 2020-22  
Approval Date: 22-Sep-20  
Delegated Officer: ALISA EVANS

REV	DESCRIPTION	DATE	BY	REV	DESCRIPTION	DATE	BY
A	ISSUED FOR APPROVAL.	05/08/20	CH				

WILLFAB SUPERFUND  
c/o GRAEME RAY  
PO BOX 136  
LAMBTON, NSW, 2099

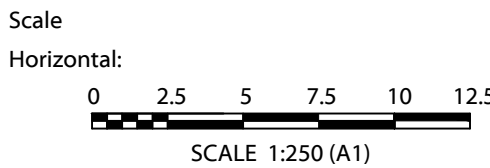
PROPOSED HARDSTAND  
38-40 ENTERPRISE CRESCENT  
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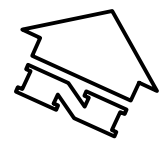
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SEDIMENTATION AND  
EROSION PLAN  
STAGE 3.0 - 4.0 WORKS



CIVIL DRAWING					
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Datum	NIL	Drawing No:		Rev	
Date	JULY 20	19-027-C03.1		A	





CONSTRUCTION PHASE - Stage 5.0

SUGGESTED CONSTRUCTION PHASE TO INCLUDE

- STAGE 5.0
- a. CONSTRUCT CONCRETE DRIVEWAY
  - b. CONSTRUCT CONCRETE CROSSOVER
  - c. SPREAD TOP SOIL TO DETENTION BATTERS
  - d. UNDERTAKE LANDSCAPING
  - e. CONSTRUCT INTERNAL RAMP

NOTE:

- 1. SEDIMENT FENCE TO REMAIN UNTIL LANDSCAPE IS ESTABLISHED

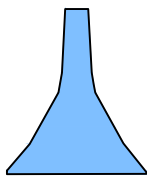
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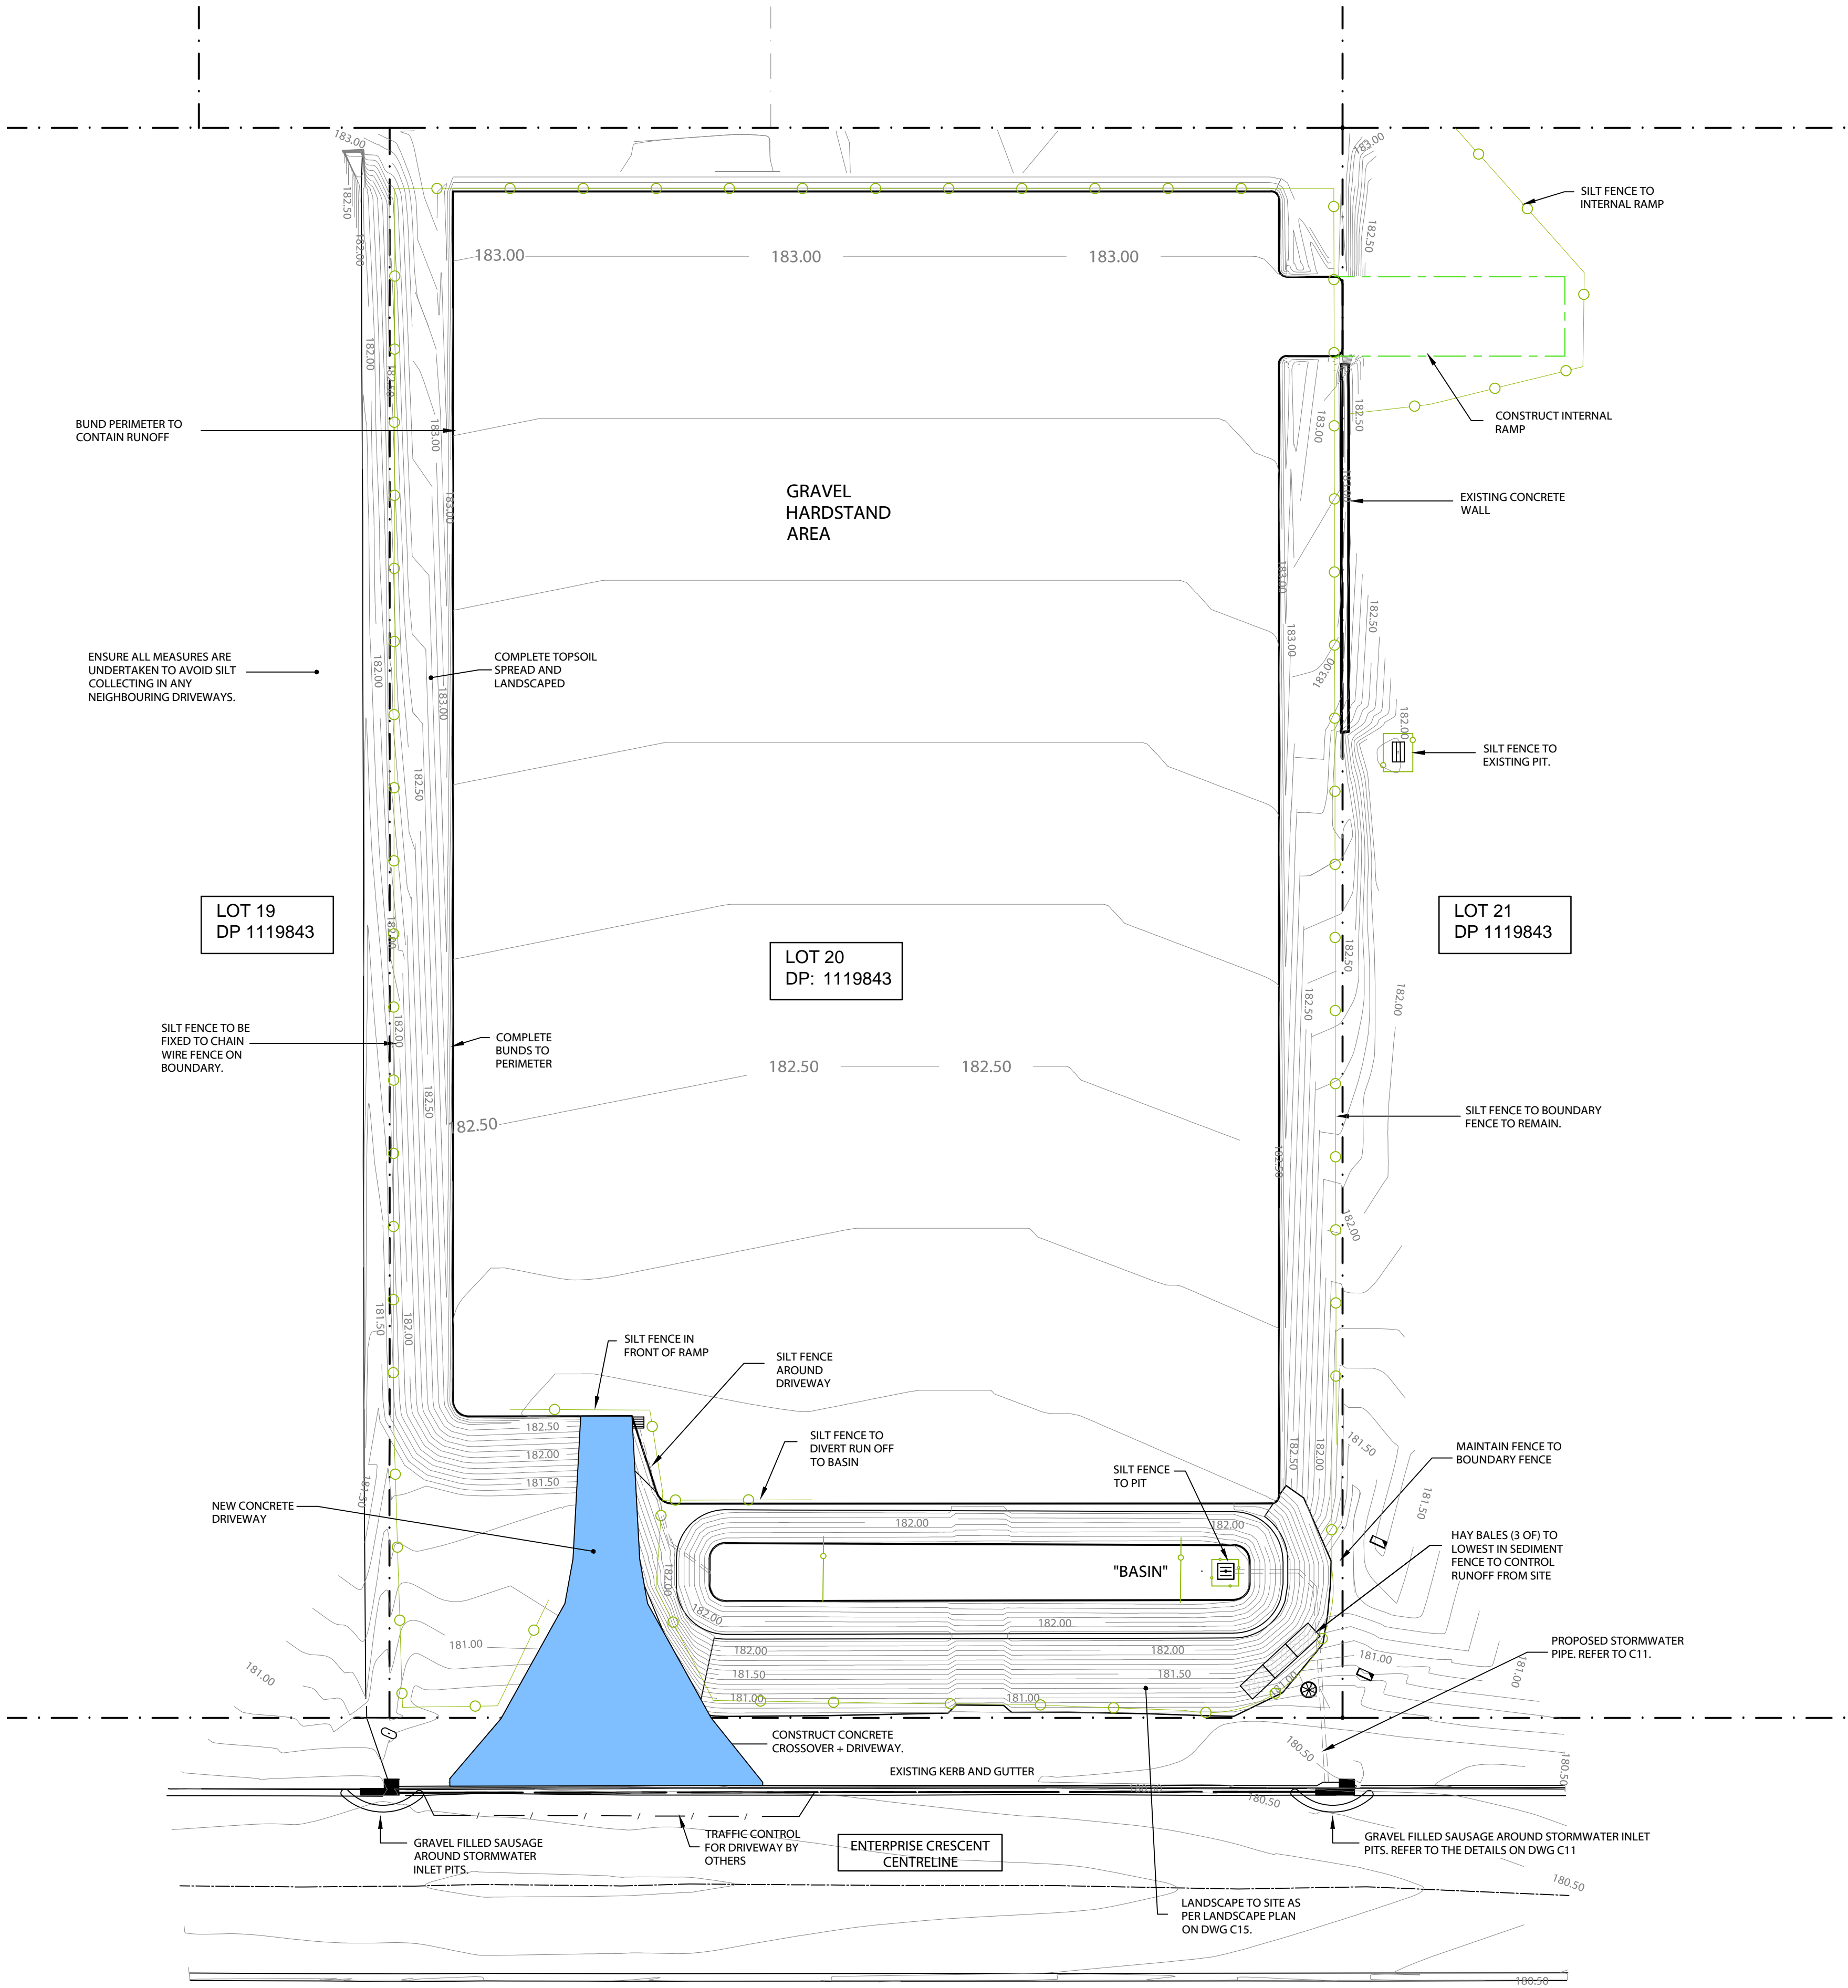
DENOTES SILT FENCE. REFER TO DETAILS.



DENOTES GRAVEL FILLED SOCKETS TO STORMWATER INLET PITS WITHIN ENTERPRISE CRESCENT.



DENOTES NEW DRIVEWAY SLAB



MUSWELLBROOK SHIRE COUNCIL  
DEVELOPMENT CONSENT  
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DA 2020-22  
Approval Date: 22-Sep-20

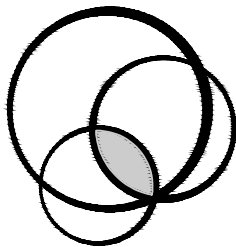
Delegated Officer: ALISA EVANS

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A	ISSUED FOR APPROVAL.	05/08/20	CH				

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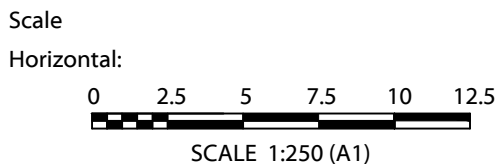
PROPOSED HARDSTAND  
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ABN 82 153 018 800

SEDIMENTATION AND  
EROSION PLAN  
STAGE 5.0 WORKS



CIVIL DRAWING					
Designed	BH	Approved on behalf of RHM Consulting Engineers		05/08/20	
Drawn	CH	Project Engineer/Director		Date	
Datum	NIL	Drawing No:		Rev	
Date	JULY 20	19-027-C03.2		A	









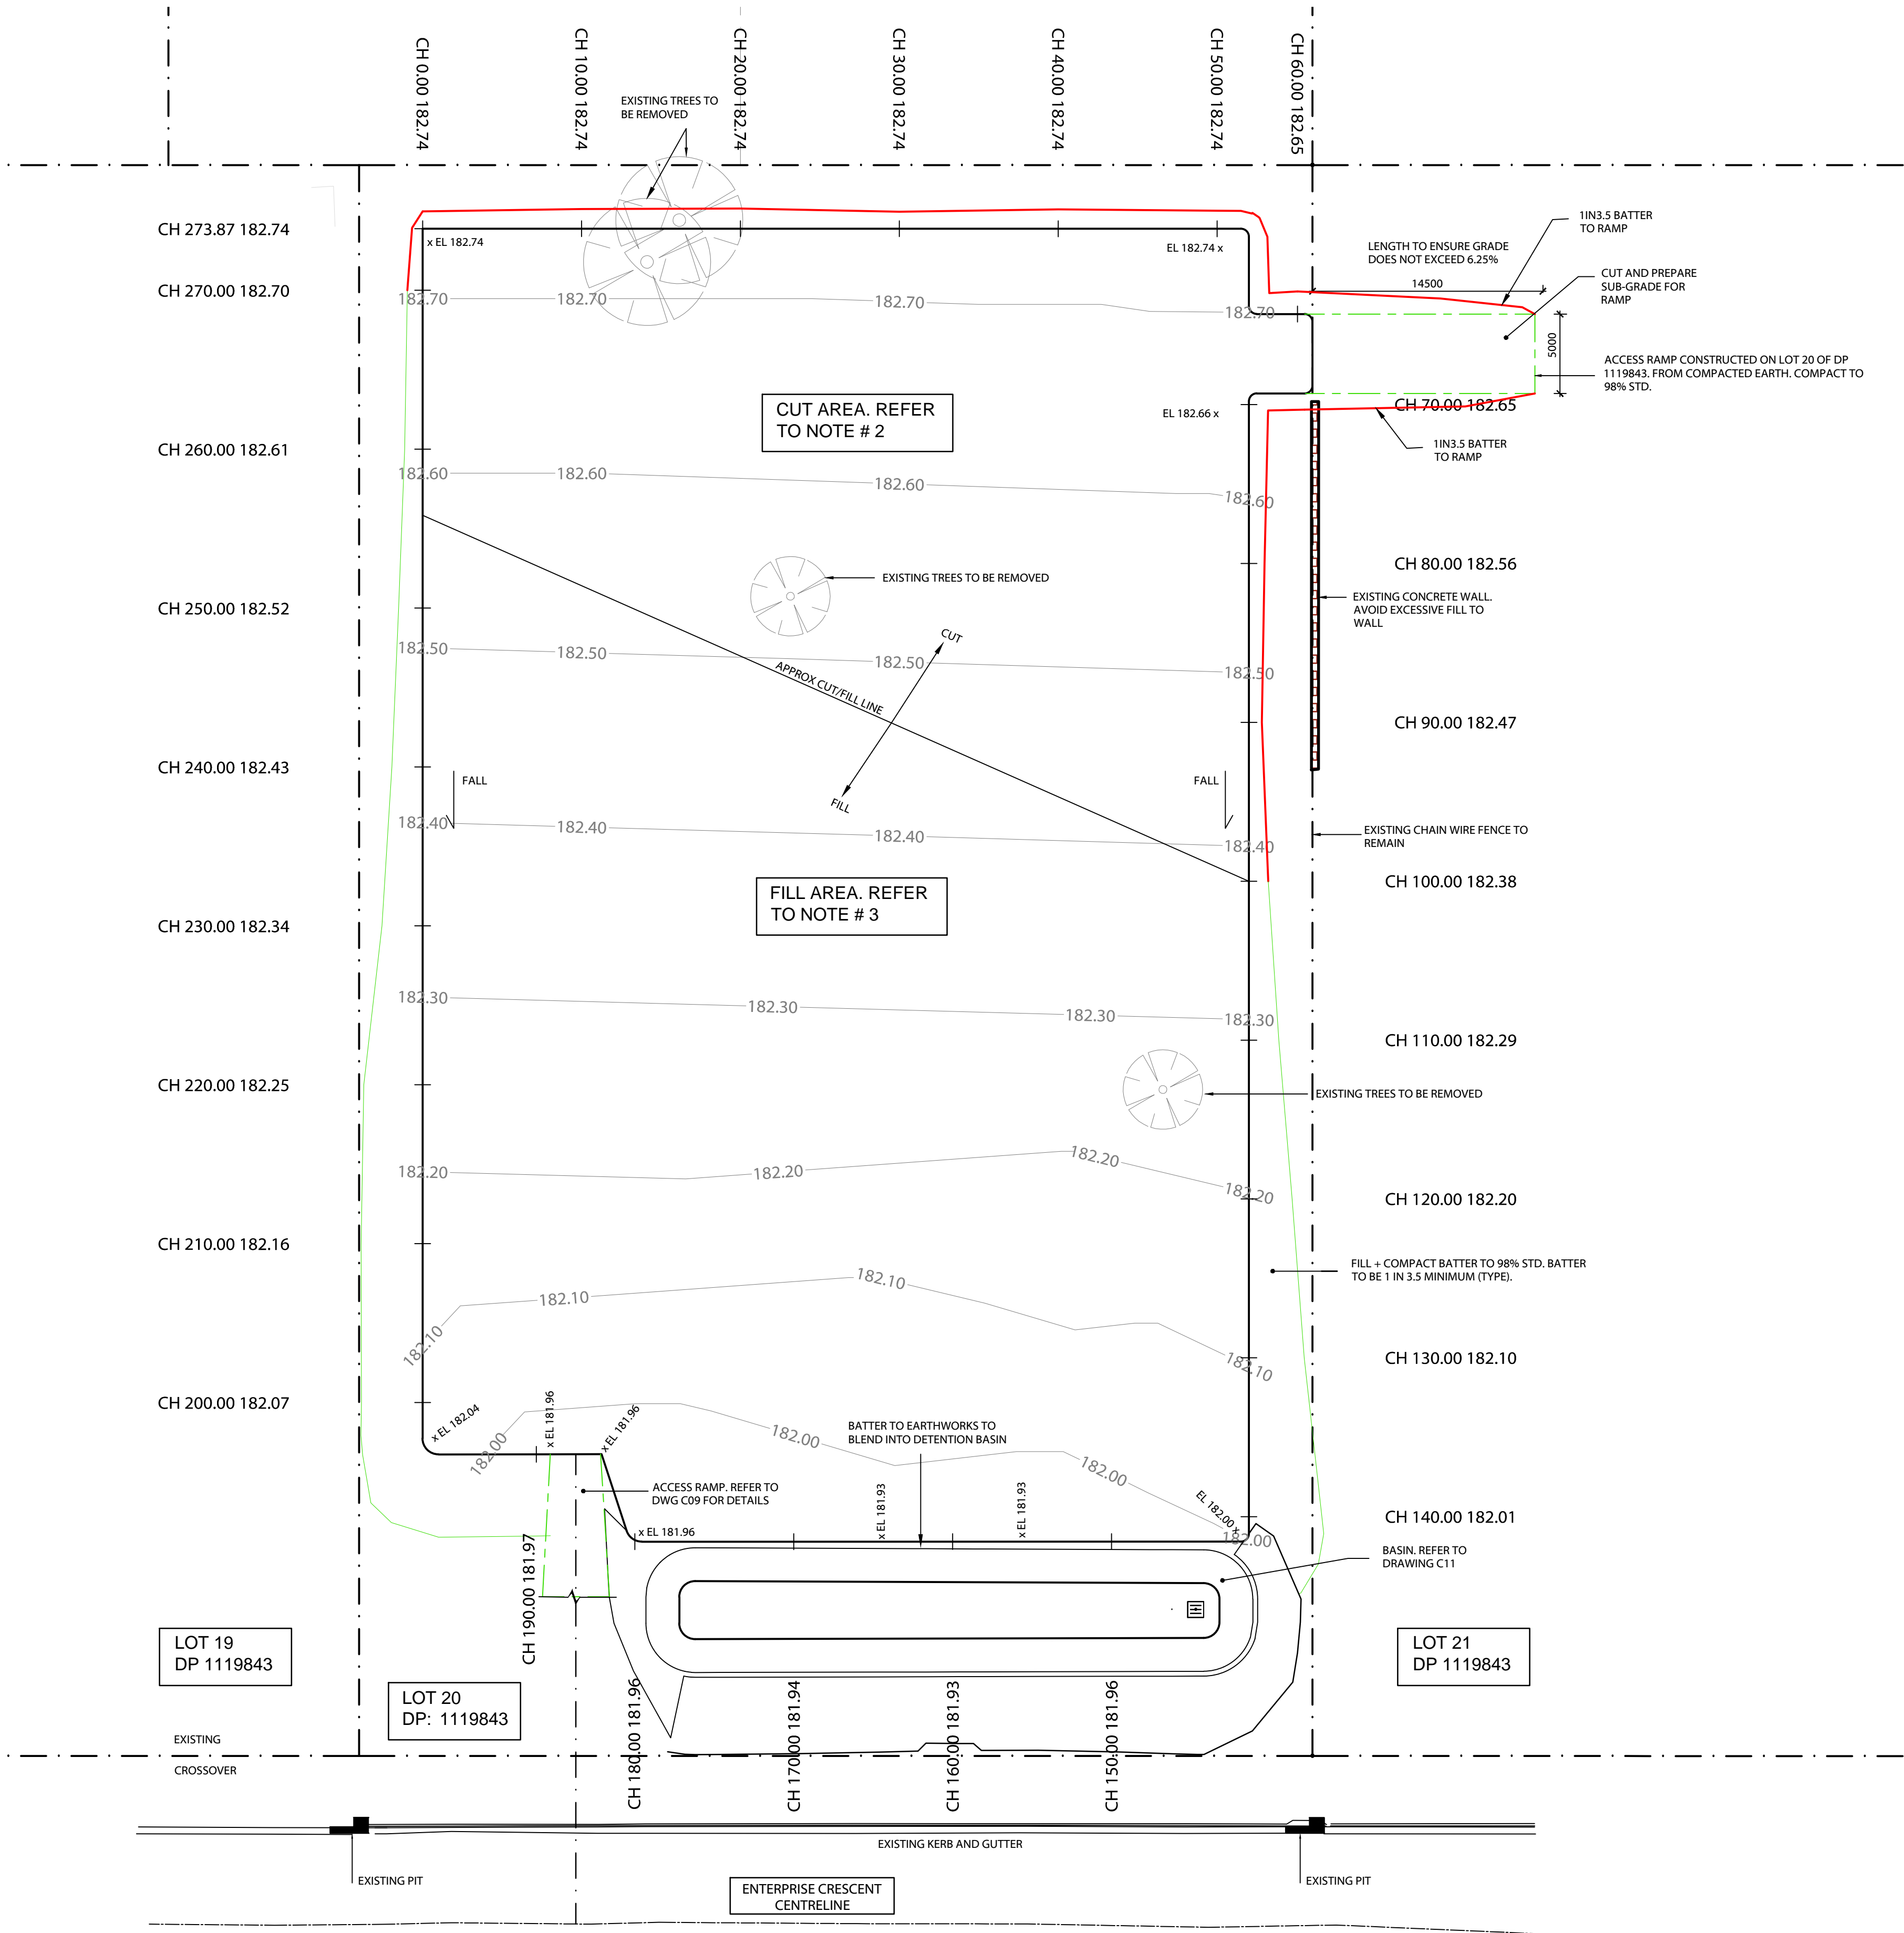
- EARTHWORK NOTES:
- LEVELS SHOW REFLECT BOXOUT LEVEL. REFER TO DRAWING C07 FOR HARDSTAND DETAILS.
  - FOR CUT AREA, SCARIFY EXISTING SUB-GRADE TO A DEPTH OF 100mm PROOF ROLL TO REMOVE SOFT SPOTS. MOISTURE CONDITIONS AND COMPACT TO 98% STD. REFER TO DRAWING C07.
  - FOR FILL AREAS, PLACE CUT IN 250mm LAYERS (LOOSE), MOISTURE CONDITION AND COMPACT TO 98% STD. REFER TO DRAWING C07. TOPSOIL TO BE REMOVED PRIOR WITH SUB-GRADE PREPARATION AS PER ITEM 2.0.
  - BATTERS TO BE 1 IN 3.5 UNLESS NOTED OTHERWISE.
  - VEGETATE BATTERS AS REQUIRED. REFER TO LANDSCAPE PLANS.

EARTHWORKS QUANTITIES

- EXISTING SURFACE TO SUB-GRADE INCLUDES BATTER, BASIN AND ACCESS RAMP.  
CUT = 530m<sup>3</sup>  
FILL = 300m<sup>3</sup>  
(NO BULKING FACTORS)
- SUB-GRADE TO TOP OF GRAVEL.  
IMPORTED GRAVEL MATERIAL = 1275m<sup>3</sup>  
(AREA = 4250m<sup>2</sup>)  
(NO BULKING FACTORS)

NOTE: QUANTITIES ARE ESTIMATES ONLY AND MAY VARY SLIGHTLY.

NOTE: BASED IN 1IN3.5 BATTERS



LEGEND:

- DENOTES TREES TO BE REMOVED
- 182.50 DENOTES EARTHWORKS CONTOURS
- DENOTES PROPOSED INTERNAL ACCESS RAMP CHANGE IN GRADE 6.25%
- DENOTES APPROX EXTENT OF FILL BATTER. BATTER 1IN3.5
- DENOTES APPROX EXTENT OF CUT BATTER. BATTER 1IN3.5

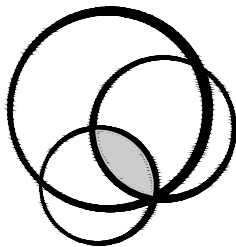
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DA 2020-22  
Approval Date: 22-Sep-20  
Delegated Officer: ALISA EVANS

REV	DESCRIPTION	DATE	BY	REV	DESCRIPTION	DATE	BY
C	GENERAL AMENDMENTS	31/07/20	CH				
B	INCREASED HARDSTAND AREA	04/02/20	BC				
A	ISSUED FOR APPROVAL	10/01/20	JP				

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c/o GRAEME RAY  
PO BOX 136  
LAMBTON, NSW, 2099

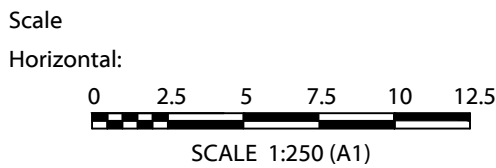
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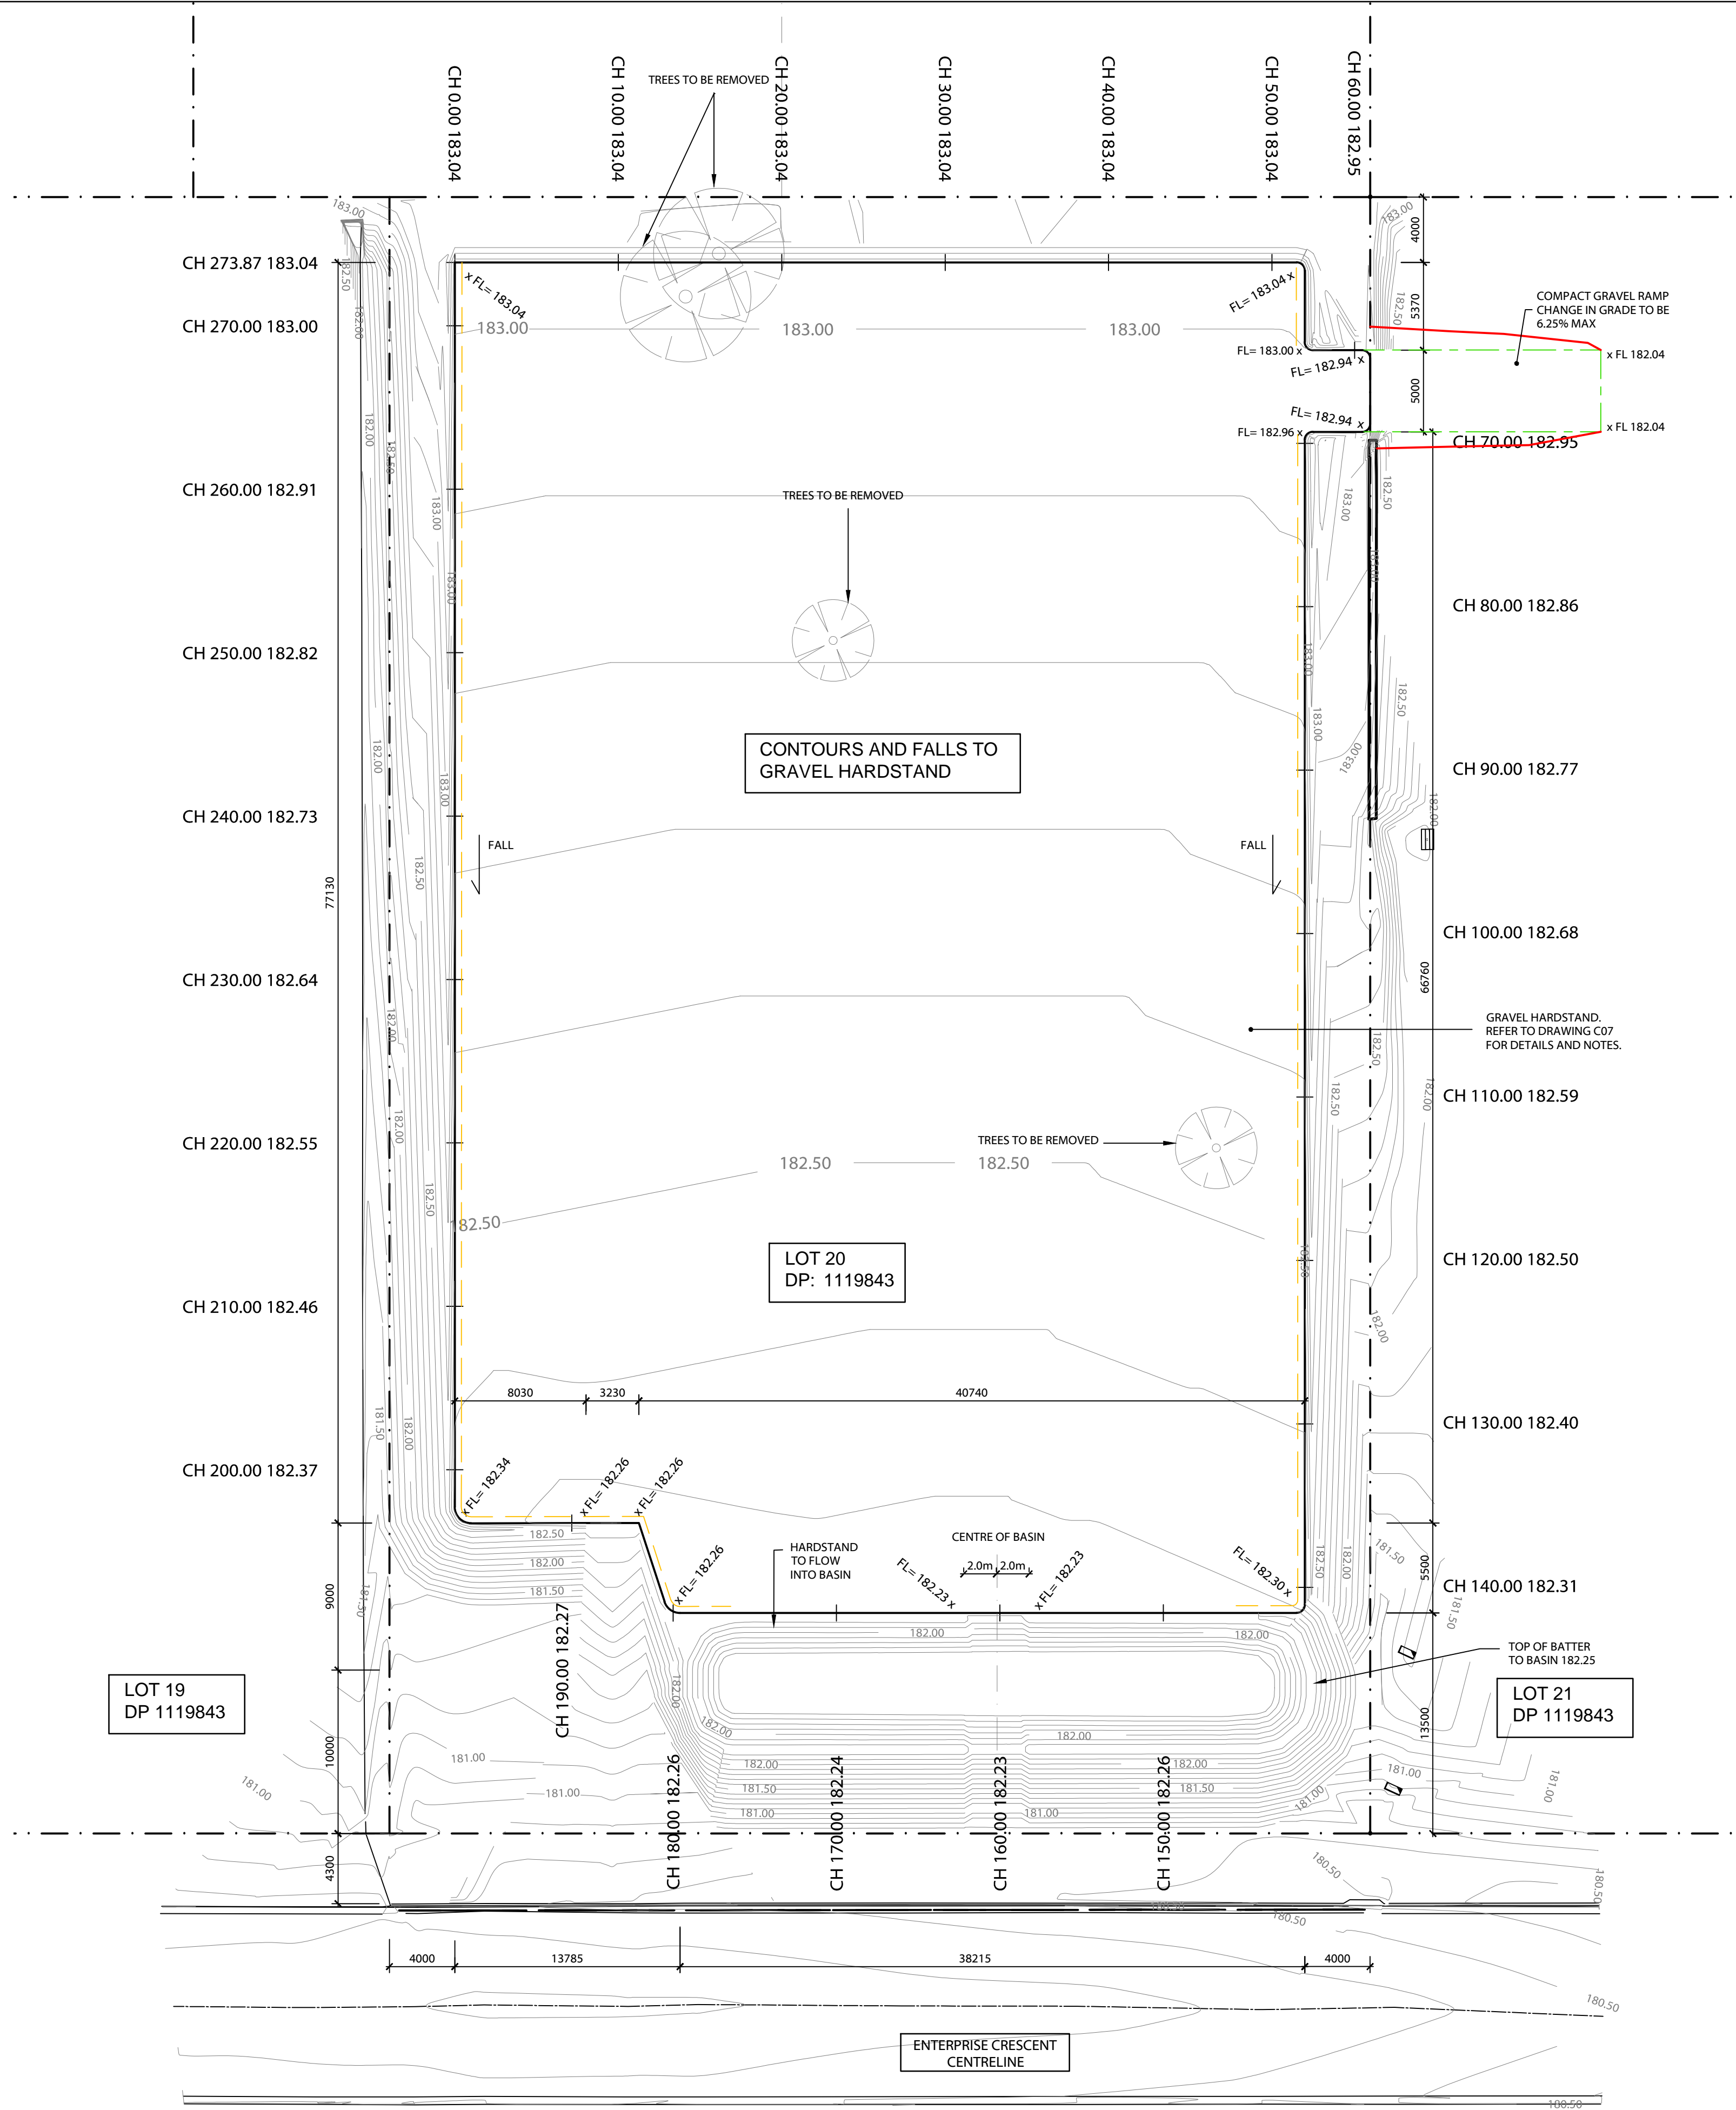
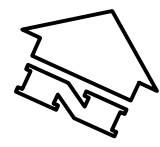
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ABN 82 153 018 800

PROPOSED EARTHWORKS  
PLAN



CIVIL DRAWING			
Designed	BH	Approved on behalf of RHM Consulting Engineers	31/07/20
Drawn	CH	Project Engineer/Director	Date
Datum	NIL	Drawing No:	Rev
Date	JULY 20	19-027-C05	C





LEGEND:



DENOTES TREES TO BE REMOVED

182.50

DENOTES EARTHWORKS CONTOURS

182.50

DENOTES EXTENT OF BUND TO PERIMETER OF HARDSTAND. REFER OT C07

REFER TO BATTER SECTIONS ON C06.1 & C06.2

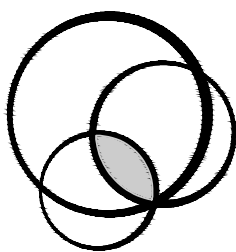
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DEVELOPMENT CONSENT  
This document forms part of  
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DA 2020-22  
Approval Date: 22-Sep-20  
Delegated Officer: ALISA EVANS

REV	DESCRIPTION	DATE	BY	REV	DESCRIPTION	DATE	BY
D	GENERAL AMENDMENTS	05/08/20	CH				
C	GENERAL AMENDMENTS	16/06/20	CH				
B	INCREASED HARDSTAND AREA.	04/02/20	BC				
A	ISSUED FOR APPROVAL.	10/01/20	JP				

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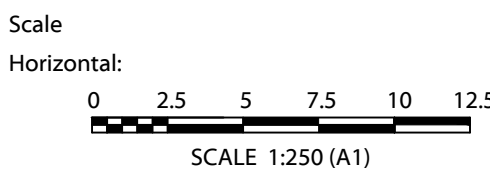
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ABN 82 153 018 800

PROPOSED GRAVEL  
PLAN AND LEVELS



CIVIL DRAWING					
Designed	BH	Approved on behalf of RHM Consulting Engineers		05/08/20	
Drawn	BC	Project Engineer/Director		Date	
Datum	NIL	Drawing No:		Rev	
Date	JULY 20	19-027-C06		D	

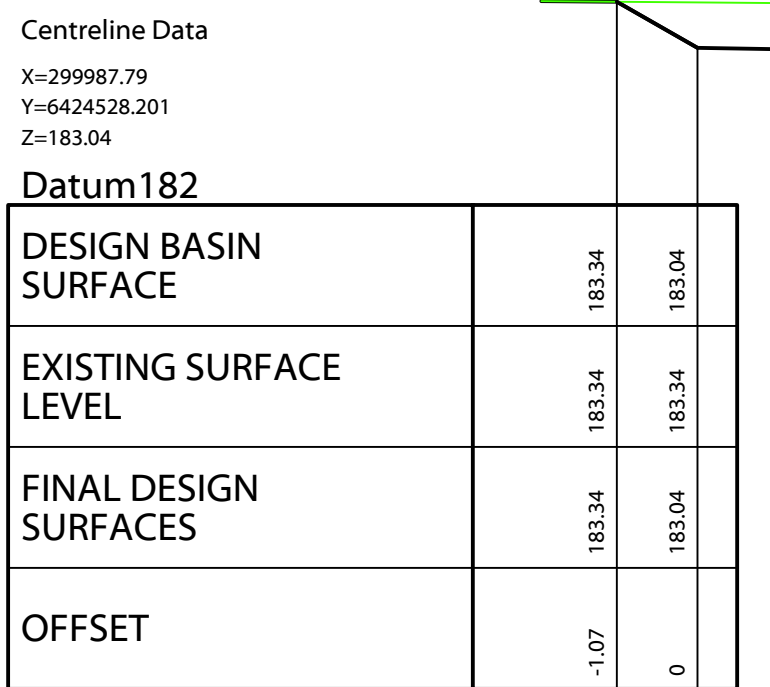


NOTE: ROUND OFF  
PERMANENT BUND

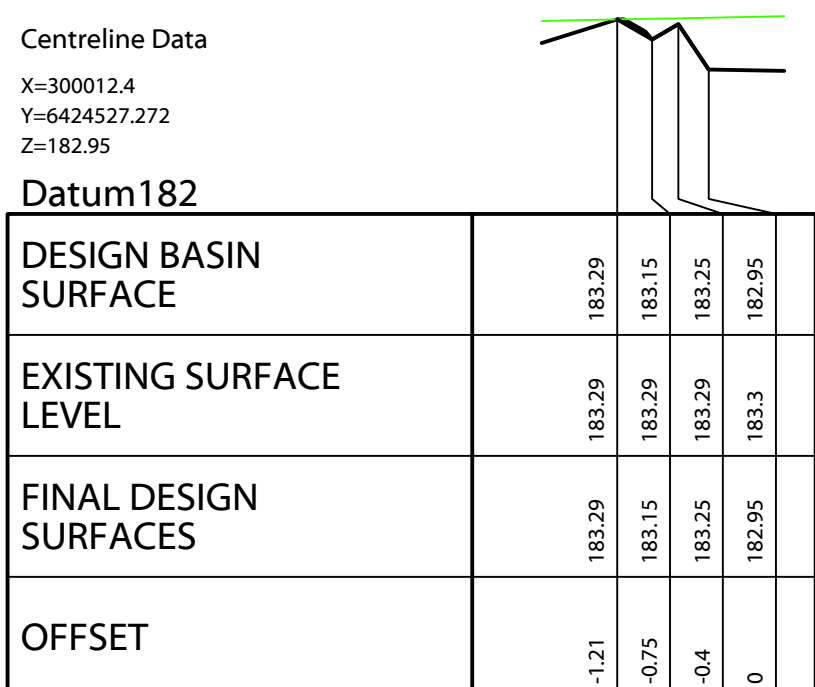
## LEGEND

— : DENOTES FINISH SURFACE  
LEVEL TO HARDSTAND

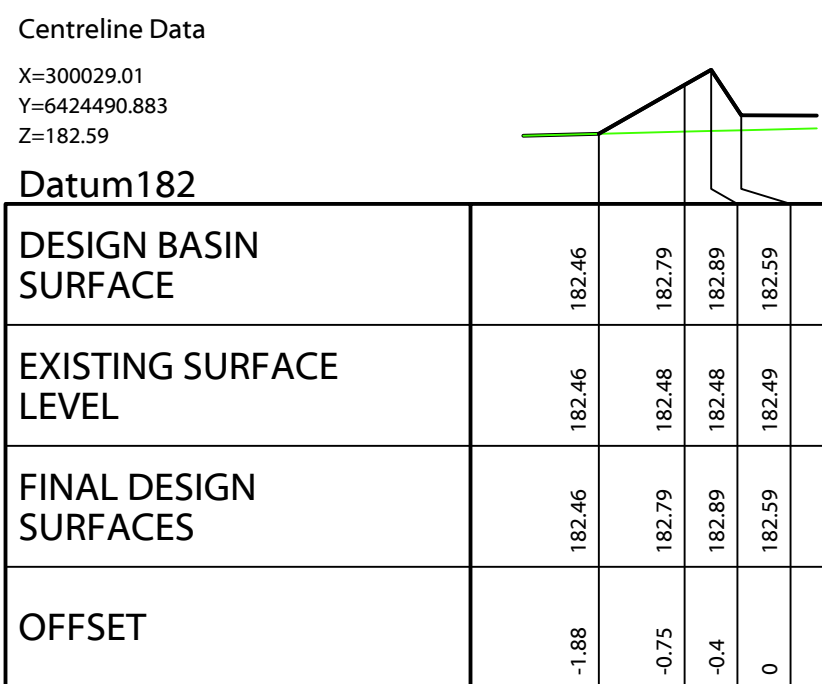
— : DENOTES EXISTING SURFACE LEVEL



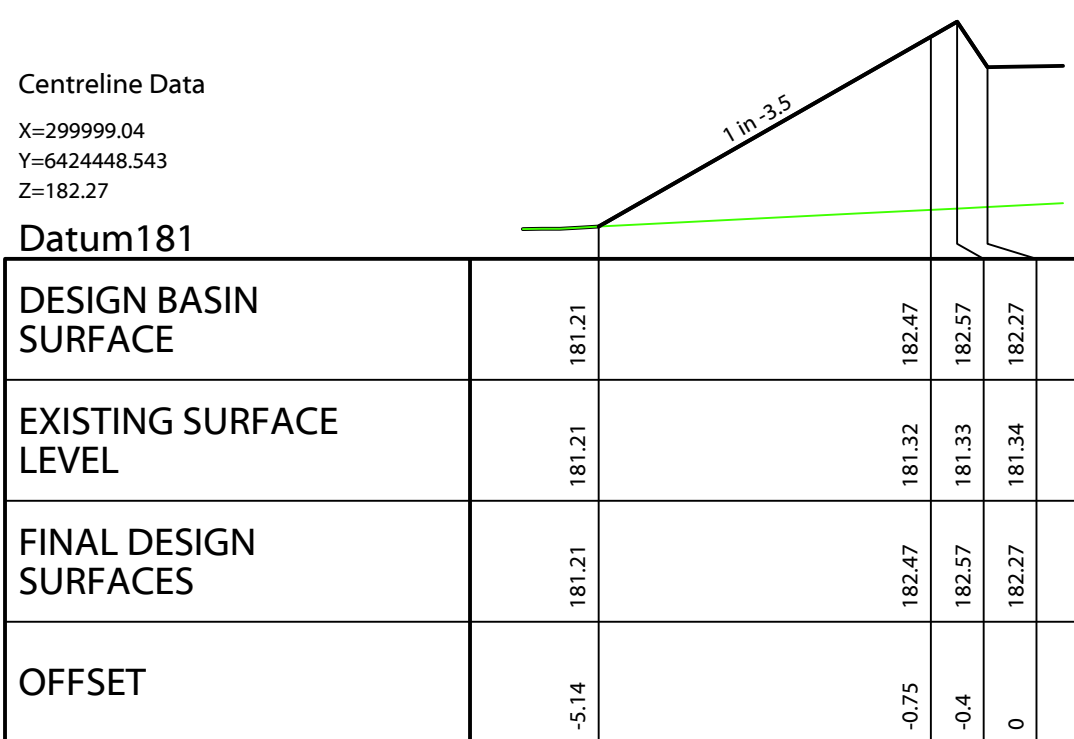
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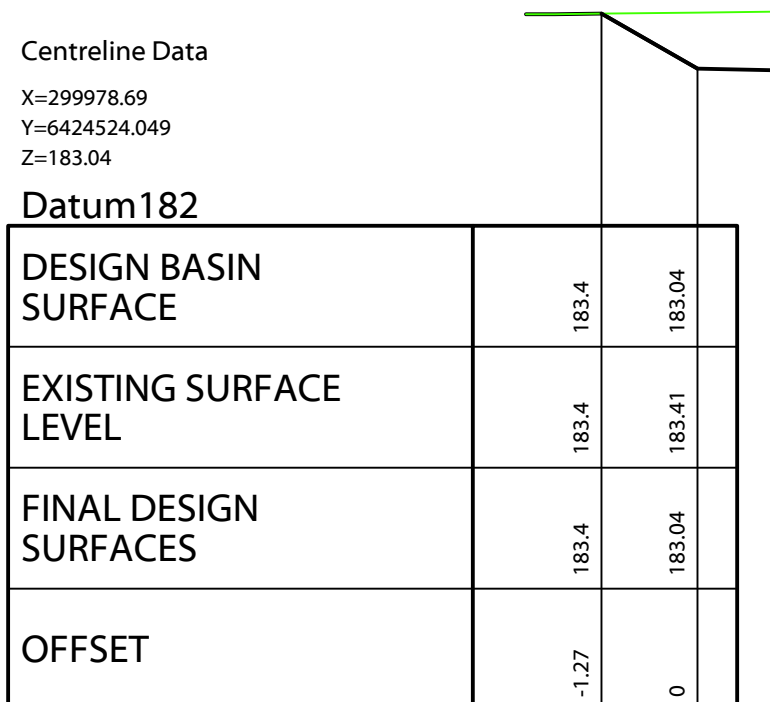
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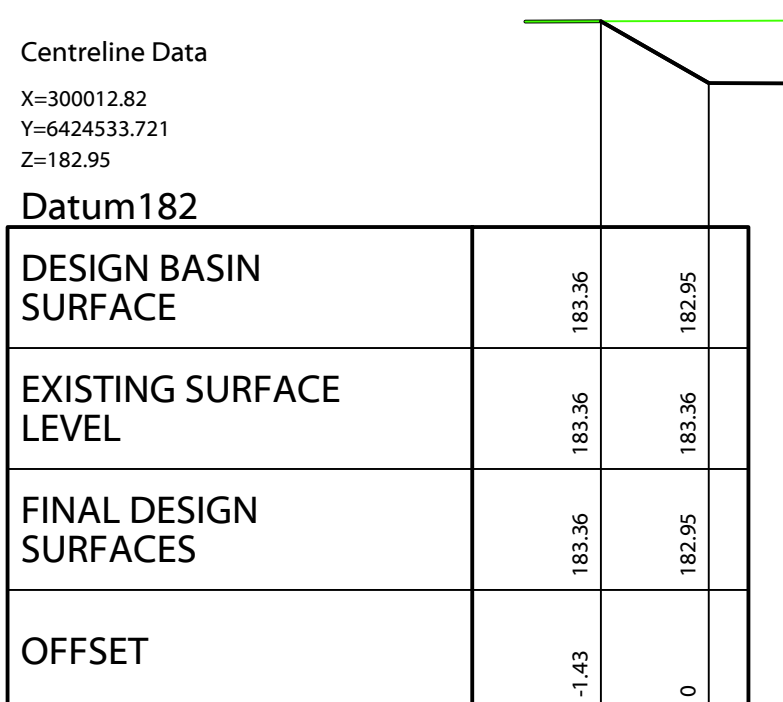
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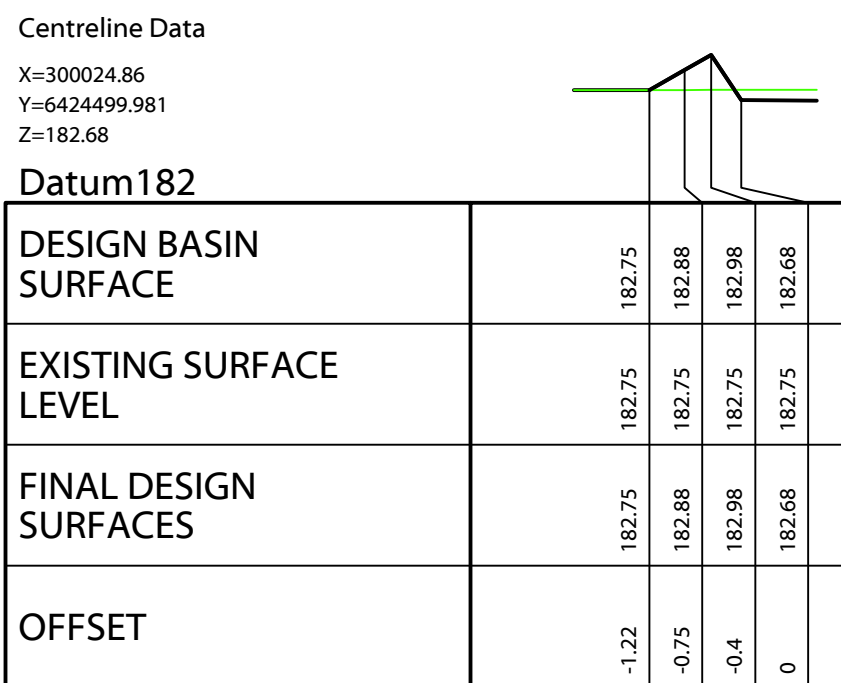
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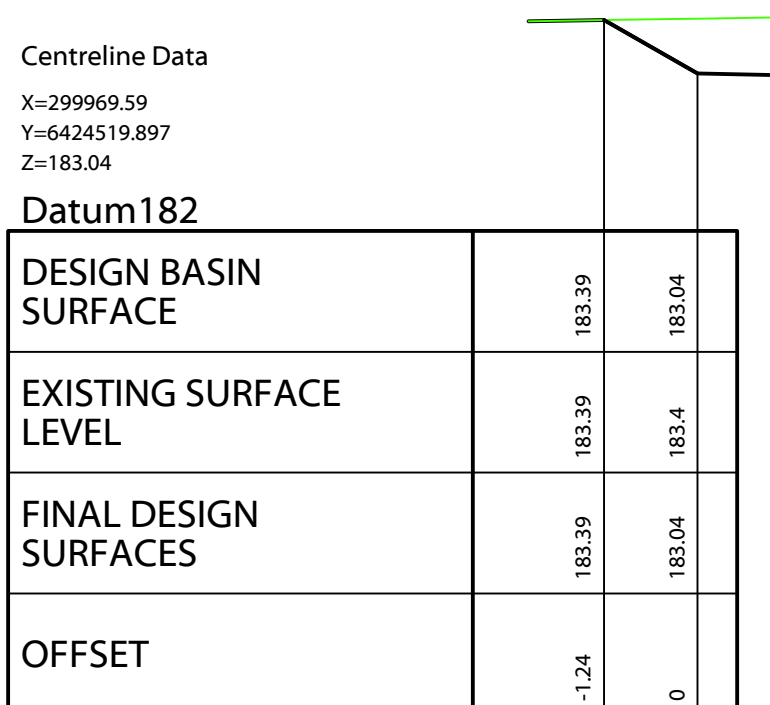
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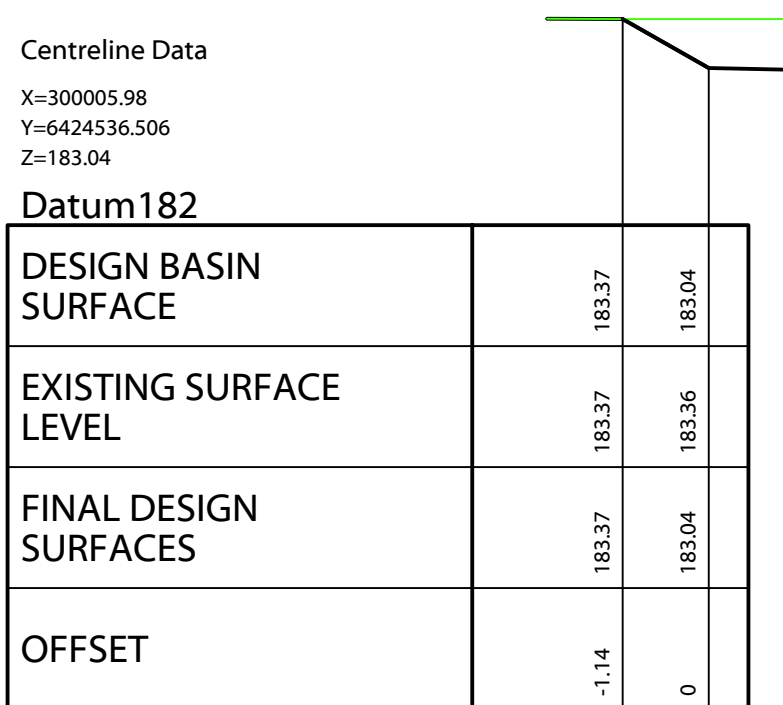
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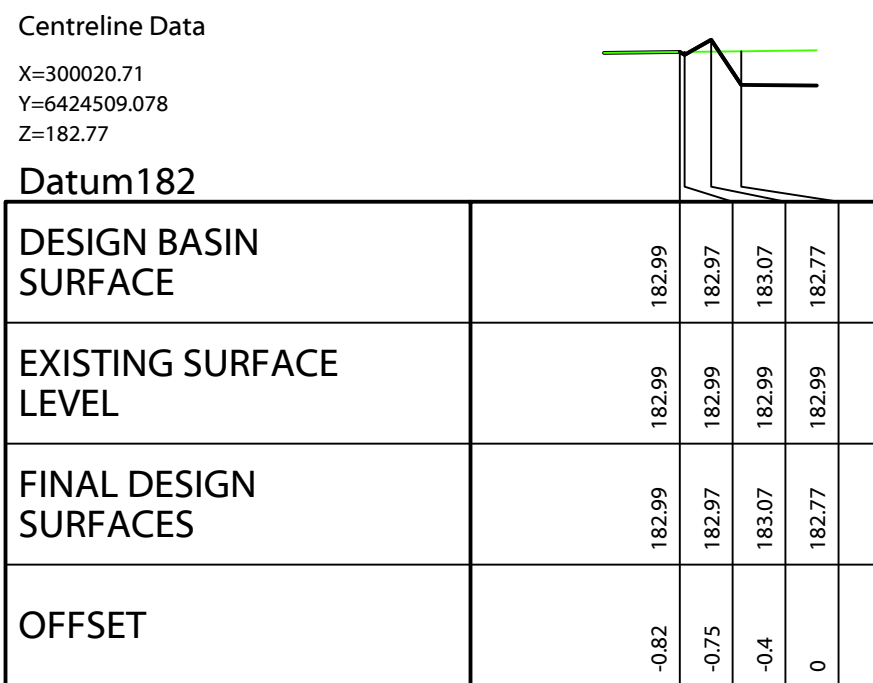
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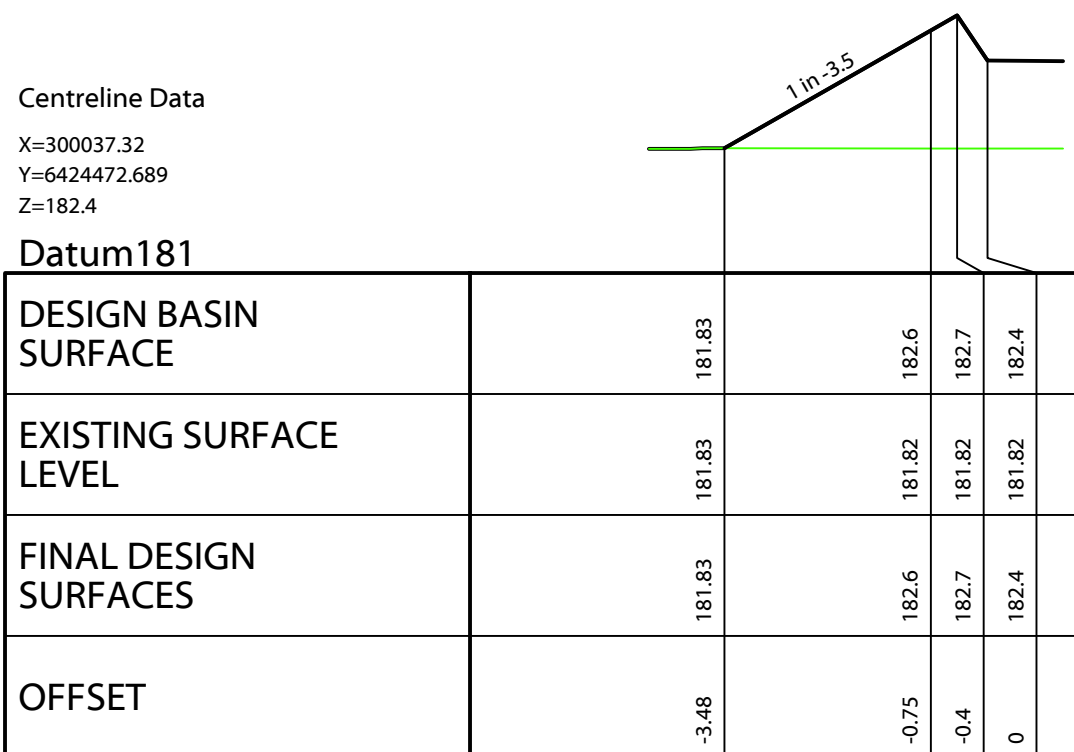
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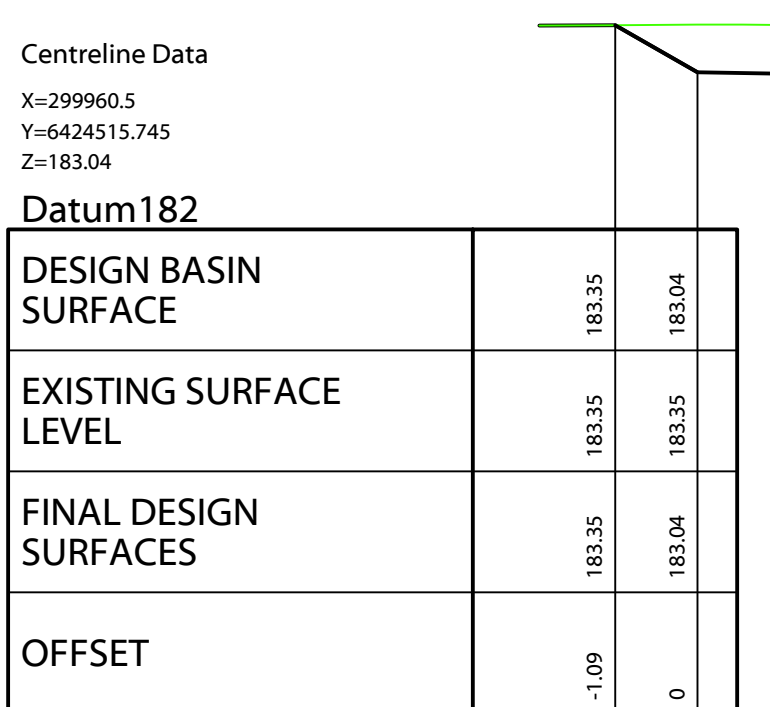
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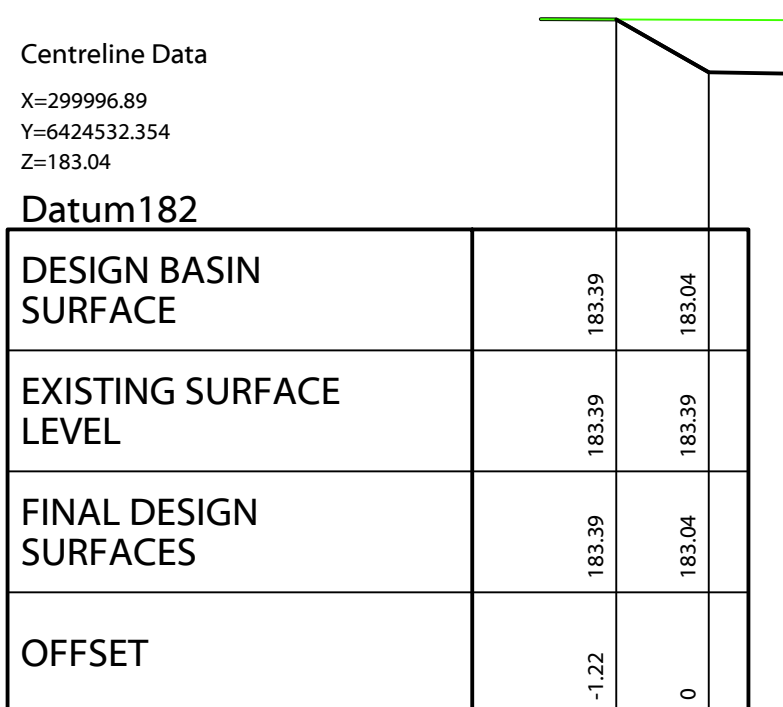
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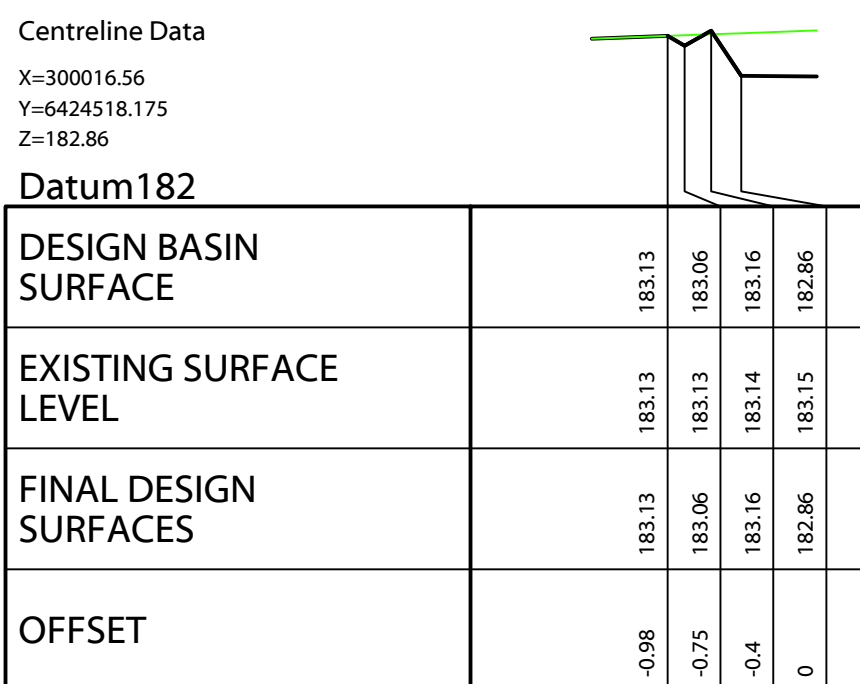
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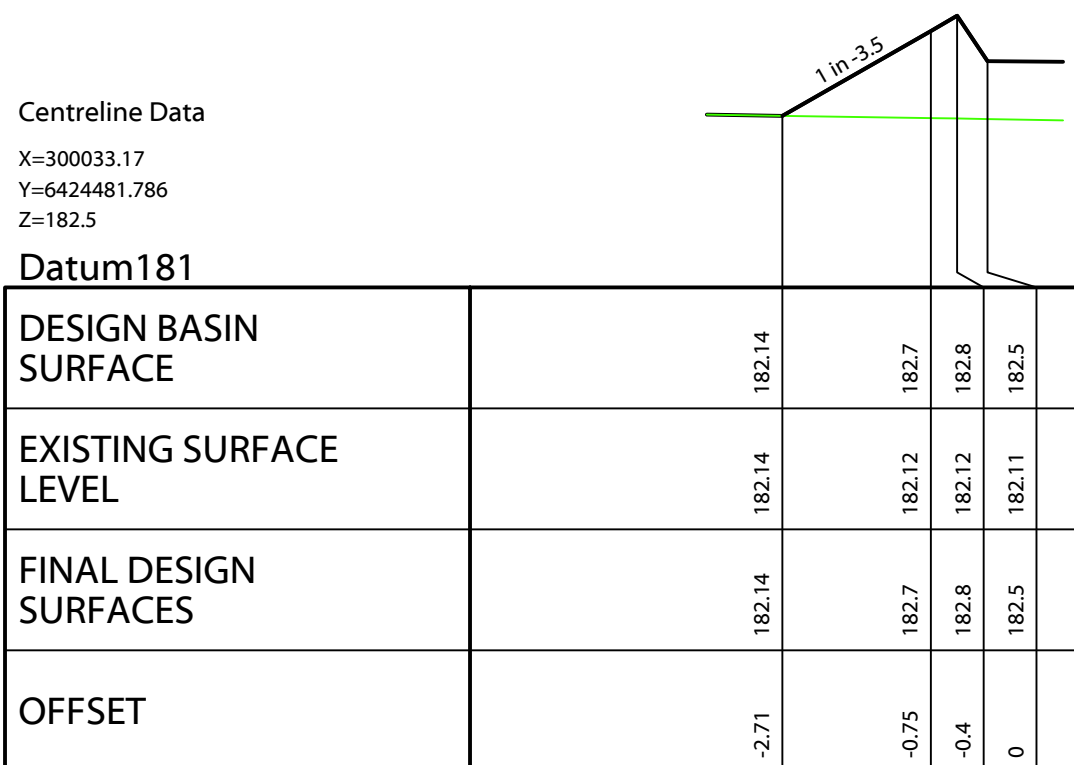
CHAINAGE 0.000



CHAINAGE 40.000



CHAINAGE 80.000



CHAINAGE 120.000

[illegible]



NOTE: ROUND OFF  
PERMANENT BUND

## LEGEND

— : DENOTES FINISH SURFACE  
LEVEL TO HARDSTAND

— : DENOTES EXISTING SURFACE LEVEL

Centreline Data  
X=299978.72  
Y=6424475.831  
Z=182.64

Datum 182					
DESIGN BASIN SURFACE		182.32		182.84	182.64
EXISTING SURFACE LEVEL		182.32	182.41	182.42	182.42
FINAL DESIGN SURFACES		182.32	182.84	182.94	182.64
OFFSET	-2.56		-0.75	-0.4	0

CHAINAGE 230.000

Centreline Data  
X=299982.87  
Y=6424466.734  
Z=182.55

Datum 181					
DESIGN BASIN SURFACE		181.91		182.75	182.85
EXISTING SURFACE LEVEL		181.91	182.08	182.08	182.08
FINAL DESIGN SURFACES		181.91	182.75	182.85	182.55
OFFSET		-3.7	-0.75	-0.4	0

CHAINAGE 220.000

Centreline Data  
X=299987.02  
Y=6424457.637  
Z=182.46

Datum181					
DESIGN BASIN SURFACE	181.62		182.66	182.76	182.46
EXISTING SURFACE LEVEL	181.62		181.75	181.75	181.76
FINAL DESIGN SURFACES	181.62		182.66	182.76	182.46
OFFSET	-4.38		-0.75	-0.4	0

CHAINAGE 210.000

Centreline Data  
X=299991.17  
Y=6424448.539  
Z=182.37

Datum 181				
DESIGN BASIN SURFACE	181.45		182.57	182.67
EXISTING SURFACE LEVEL	181.45		181.44	181.44
FINAL DESIGN SURFACES	181.45		182.57	182.67
OFFSET	-4.66	-0.75	-0.4	0

CHAINAGE 200.000

Centreline Data  
X=299962.11  
Y=6424512.22  
Z=183

Datum 182					
DESIGN BASIN SURFACE		183.26	183.2	183.3	
EXISTING SURFACE LEVEL		183.26	183.28	183.3	183.3
FINAL DESIGN SURFACES		183.26	183.2	183.3	183.3
OFFSET	-0.96 -0.75 -0.4 0				

CHAINAGE 270.000

Centrelines Data

X=299966.26  
Y=6424503.123  
Z=182.91

Datum 182					
DESIGN BASIN SURFACE		183	183.11	183.21	182.91
EXISTING SURFACE LEVEL		183	183.03	183.06	183.08
FINAL DESIGN SURFACES		183	183.11	183.21	182.91
OFFSET		-1.13	-0.75	-0.4	0

CHAINAGE 260.000

Centrelines Data

X=299970.41  
Y=6424494.025  
Z=182.82

Datum 182				
DESIGN BASIN SURFACE		182.81	183.02	183.12
EXISTING SURFACE LEVEL		182.81	182.82	182.83
FINAL DESIGN SURFACES		182.81	183.02	183.12
OFFSET		-1.51	-0.75	-0.4
				0

CHAINAGE 250.000

Centreline Data  
X=299974.56  
Y=6424484.928  
Z=182.73

Datum182				
DESIGN BASIN SURFACE	182.59	182.93	183.03	182.73
EXISTING SURFACE LEVEL	182.59	182.62	182.63	182.64
FINAL DESIGN SURFACES	182.59	182.93	183.03	182.73
OFFSET	-1.94	-0.75	-0.4	0

CHAINAGE 240.000

Centreline Data  
X=299960.5  
Y=6424515.744  
Z=183.04

Datum 182					
DESIGN BASIN SURFACE		183.33	183.24	183.34	183.04
EXISTING SURFACE LEVEL		183.33	183.34	183.35	183.35
FINAL DESIGN SURFACES		183.33	183.24	183.34	183.04
OFFSET	-1.05 -0.75 -0.4 0				

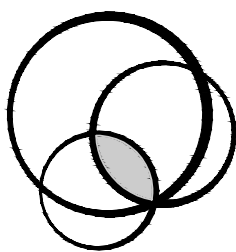
CHAINAGE 273.874

A	ISSUED FOR APPROVAL	05/08/20	CH				
REV	DESCRIPTION	DATE	BY	REV	DESCRIPTION	DATE	BY

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PROPOSED HARDSTAND  
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


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ABN 82 153 018 800

HARDSTAND  
CROSS SECTIONS  
SHEET 2 OF 2


Scale

Horizontal:



SCALE 1:100 (A1)

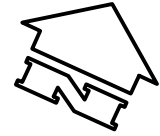
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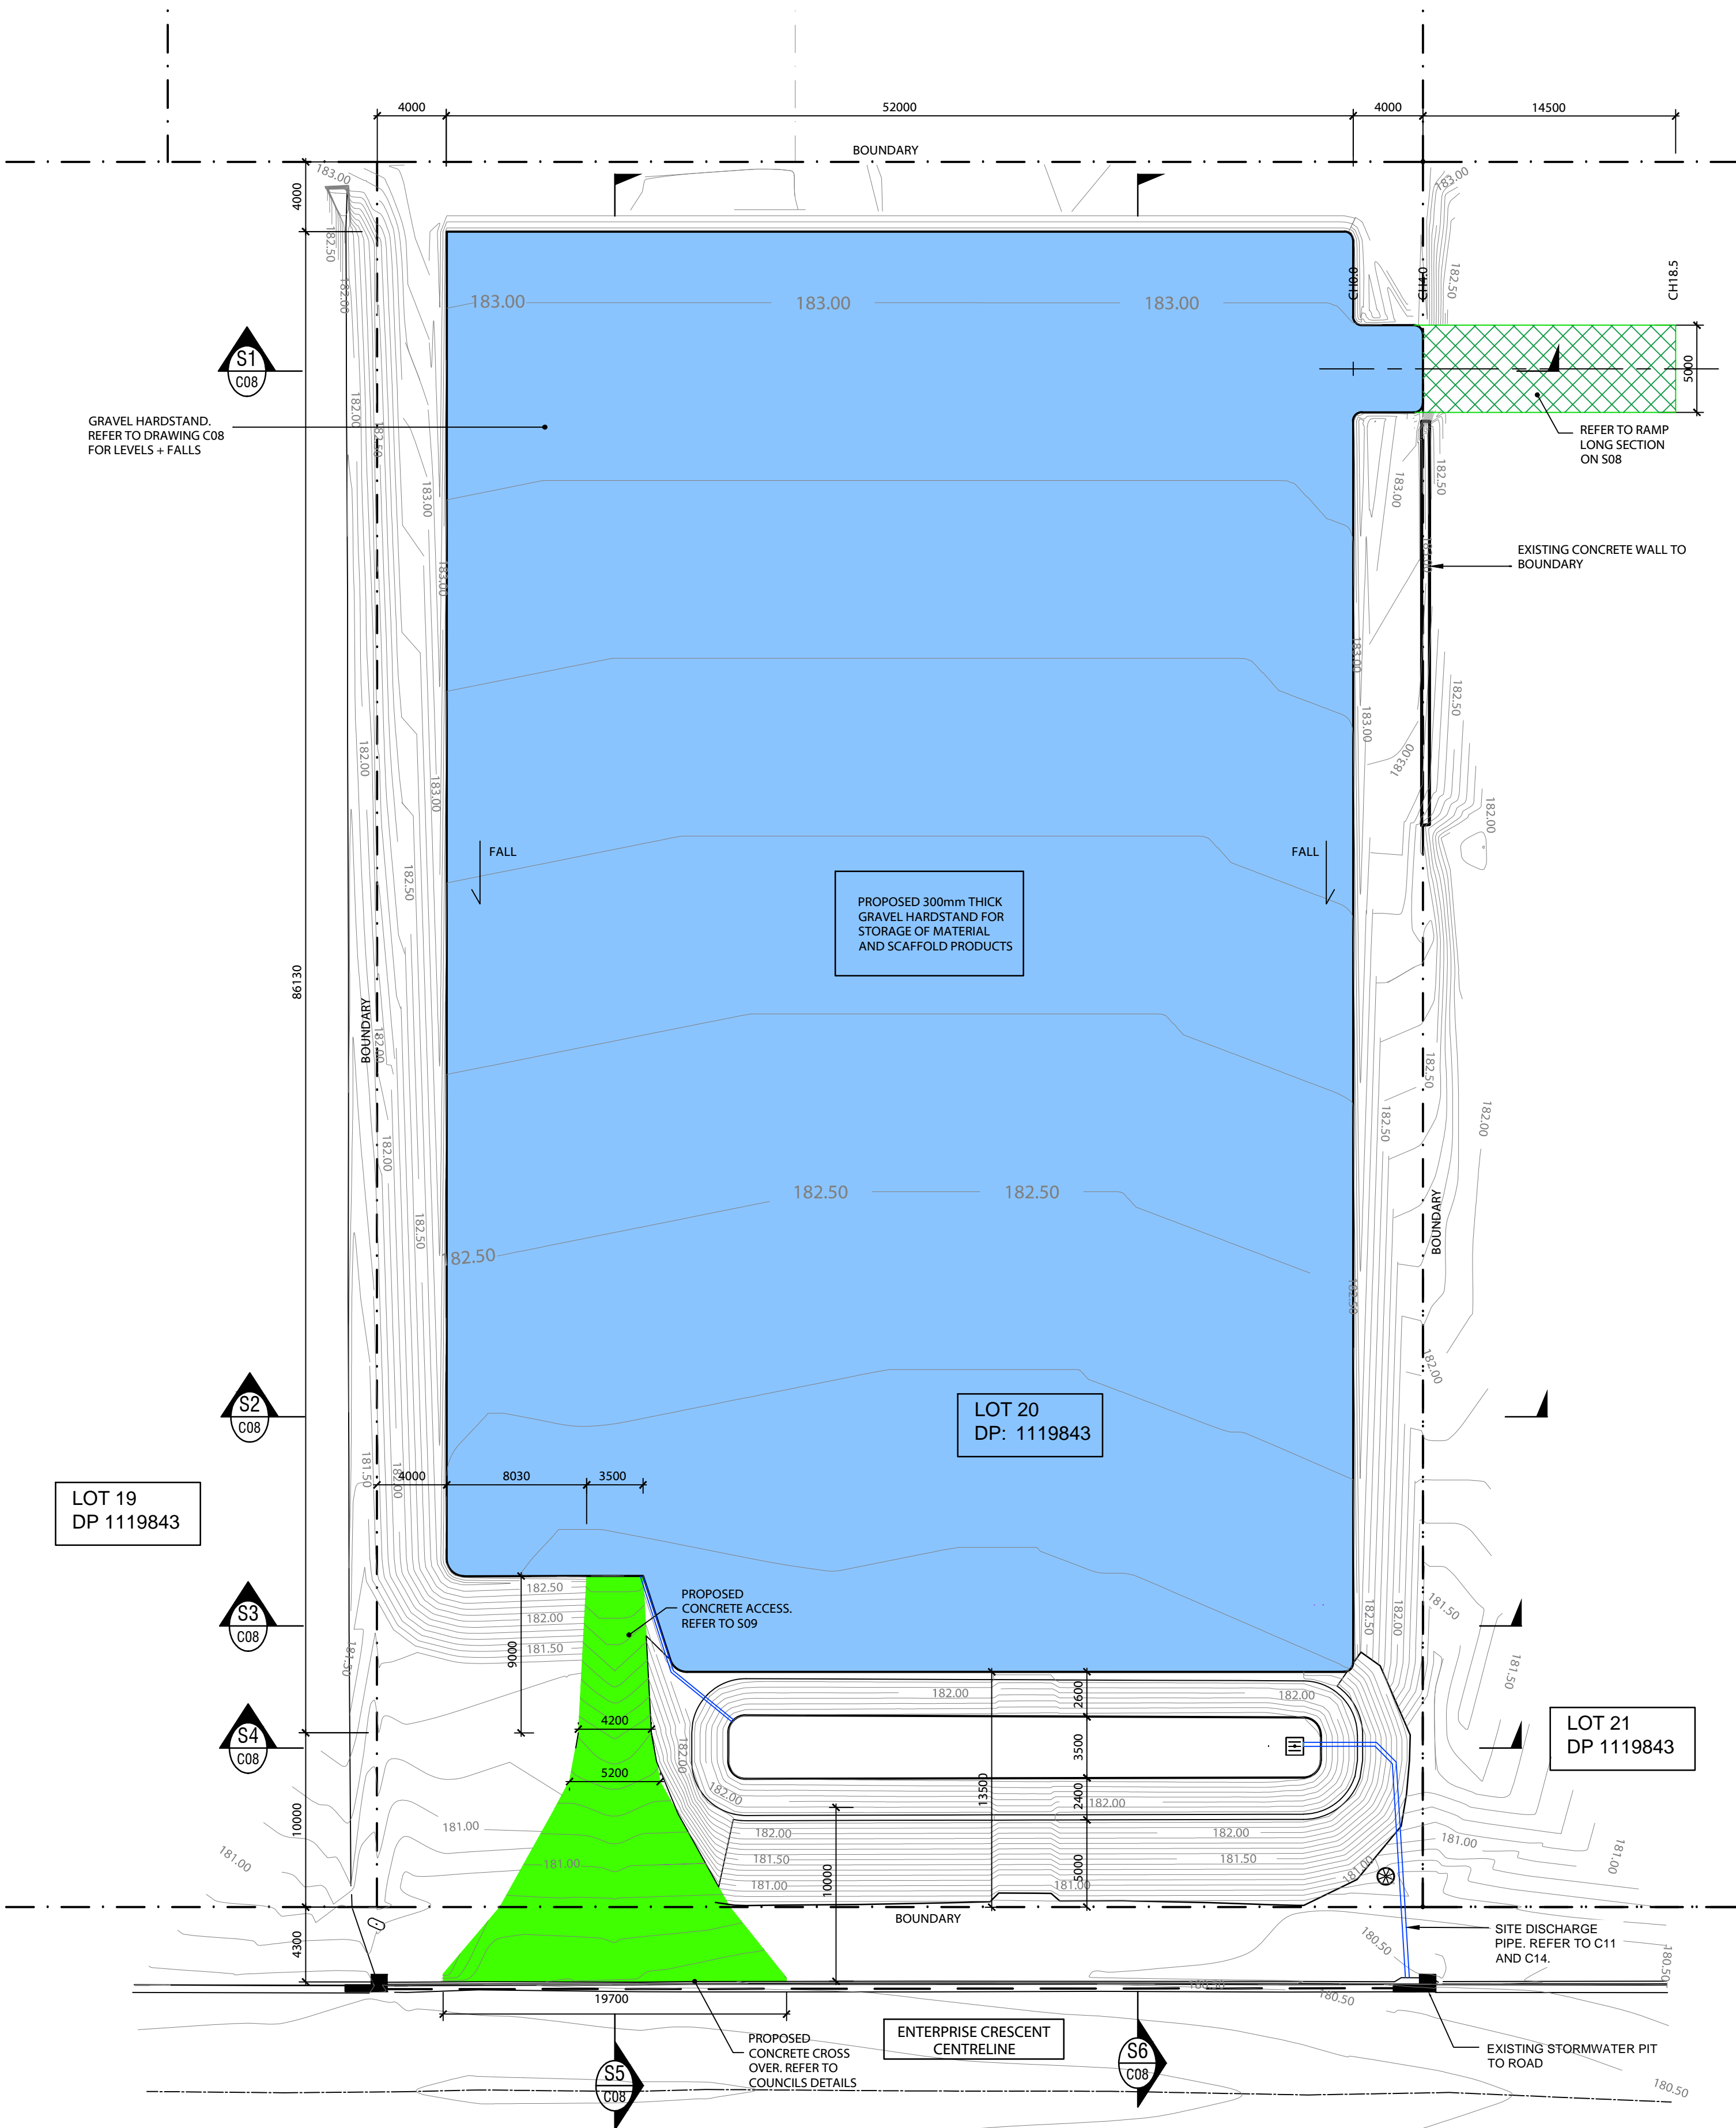
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CIVIL DRAWING			
Designed	BH	Approved on behalf of RHM Consulting Engineers	
Drawn	CH		05/08/20
		Project Engineer/Director	Date
Datum	NIL	Drawing No:	Rev
Date	JULY 20	19-027-C06.2	A





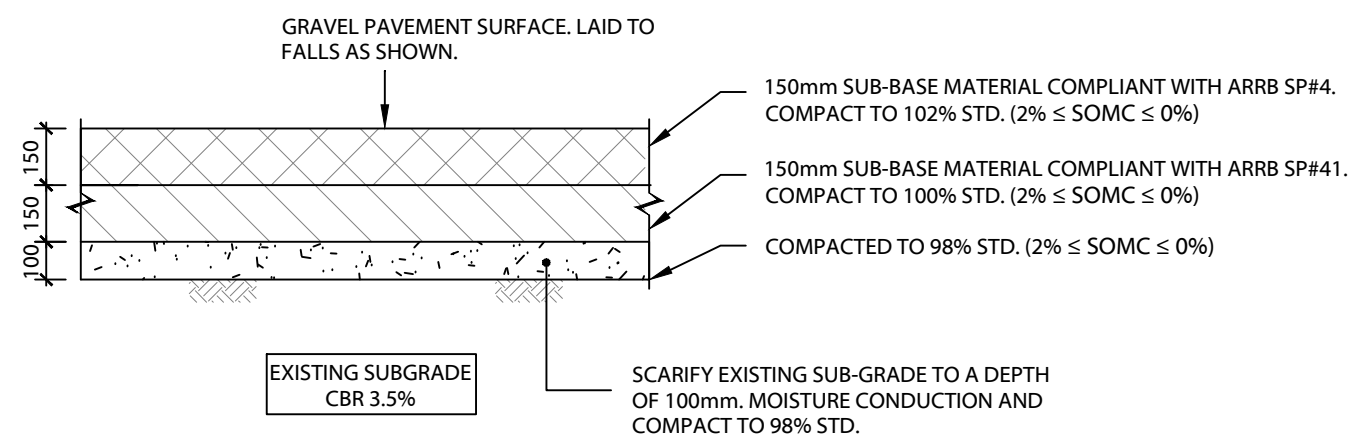
- NOTES:
1. ASSUMED CBR = 3.5% (SOAKED). CBR STRENGTH TO BE DETERMINED ON SITE.
  2. SUB-BASE MATERIAL AS NOTED TO HAVE AS A MINIMUM:
    - GRADING: IN ACCORDANCE WITH ARRB SPECIAL REPORT #41
    - CBR STRENGTH: GREATER THAN 40% (SOAKED)
    - STONE SIZE = 20mm
    - PI LESS THEN 12%
  3. DESIGNED ESA's 1.42 x 10<sup>4</sup> ESA's OVER A 5 YEAR DESIGN LIFE
  4. SUB - GRADE PREPARATION WORKS TO INCLUDE:
    - REMOVE TOPSOIL AND BUND TO FRONTAGE AS SHOWN
    - REMOVE ANY ORGANIC MATTER AND TREE ROOTS WHERE APPLICABLE
    - PROOF ROLL SUB - GRADE TO ENSURE NO UNSUITABLE OR SOFT MATERIAL EXISTS. IF SO, REMOVE AND REPLACE WITH CLEAN APPROVED FILL
    - SCARIFY TO A DEPTH OF 150mm, MOISTURE CONDITION AND COMPACT TO 98% STD



GENERAL HARDSTAND  
SCALE 1:250 (A1)

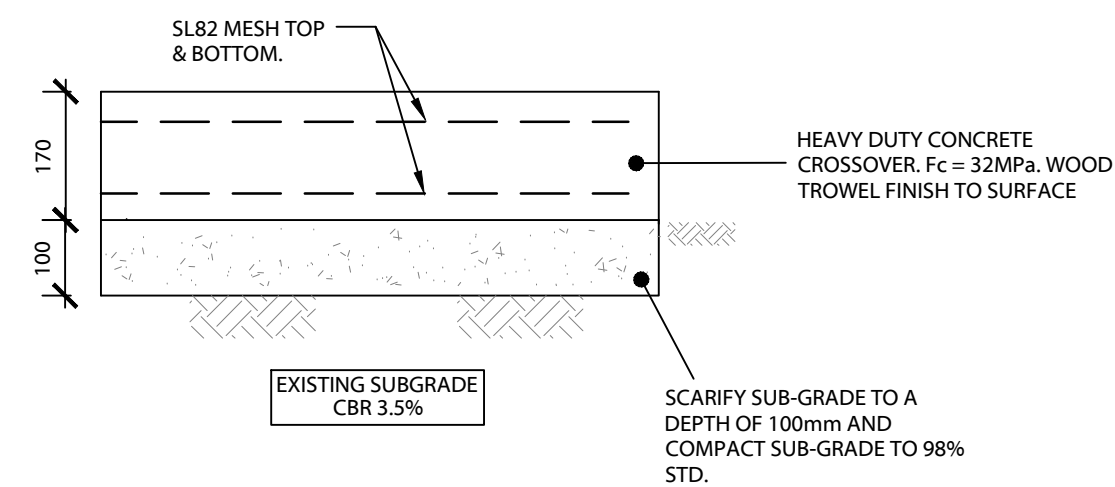
LEGEND:

- GENERAL HARDSTAND AREA: PAVEMENT BASED ON SUB-GRADE STRENGTH OF CBR=3.5%. TOTAL PAVEMENT THICKNESS 300mm. REFER TO DETAILS BELOW
- MAIN ENTRY TO SITE: CONCRETE THICKNESS BASED ON SUB-GRADE STRENGTH OF CBR = 3.5%. TOTAL PAVEMENT THICKNESS 170mm. REFER TO DETAILS ON C09. MAXIMUM GRADIENT OF PAVEMENT TO ENTRY 6.25%.
- PROPOSED ACCESS RAMP TO LOT 20 OF DP 1119843



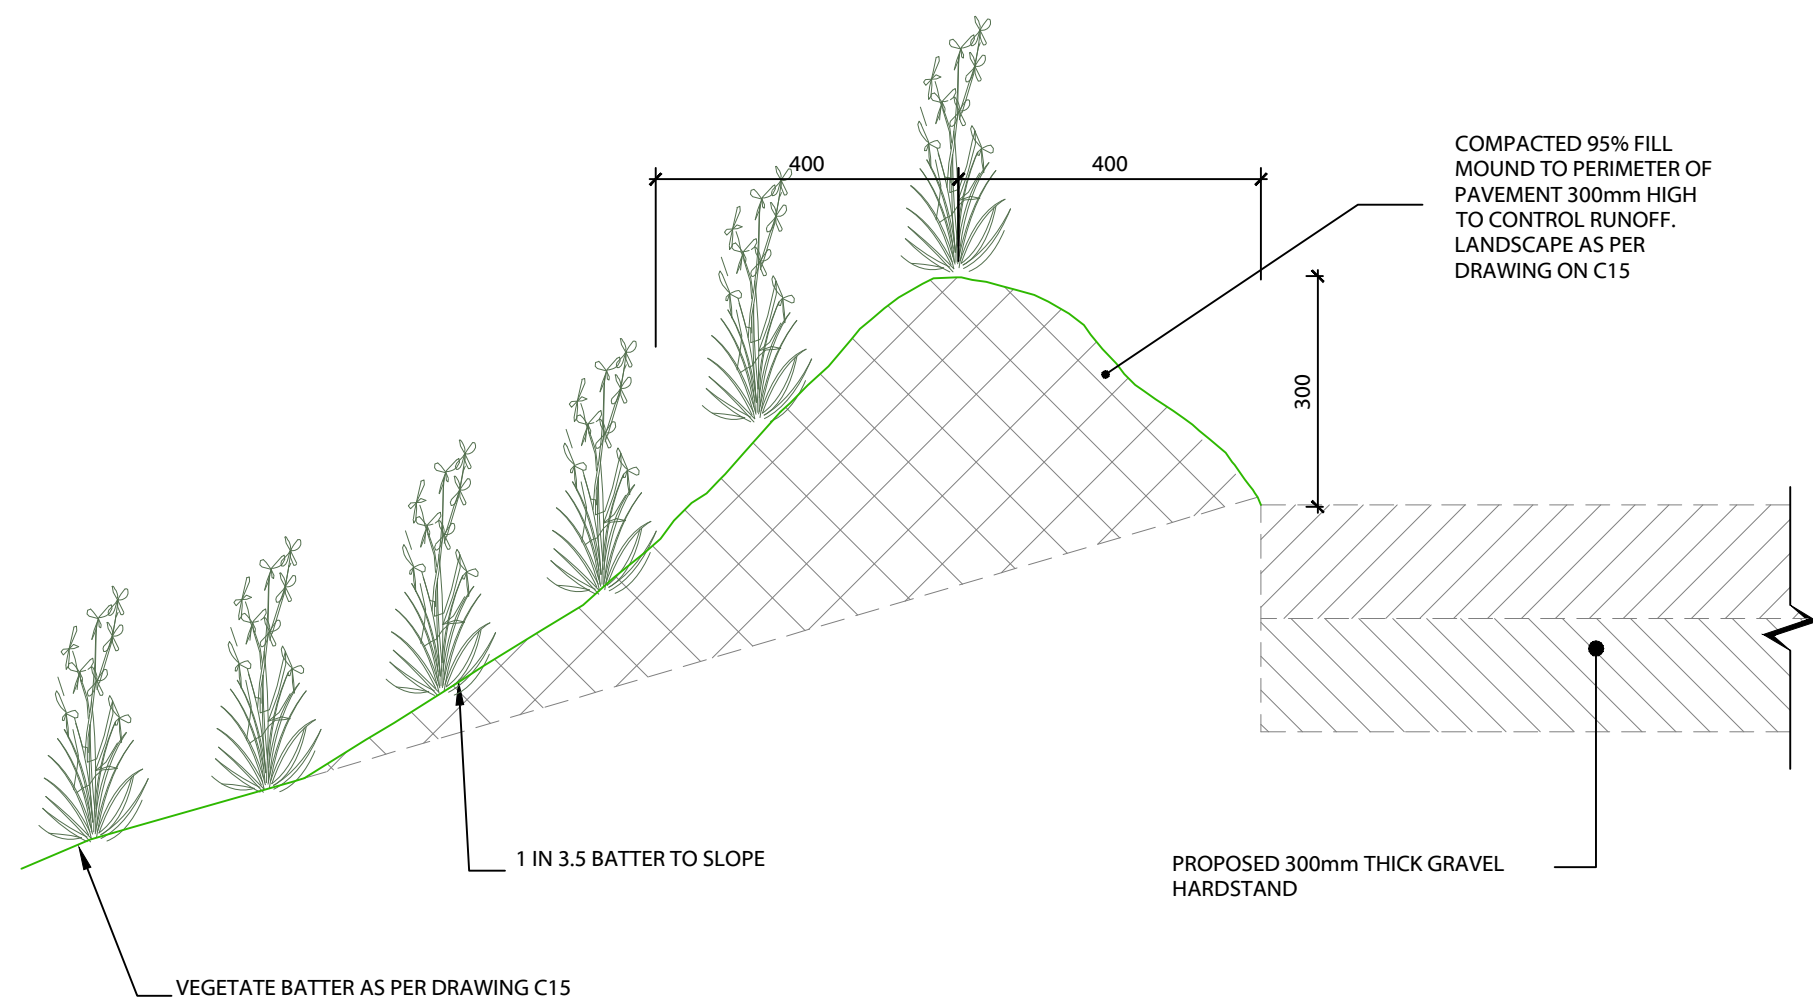
GENERAL HARDSTAND

SCALE 1:20 (A1)



CONCRETE DRIVEWAY DETAILS

SCALE 1:10 (A1)  
NOTE: IF THE EXISTING SUB-GRADE IS NOT SMOOTH, LEVEL WITH SAND.



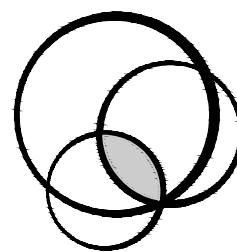
BOUNDING TREATMENT TO PERIMETER  
SCALE 1:10 (A1)

REV	DESCRIPTION	DATE	BY	REV	DESCRIPTION	DATE	BY
D	GENERAL AMENDMENTS	05/08/20	CH				
C	GENERAL AMENDMENTS	16/06/20	CH				
B	INCREASED HARDSTAND AREA.	04/02/20	BC				
A	ISSUED FOR APPROVAL.	10/01/20	JP				

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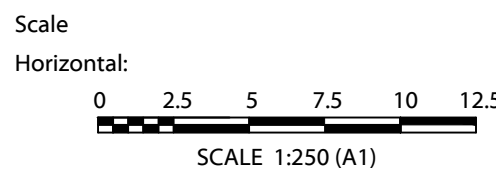
PROPOSED HARDSTAND  
38-40 ENTERPRISE CRESCENT  
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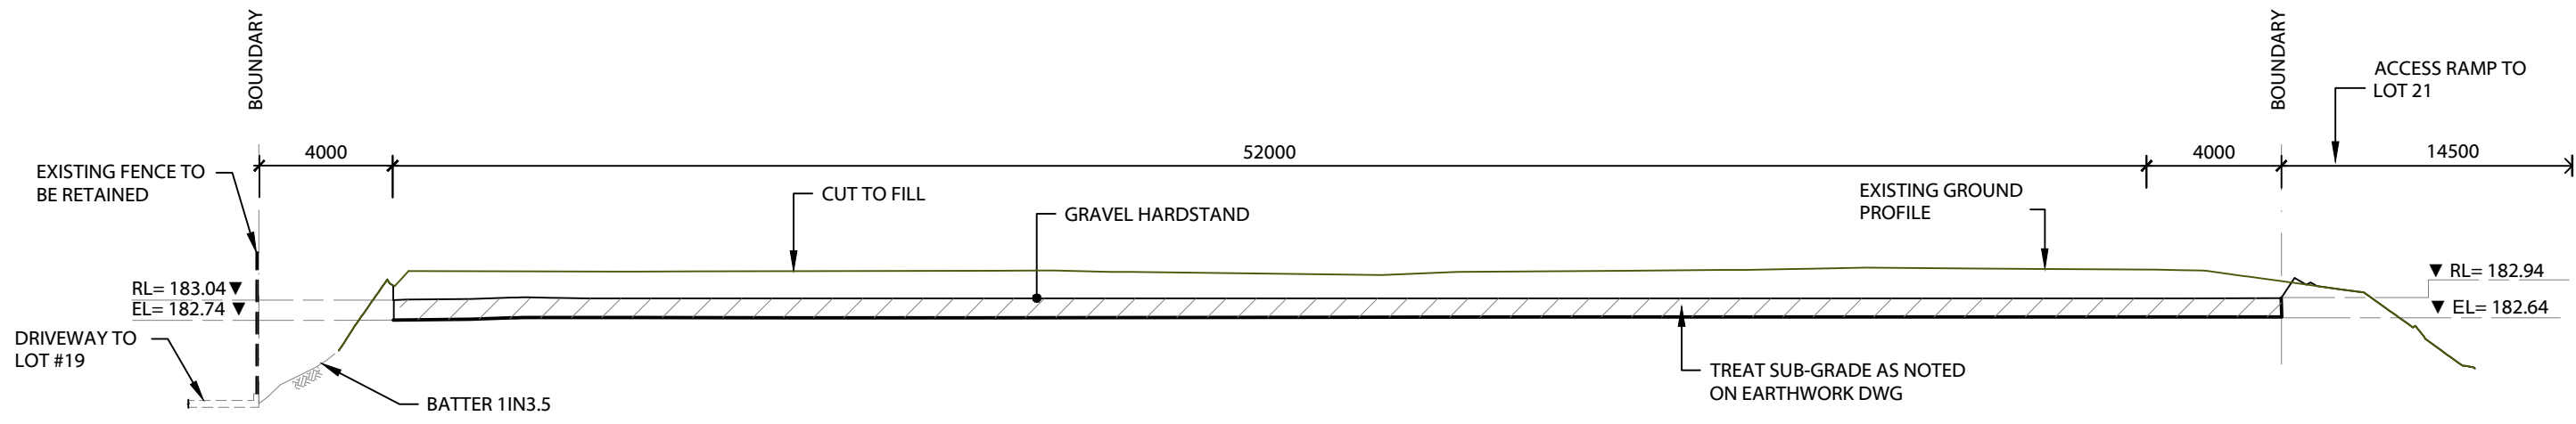
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PROPOSED HARDSTAND  
PLAN



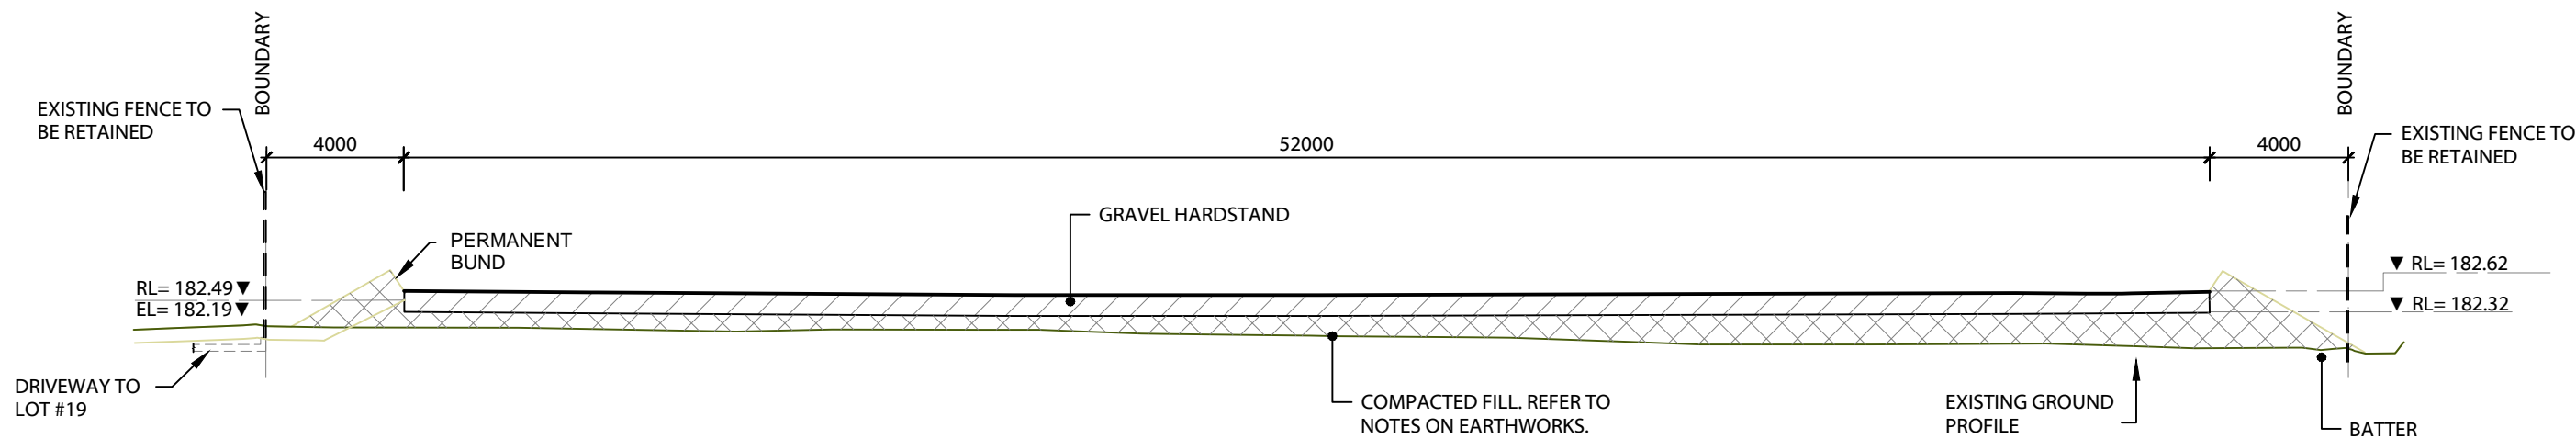
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Designed	BH	Approved on behalf of RHM Consulting Engineers	05/08/20
Drawn	CH	Project Engineer/Director	Date
Datum	NIL	Drawing No:	Rev
Date	JULY 20	19-027-C07	D





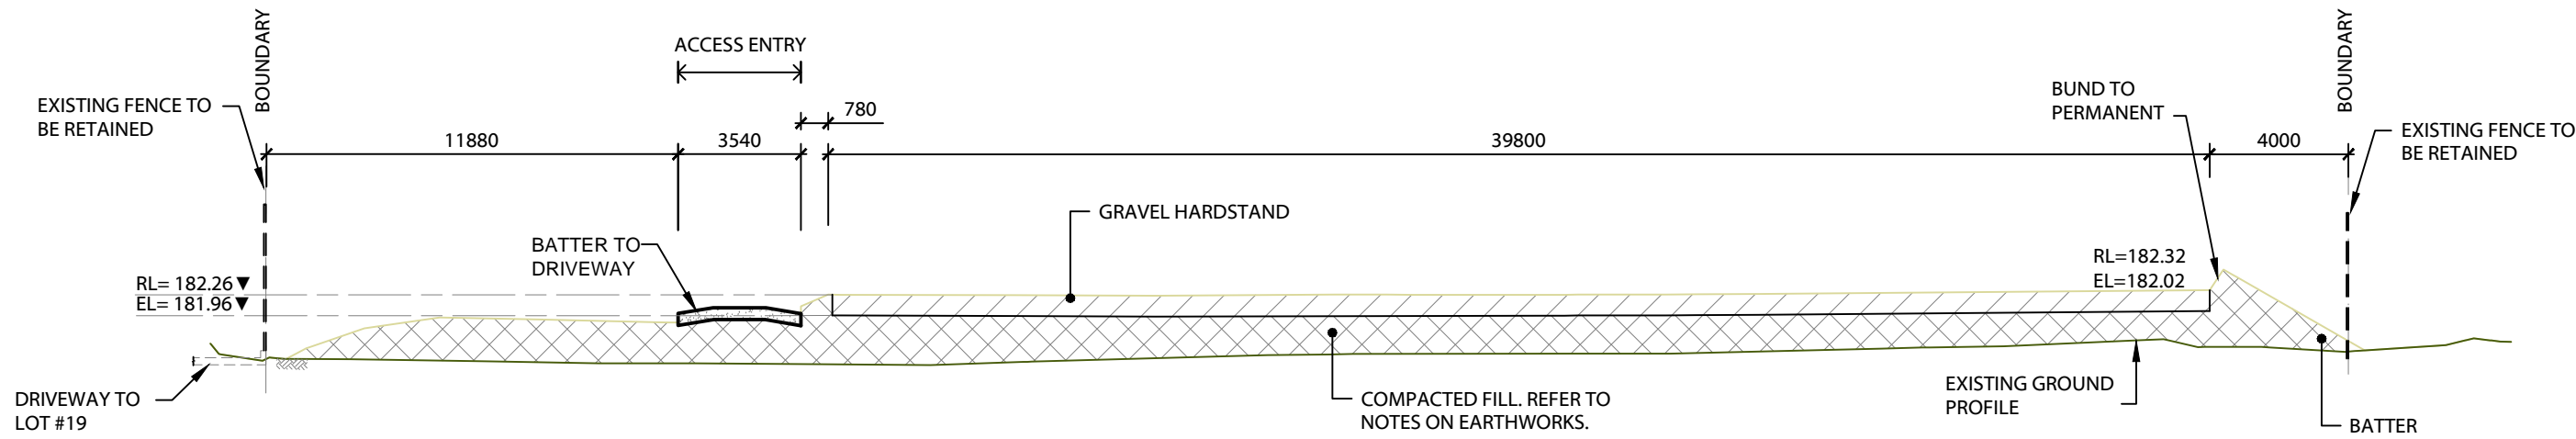
SECTION S1 - HARDSTAND AREA

SCALE:  
HORIZONTAL 1:200 (A1)  
VERTICAL 1:100 (A1)



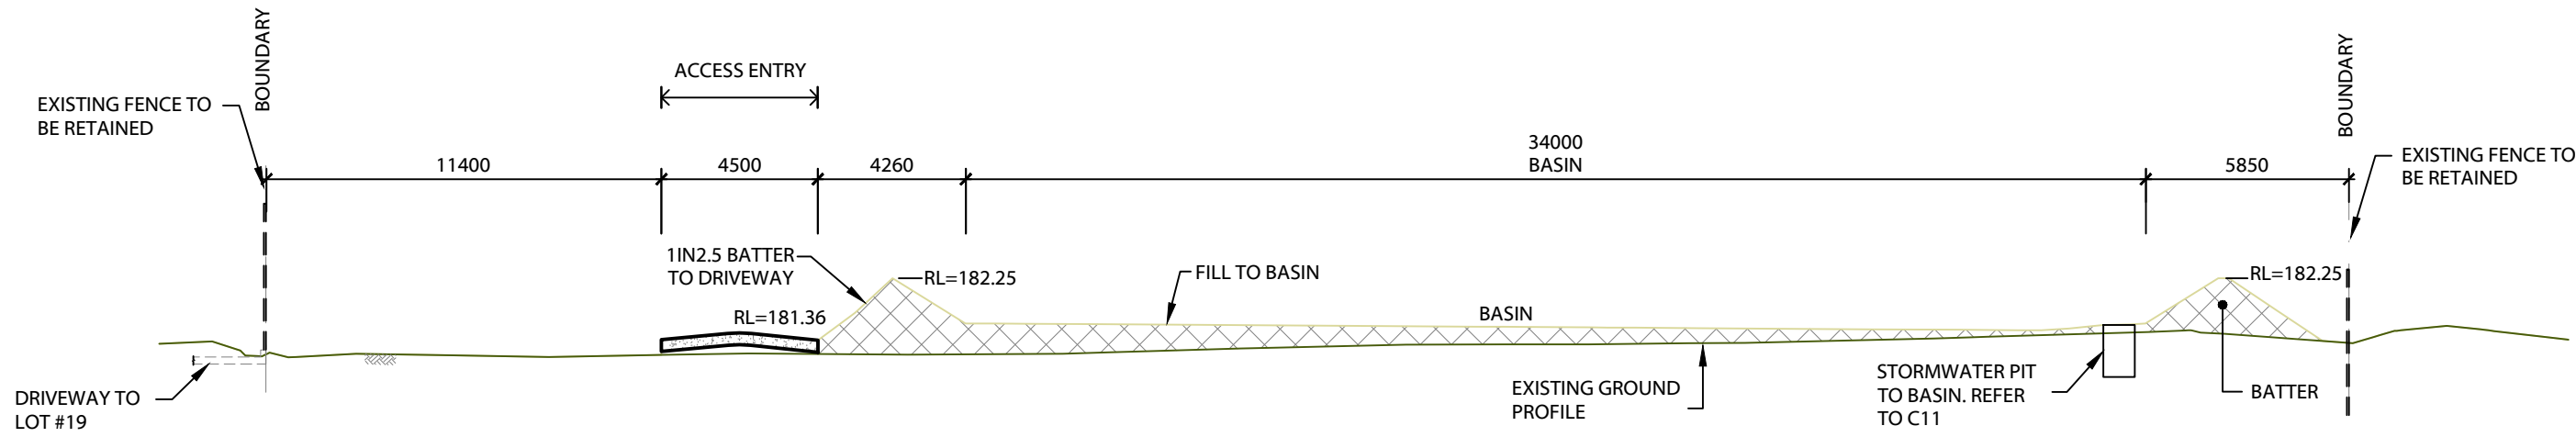
SECTION S2 - HARDSTAND AREA

SCALE:  
HORIZONTAL 1:200 (A1)  
VERTICAL 1:100 (A1)



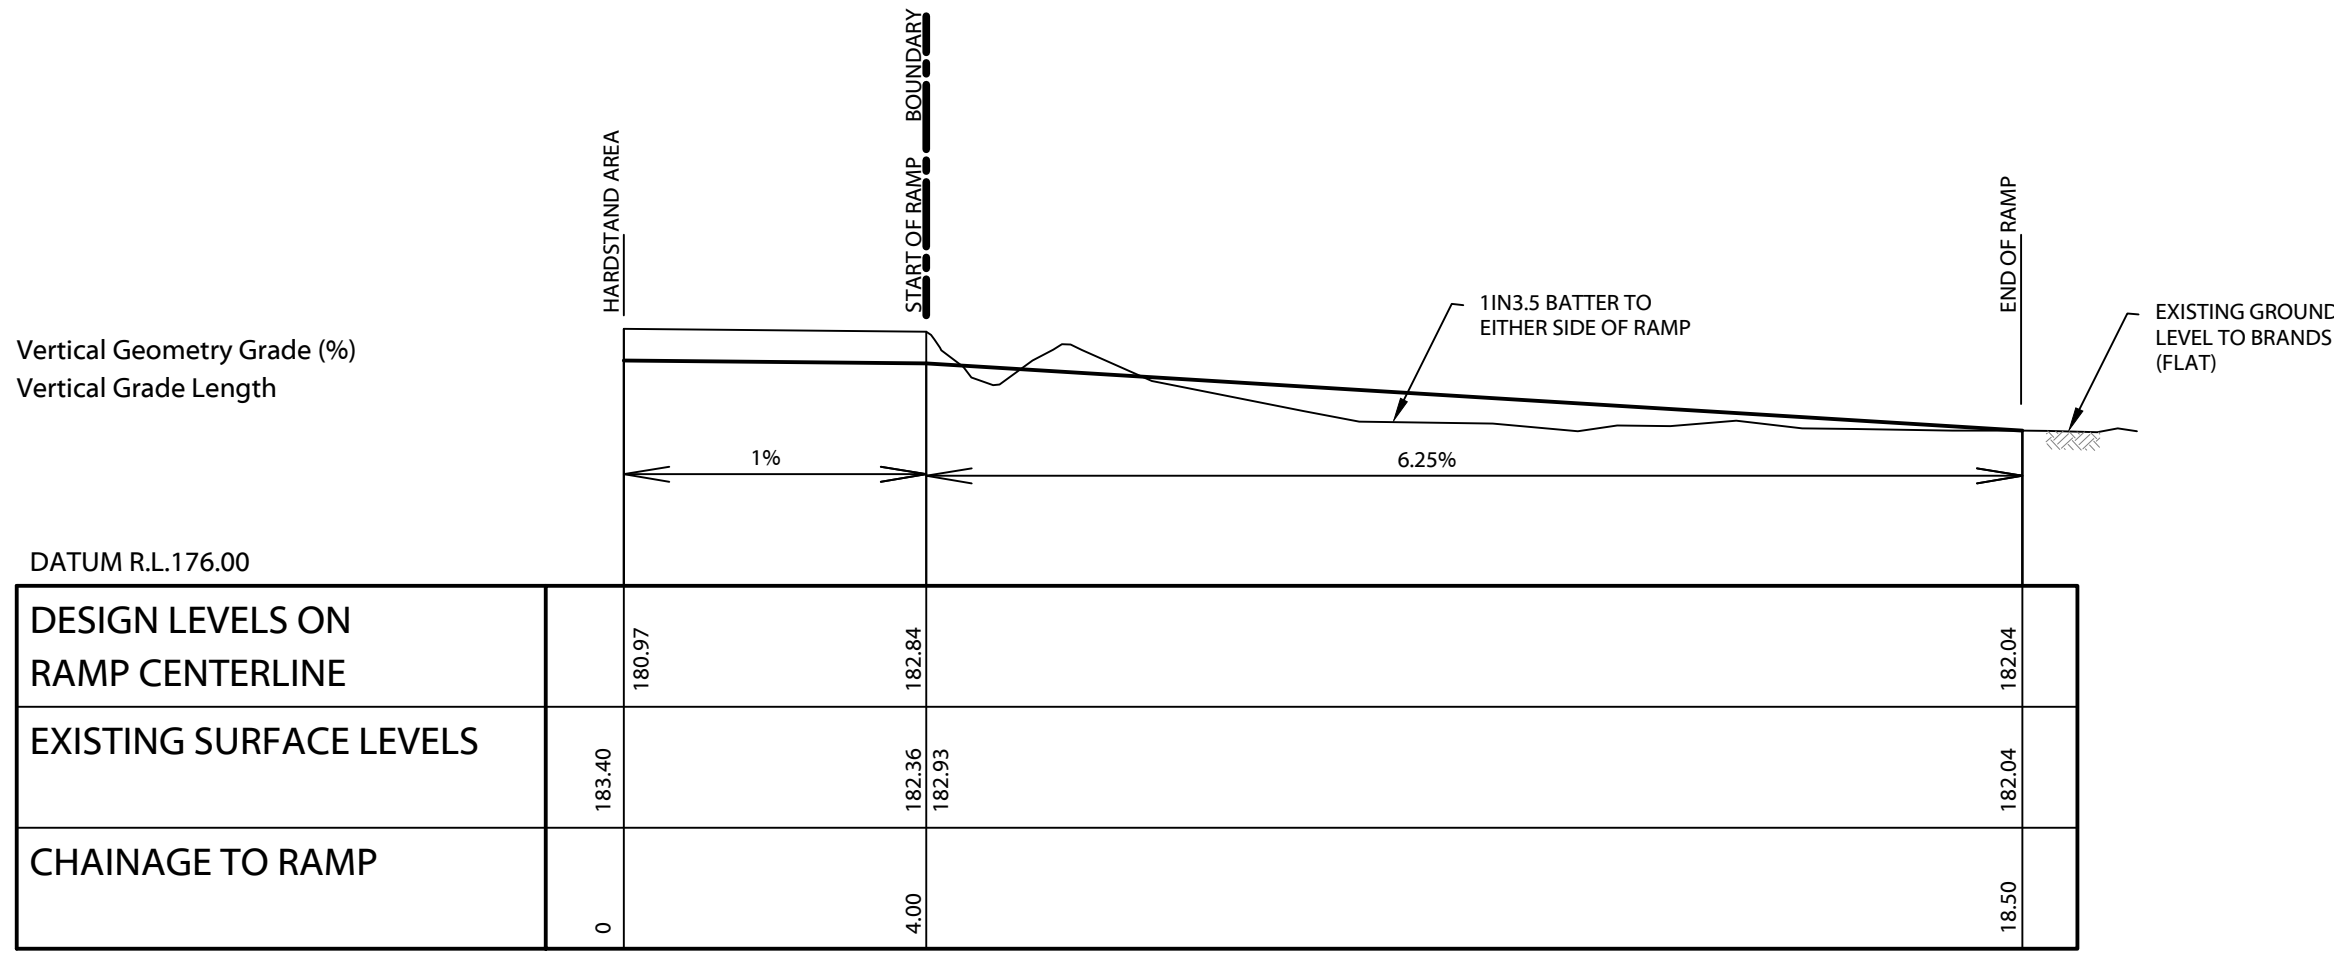
SECTION S3 - HARDSTAND AREA

SCALE:  
HORIZONTAL 1:200 (A1)  
VERTICAL 1:100 (A1)



SECTION S4 - HARDSTAND AREA

SCALE:  
HORIZONTAL 1:200 (A1)  
VERTICAL 1:100 (A1)



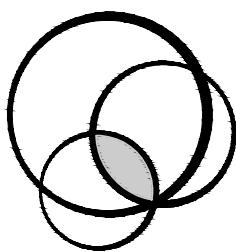
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DEVELOPMENT CONSENT  
This document forms part of  
Council's Notice of Determination  
  
DA 2020-22  
Approval Date: 22-Sep-20  
Delegated Officer: ALISA EVANS

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C	INCREASED HARDSTAND AREA	04/02/20	BC				
A	ISSUED FOR APPROVAL.	10/01/20	CH				

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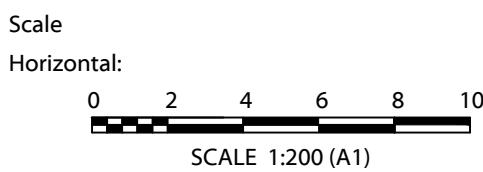
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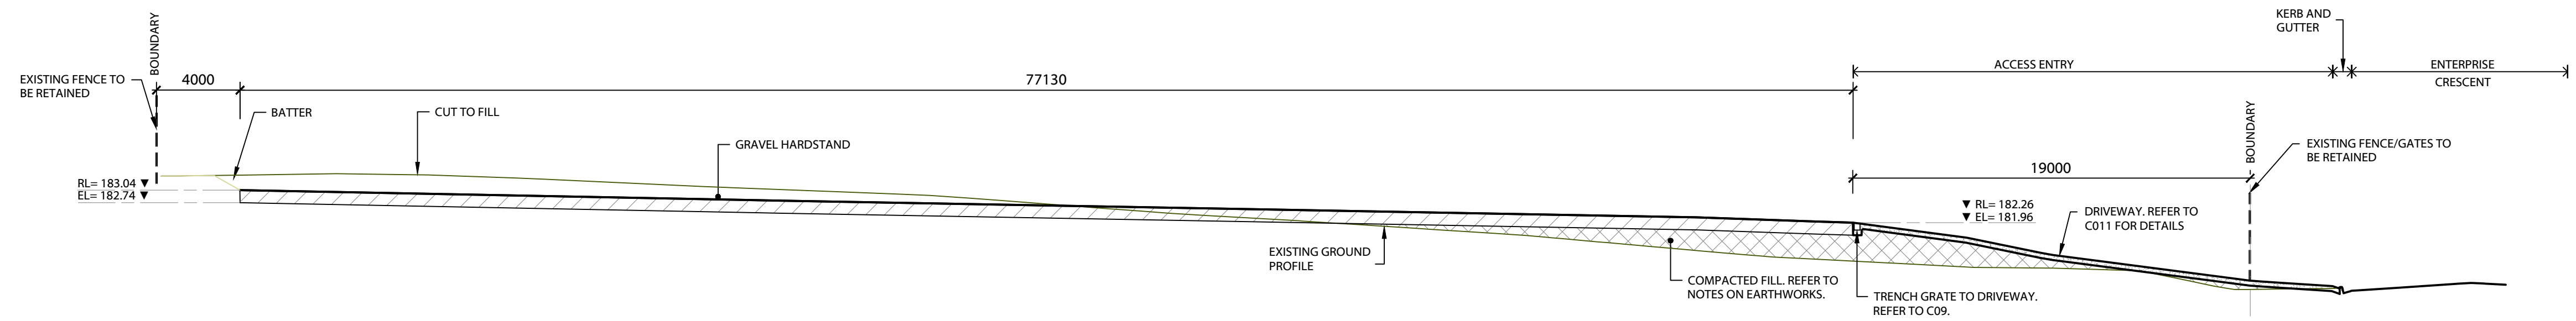
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TYPICAL SECTIONS  
SHEET 2



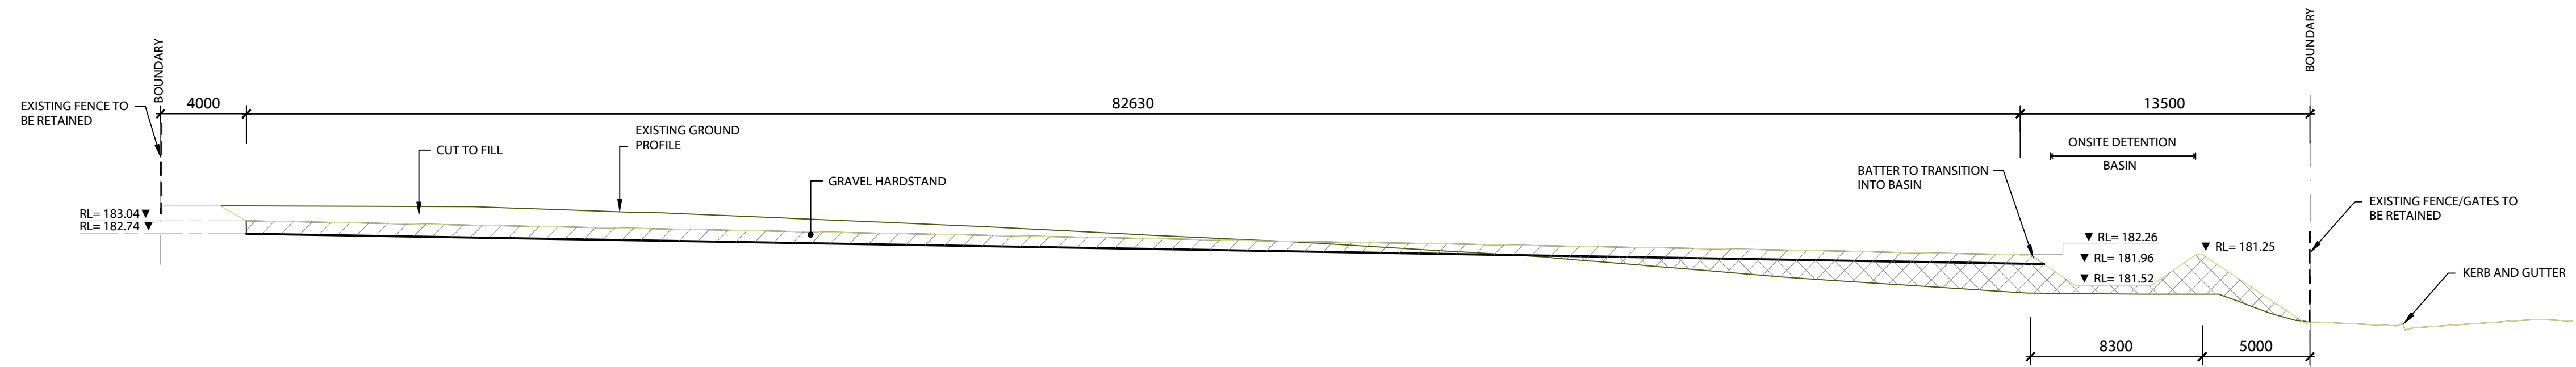
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Datum	NIL	Project Engineer/Director	
Date	JULY 20	Drawing No: 19-027- C08	
		Rev A	





## SECTION S5 - HARDSTAND AREA

SCALE:  
HORIZONTAL 1:200 (A1)  
VERTICAL 1:100 (A1)



## SECTION S6 - HARDSTAND AREA

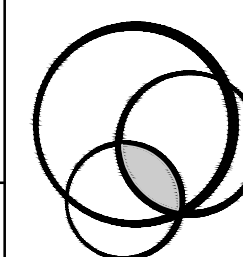
SCALE:  
HORIZONTAL 1:200 (A1)  
VERTICAL 1:100 (A1)

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PROPOSED HARDSTAND  
38-40 ENTERPRISE CRESCENT  
MUSWELLBROOK, NSW 2333


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TYPICAL SECTIONS  
SHEET 2

Scale  
Horizontal:

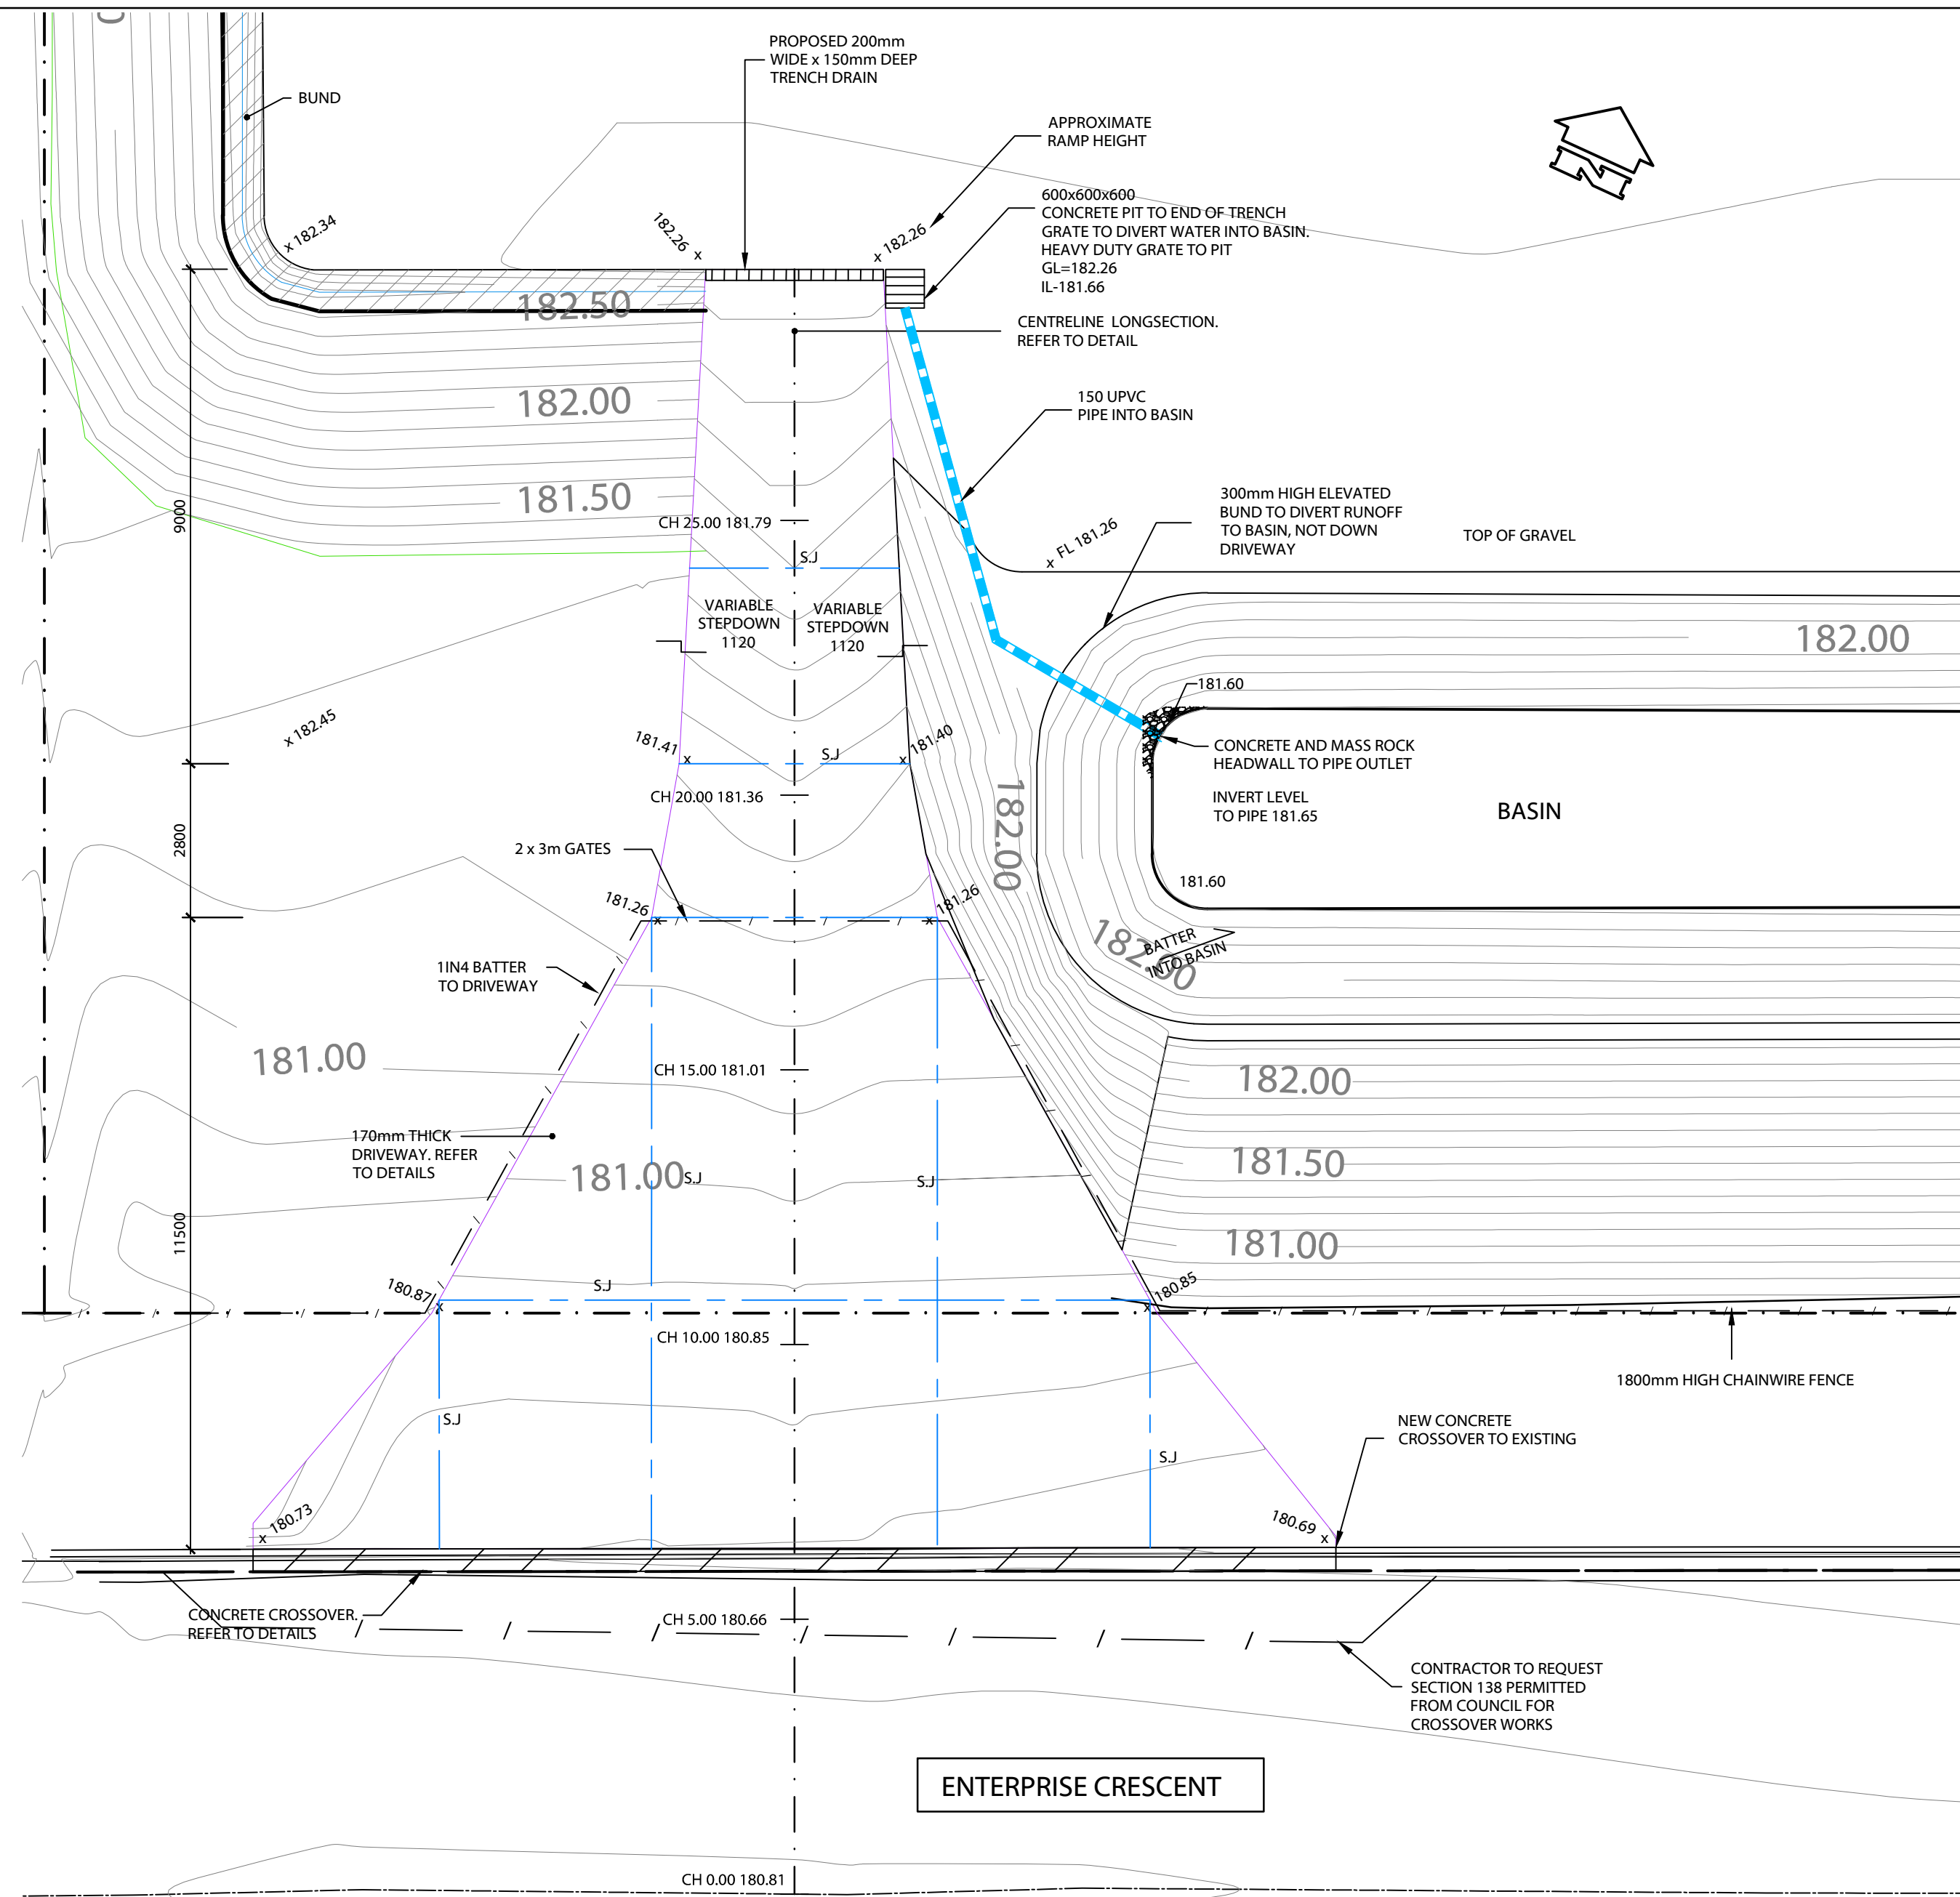


0 2 4 6 8 10

SCALE 1:200 (A1)



CIVIL DRAWING			
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Drawn	CH		05/08/20
		Project Engineer/Director	Date
Datum	NIL	Drawing No:	Rev
Date	JULY 20	19-027- C08.1	A

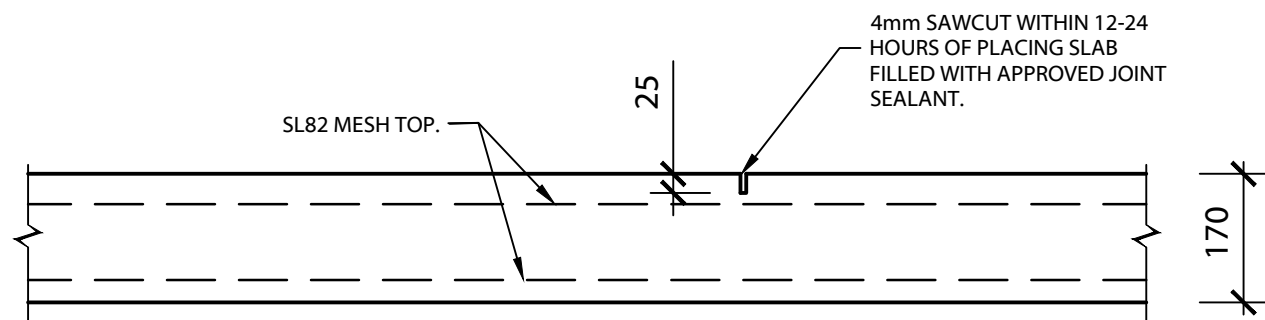




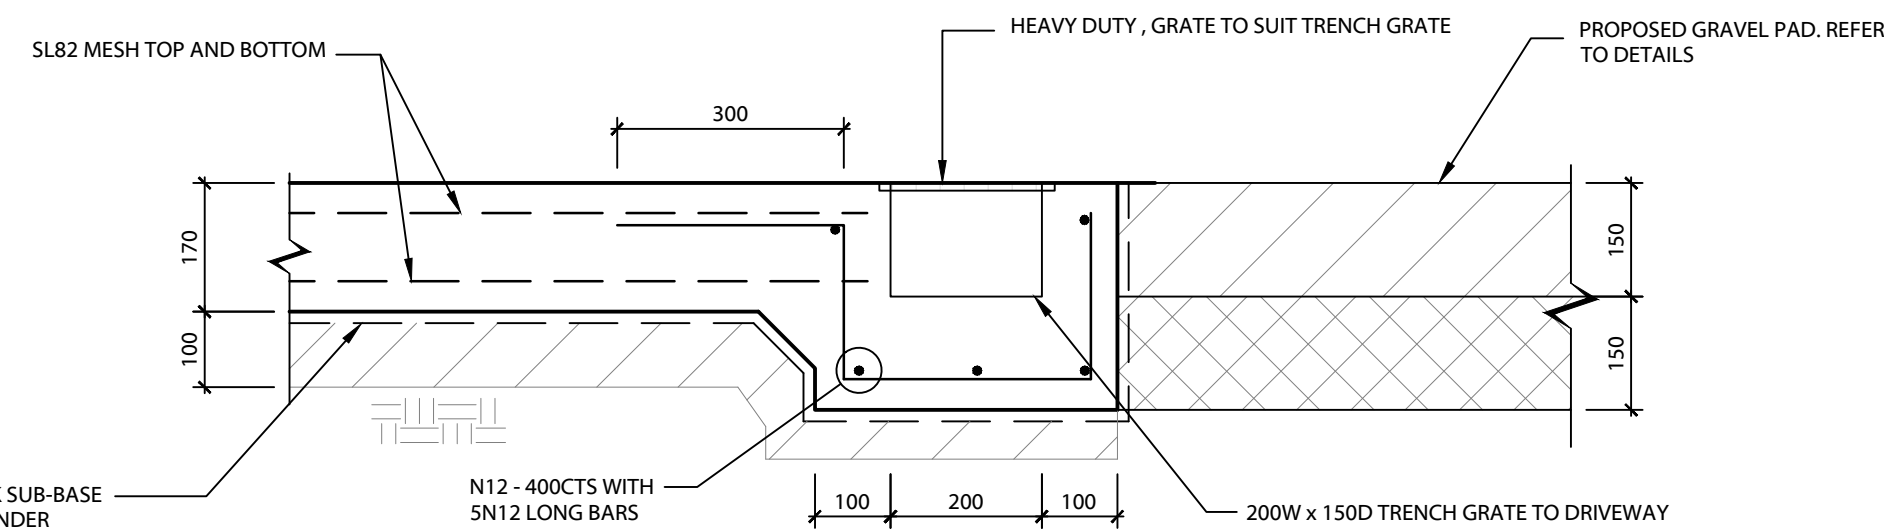
## ACCESS ENTRY PATH

LEGEND:

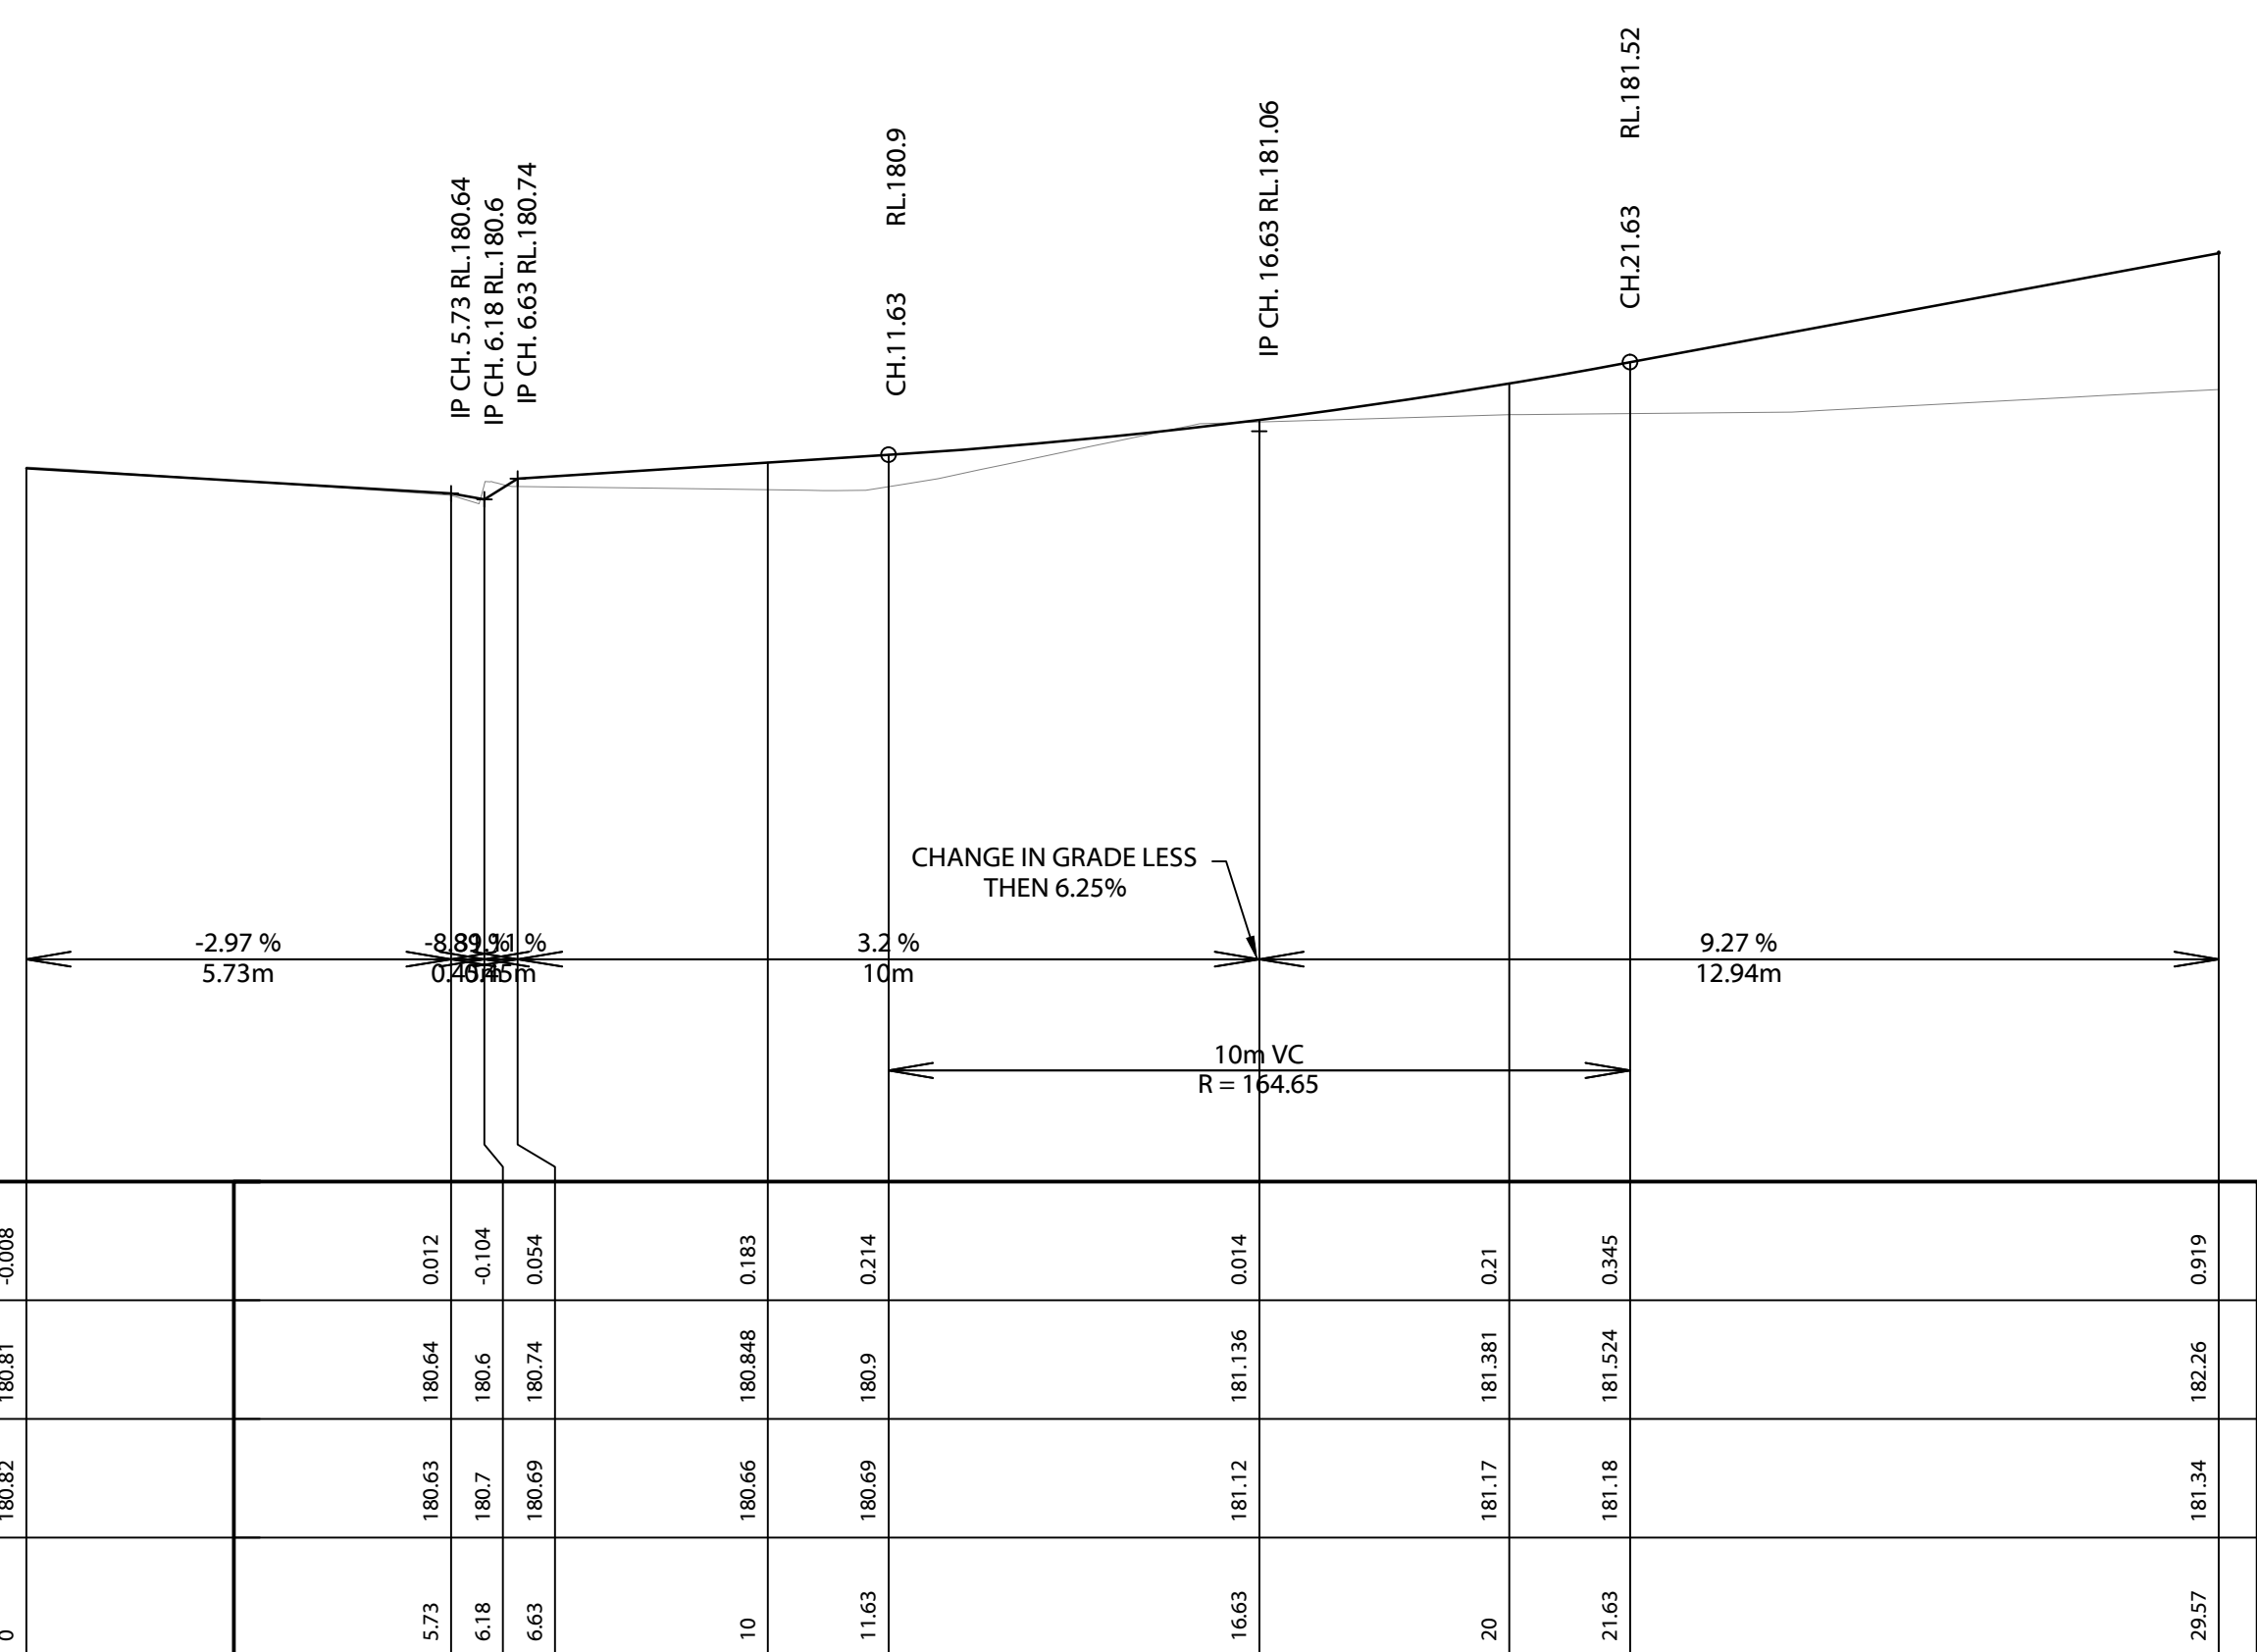
-  - DENOTES 300mm HIGH x 800mm WIDE GRAVEL BUND TO DIVERT RUNOFF AWAY FROM DRIVEWAY
-  - DENOTES SAW CUT JOINTS. REFER TO DETAILS



## SAWCUT JOINT DETAIL



### DETAIL A - TRENCH GRATE TO DRIVEWAY DETAIL

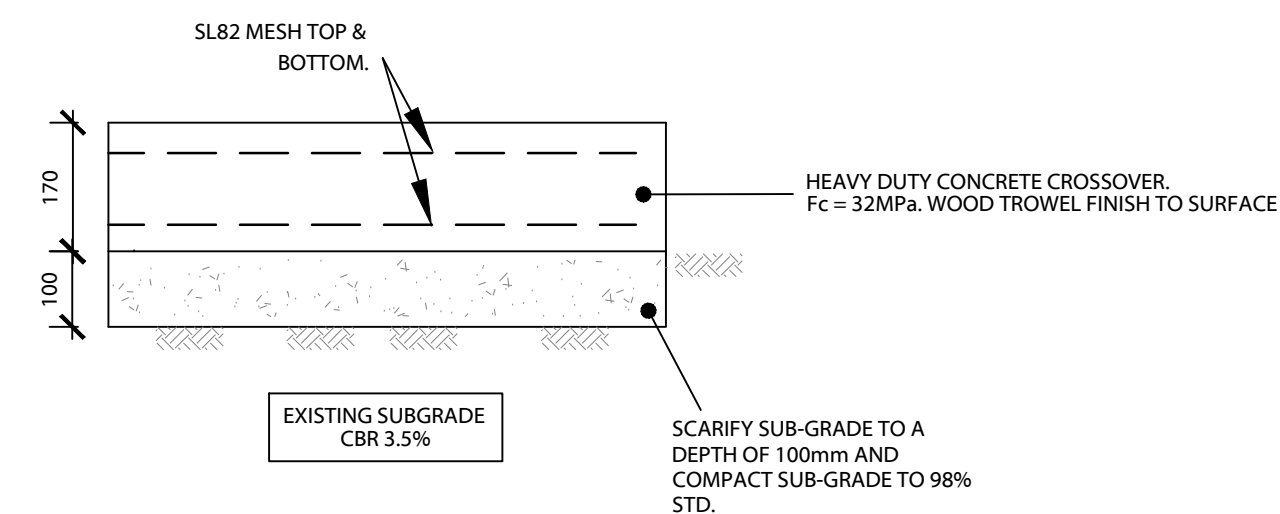


# LONGSECTION CENTRELINE OF DRIVEWAY

**MUSWELLBROOK SHIRE COUNCIL  
DEVELOPMENT CONSENT**  
This document forms part of  
Council's Notice of Determination

**DA 2020-22**  
**Approval Date: 22-Sep-20**

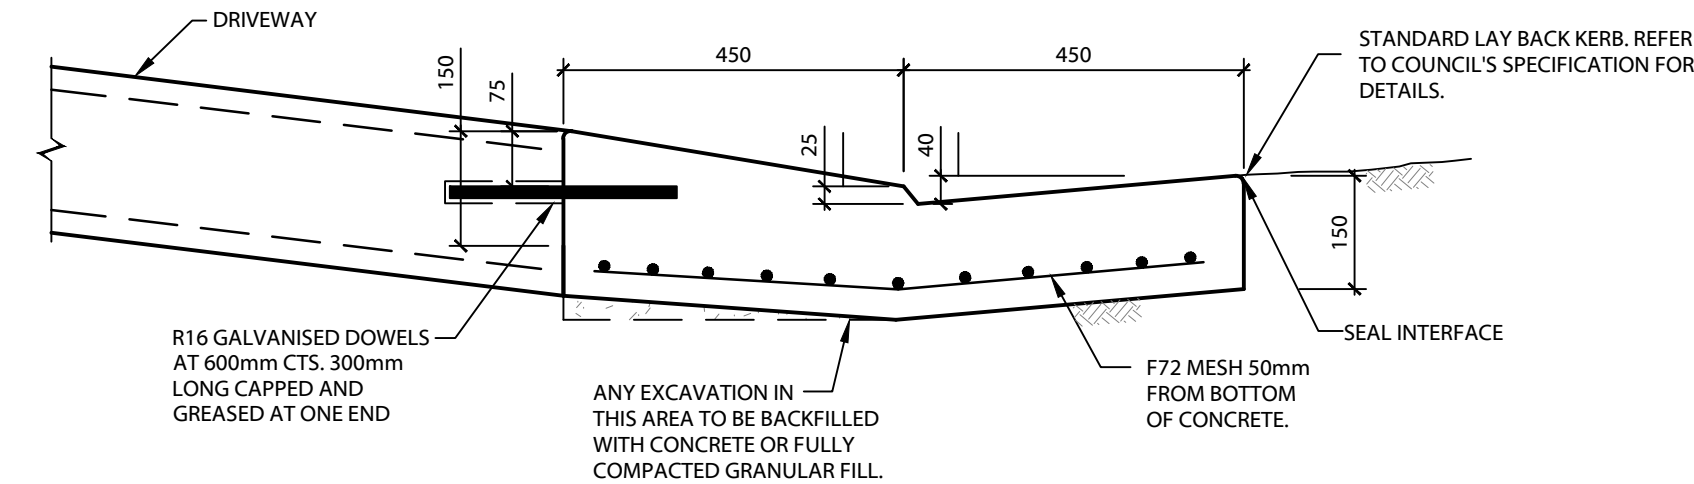
**Delegated Officer: ALISA EVANS**



## CONCRETE DRIVEWAY DETAILS

SCALE 1:10 (A1)

NOTE: IF THE EXISTING SUB-GRADE IS NOT SMOOTH, LEVEL WITH SAND.



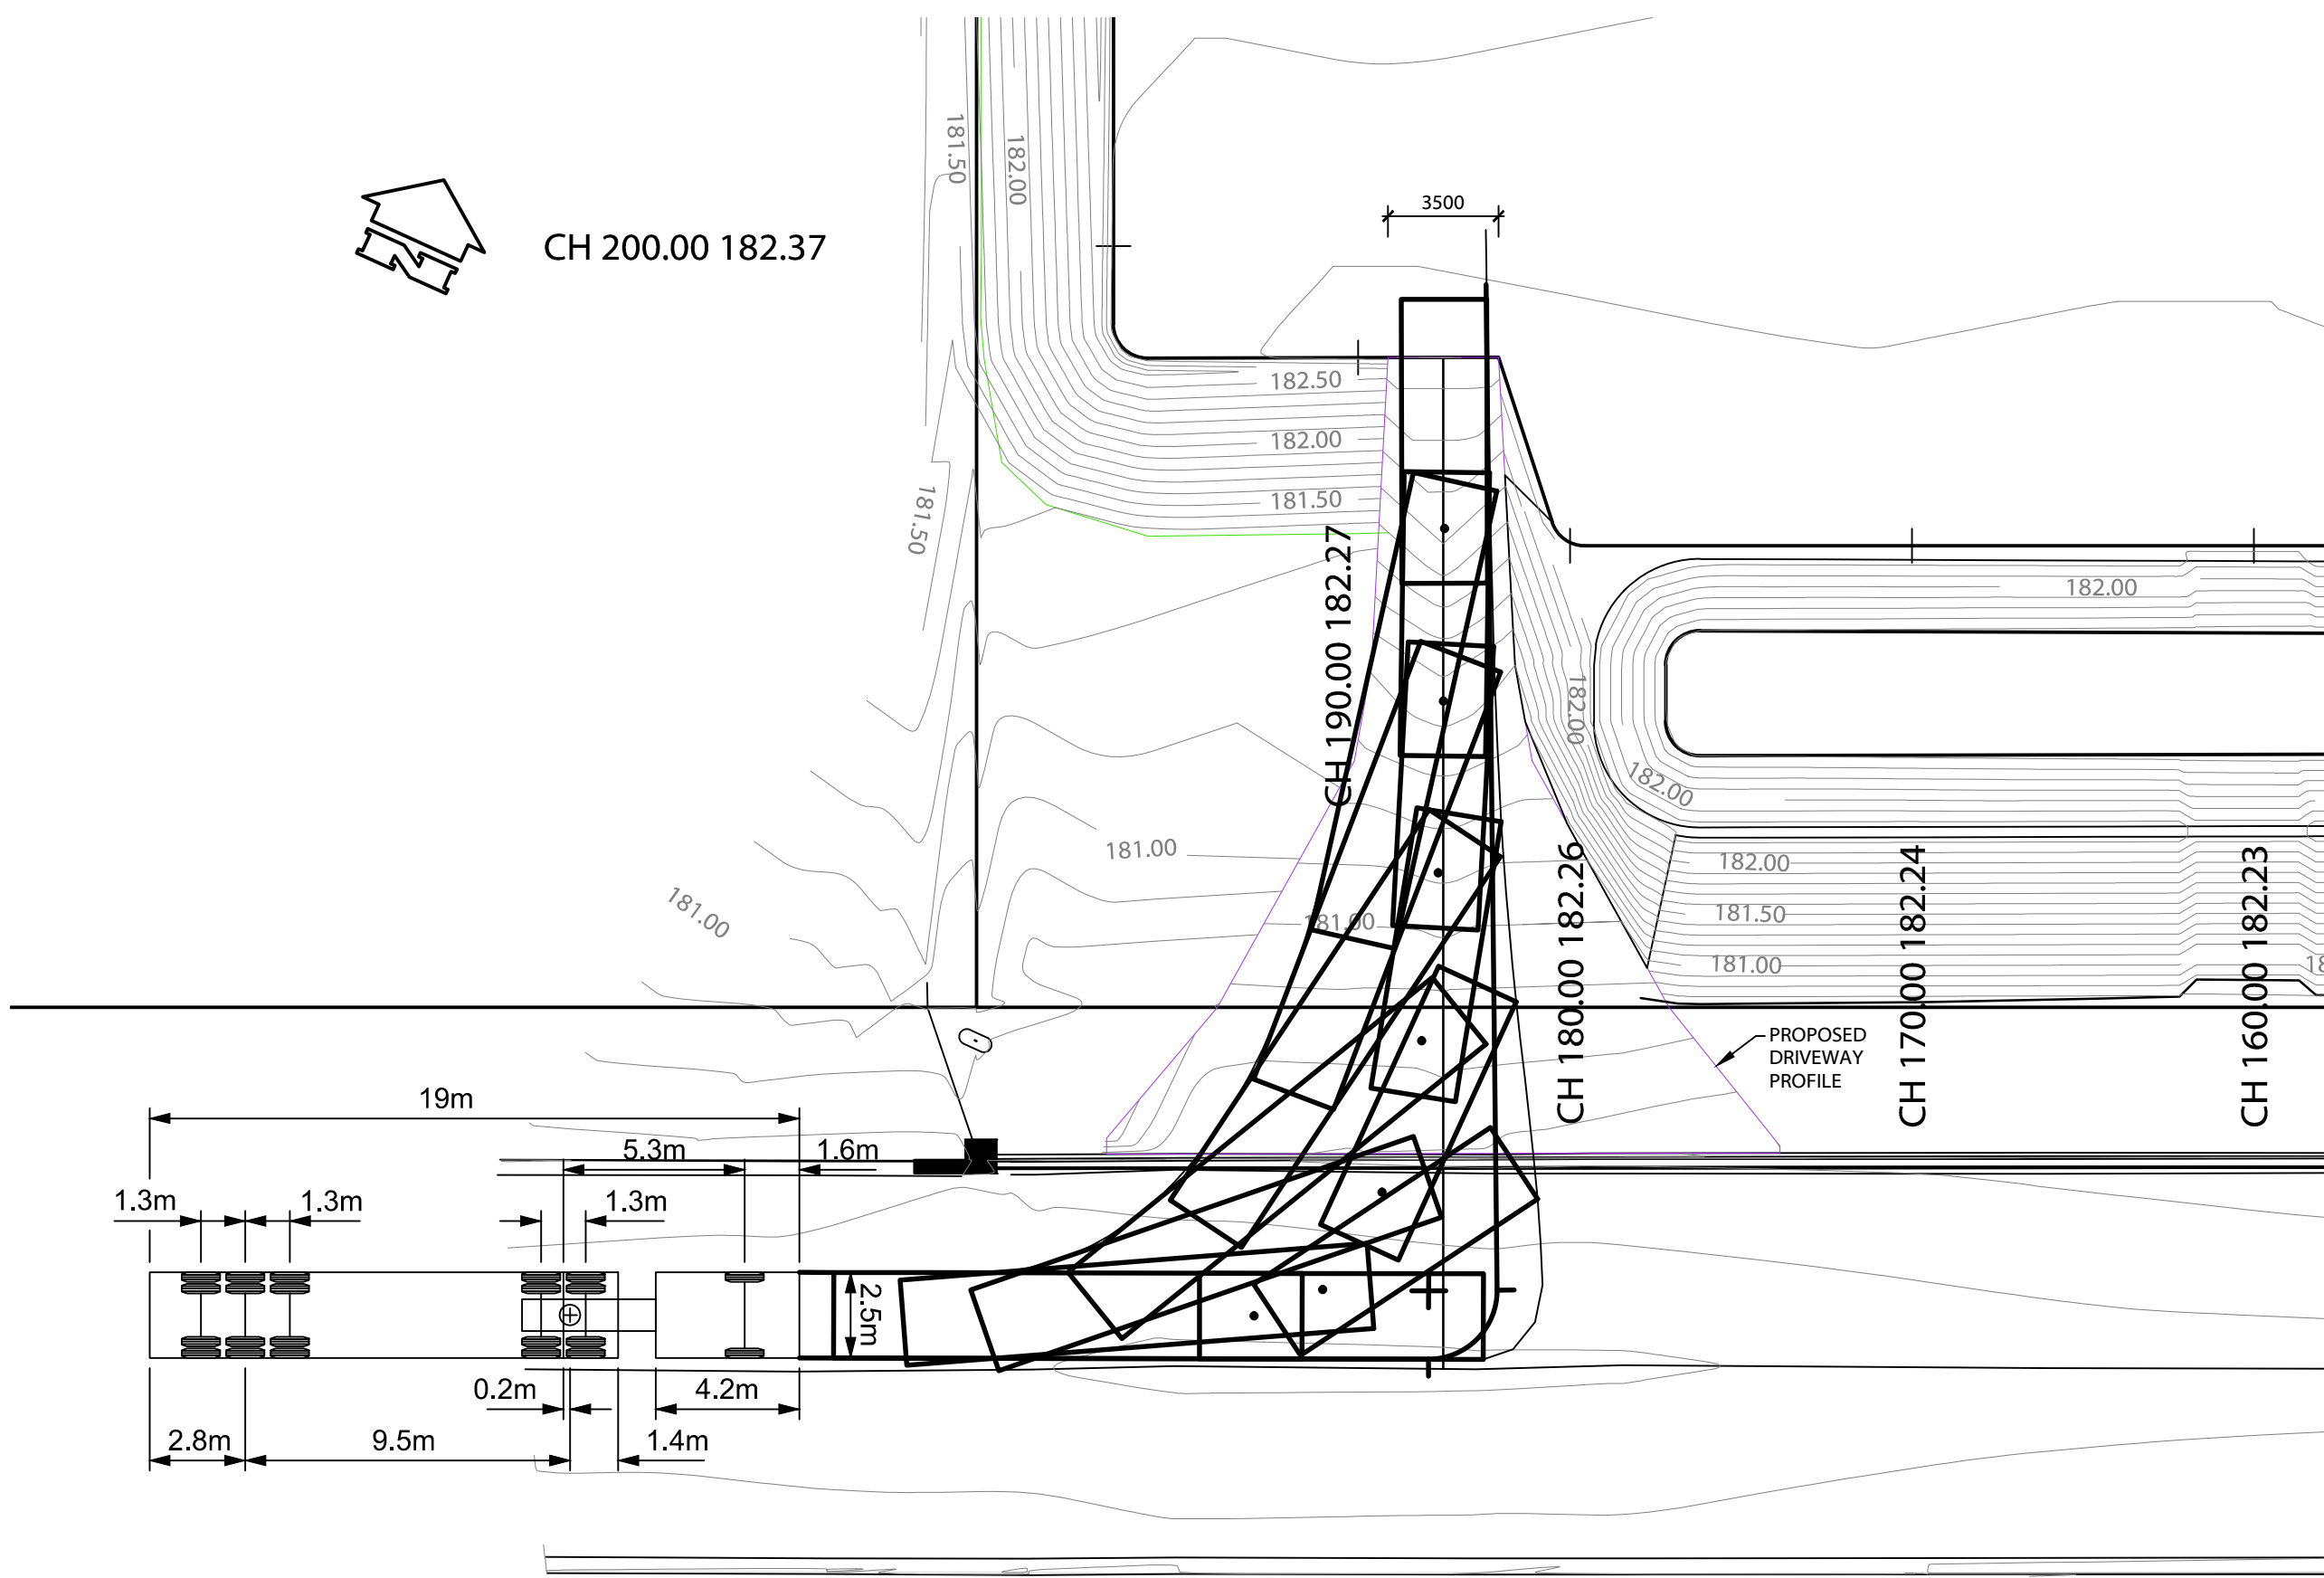
## TYPICAL CROSSOVER DETAIL

SCALE 1:10 (A1)

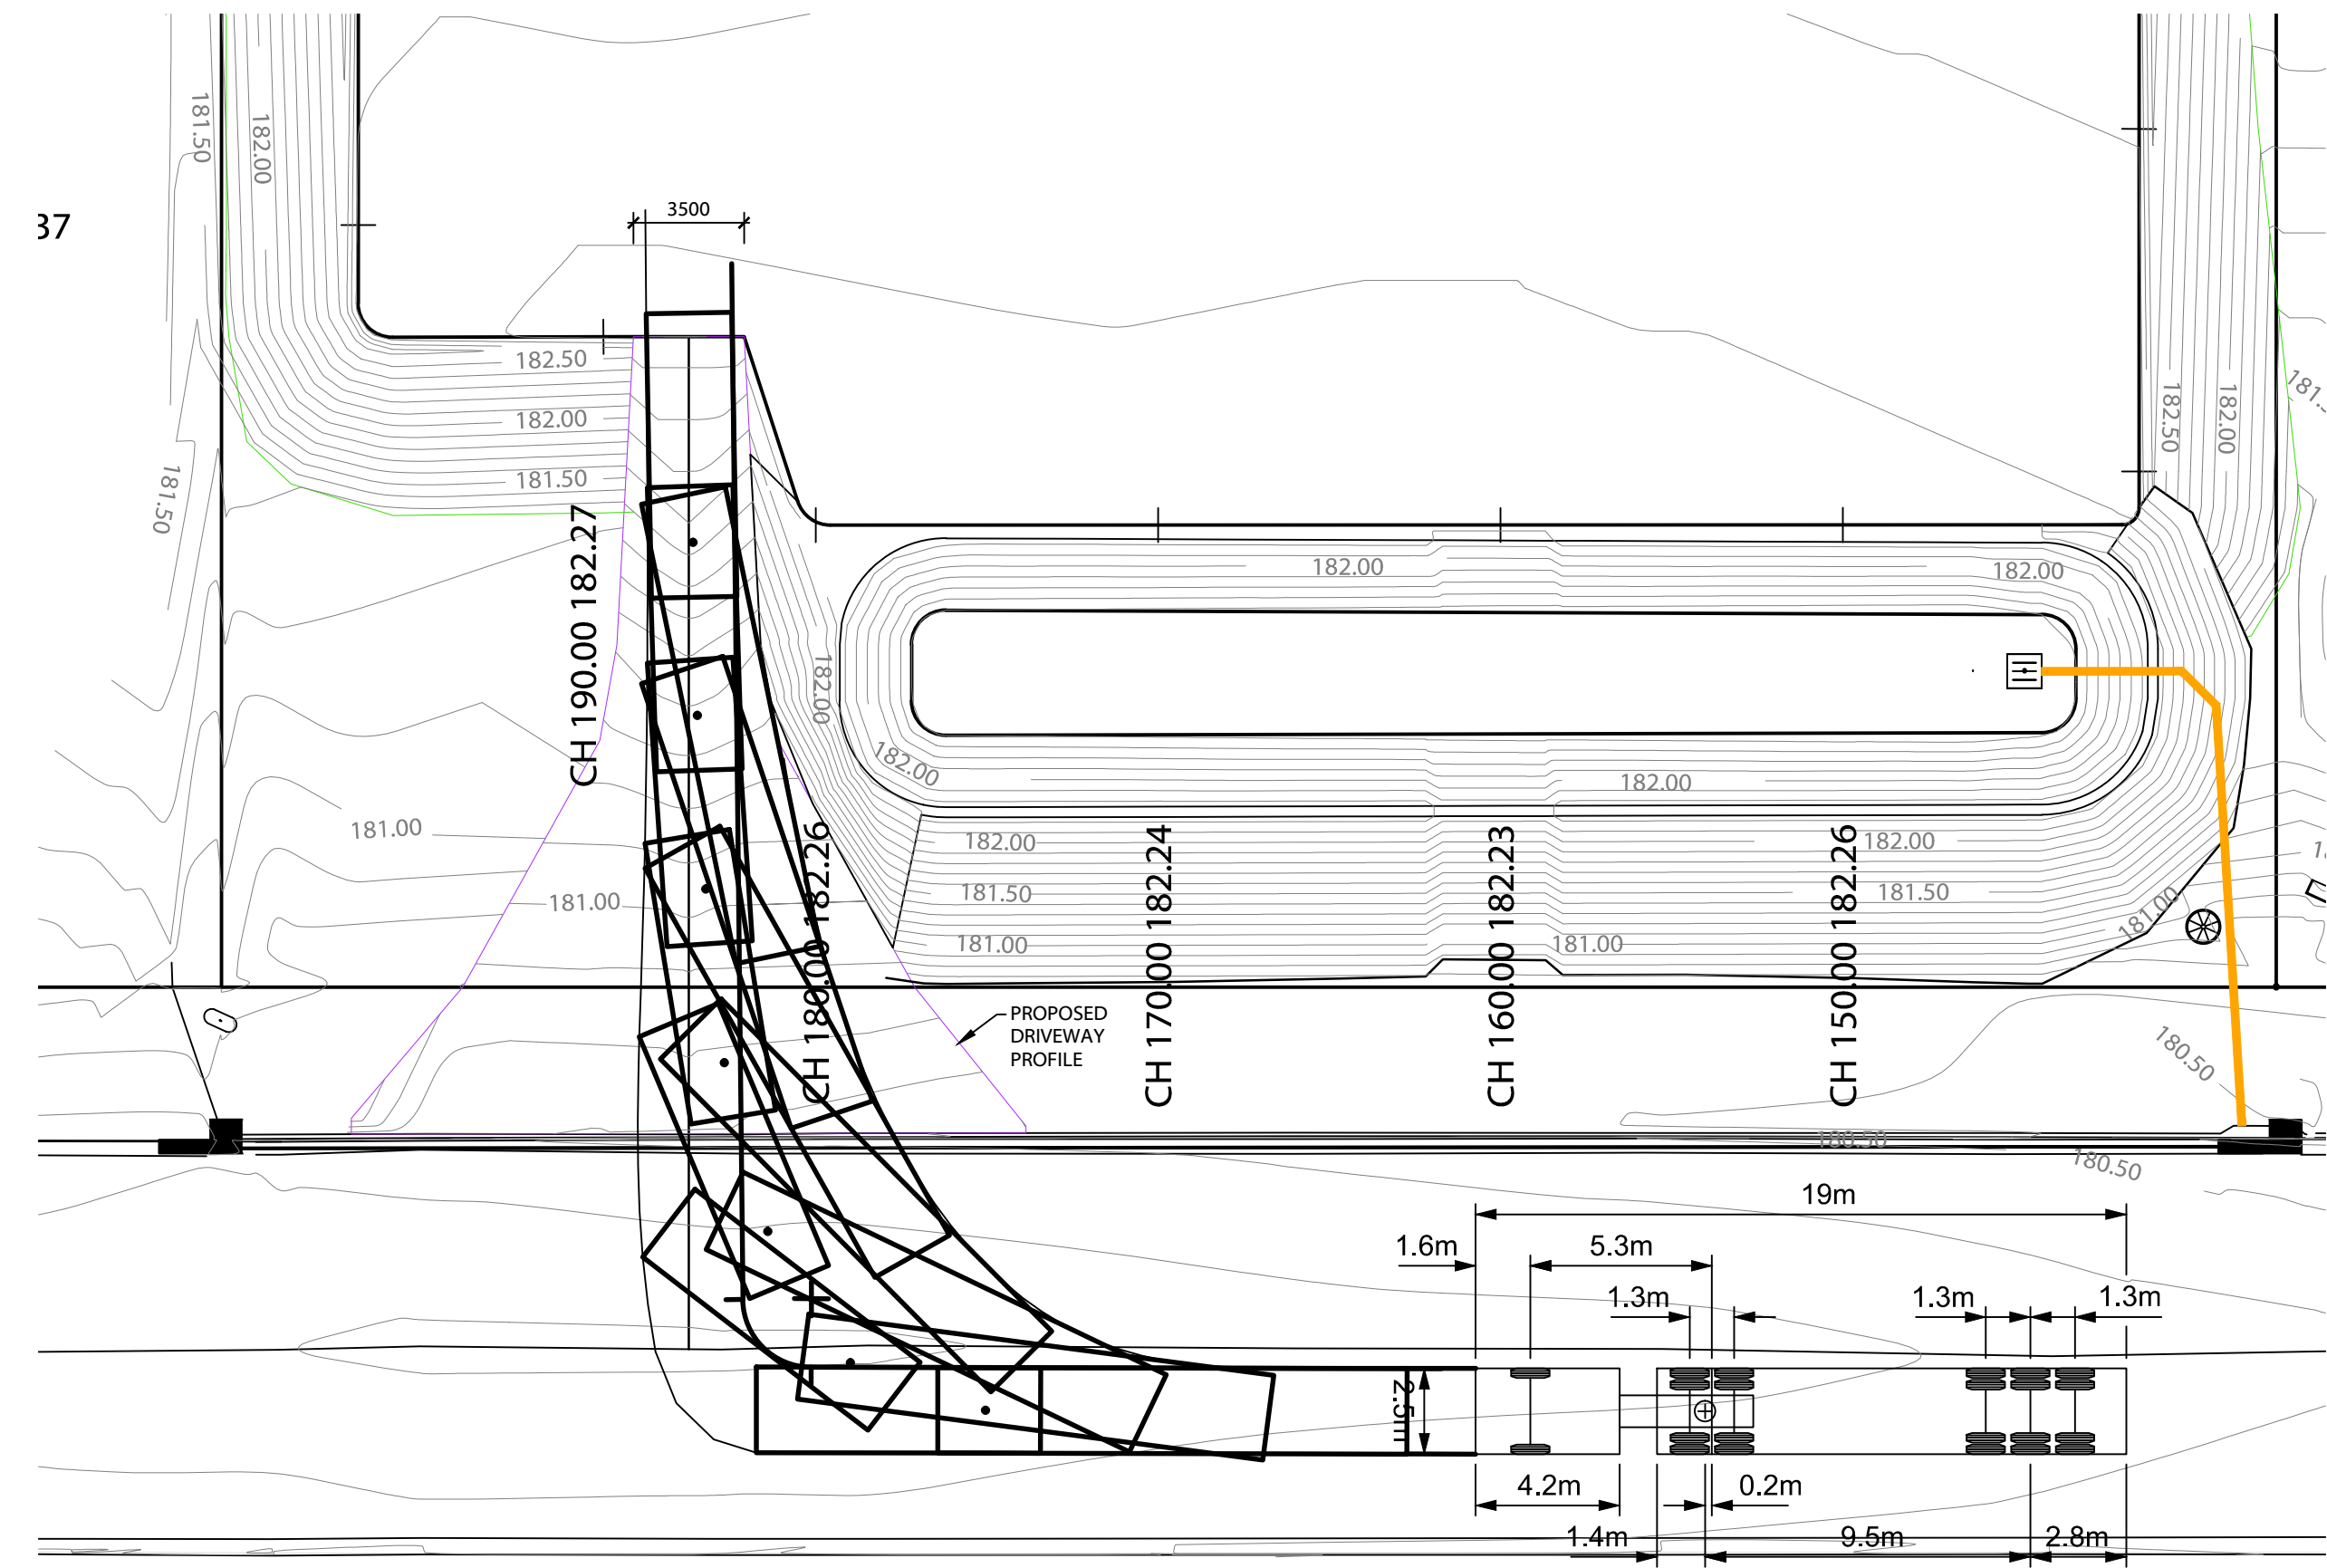
- CONCRETE STRENGTH TO BE 32MPa AT 28 DAYS.

[illegible]

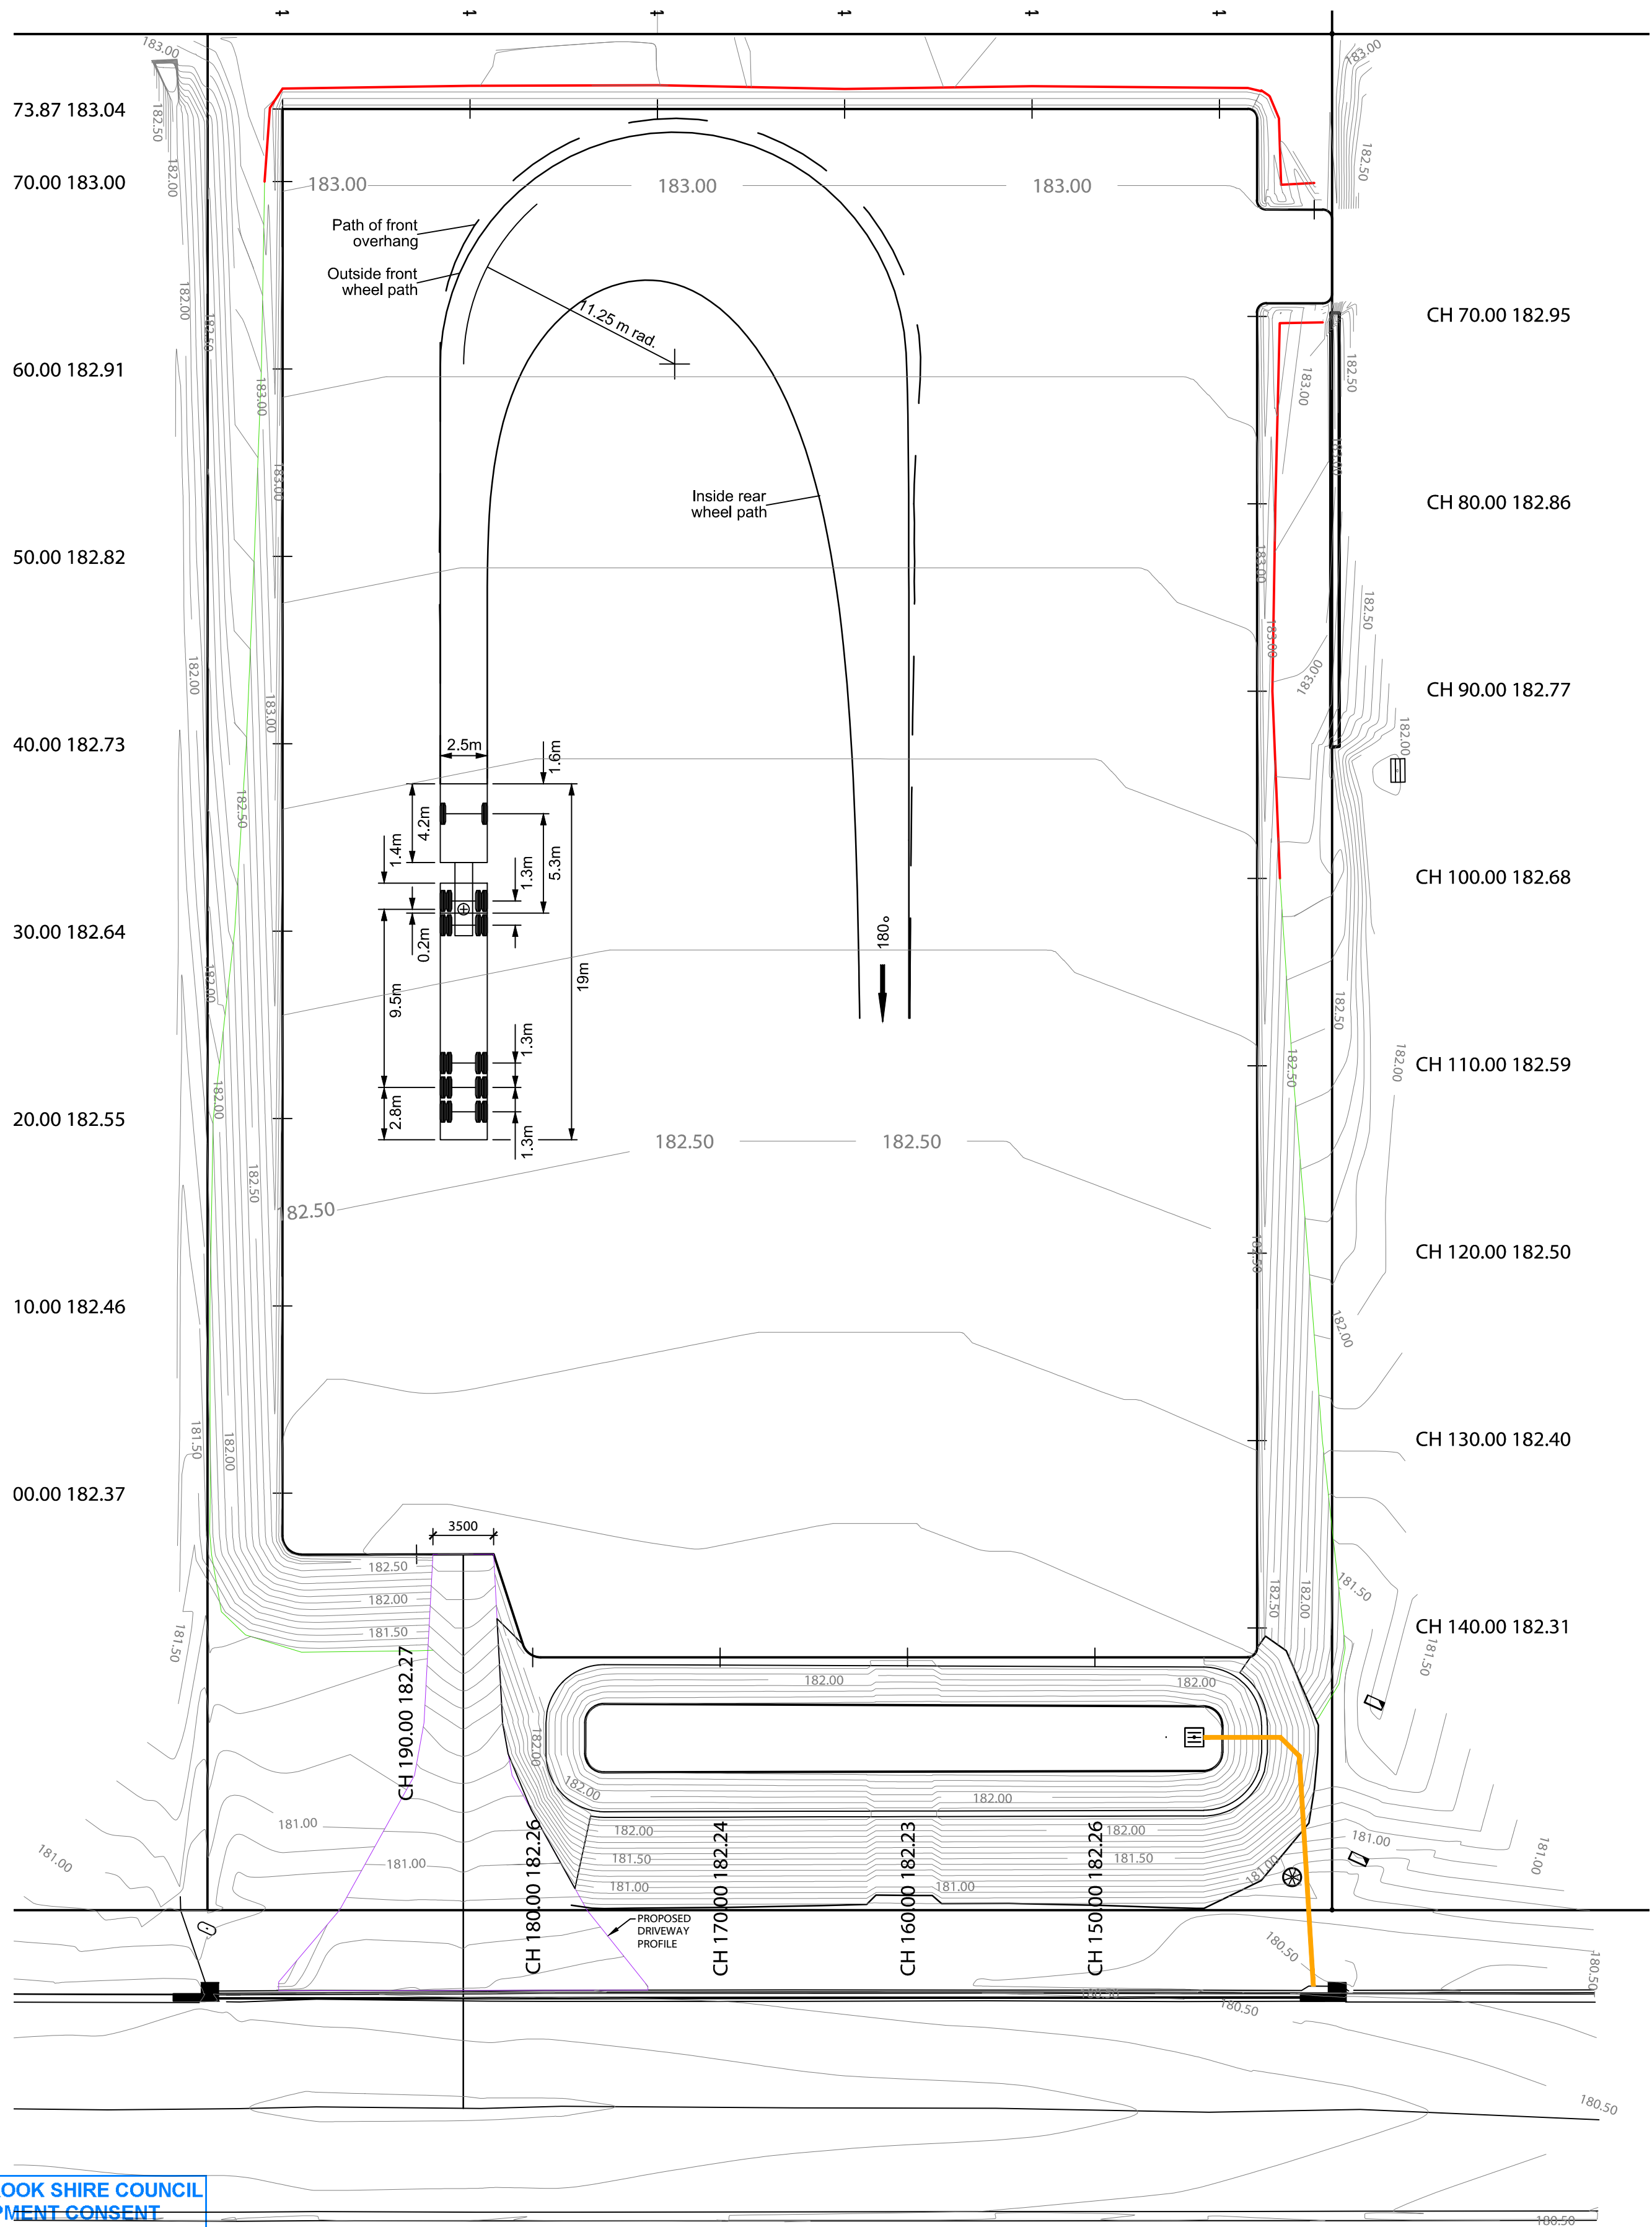




TURNING TEMPLATE - LEFT IN  
SCALE: 1:200 (A1)



TURNING TEMPLATE - RIGHT IN  
SCALE: 1:200 (A1)



TURNING TEMPLATE - U-TURN  
SCALE: 1:250 (A1)

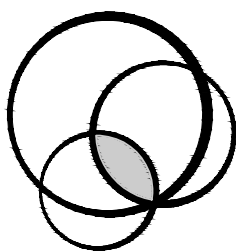
MUSWELLBROOK SHIRE COUNCIL  
DEVELOPMENT CONSENT  
This document forms part of  
Council's Notice of Determination  
DA 2020-22  
Approval Date: 22-Sep-20  
Delegated Officer: ALISA EVANS

REV	DESCRIPTION	DATE	BY	REV	DESCRIPTION	DATE	BY
B	INCREASE HARDSTAND AREA	04/02/20	BC				
A	ISSUED FOR APPROVAL	10/01/20	CH				

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c/o GRAEME RAY  
PO BOX 136  
LAMBTON, NSW, 2099

PROPOSED HARDSTAND  
38-40 ENTERPRISE CRESCENT  
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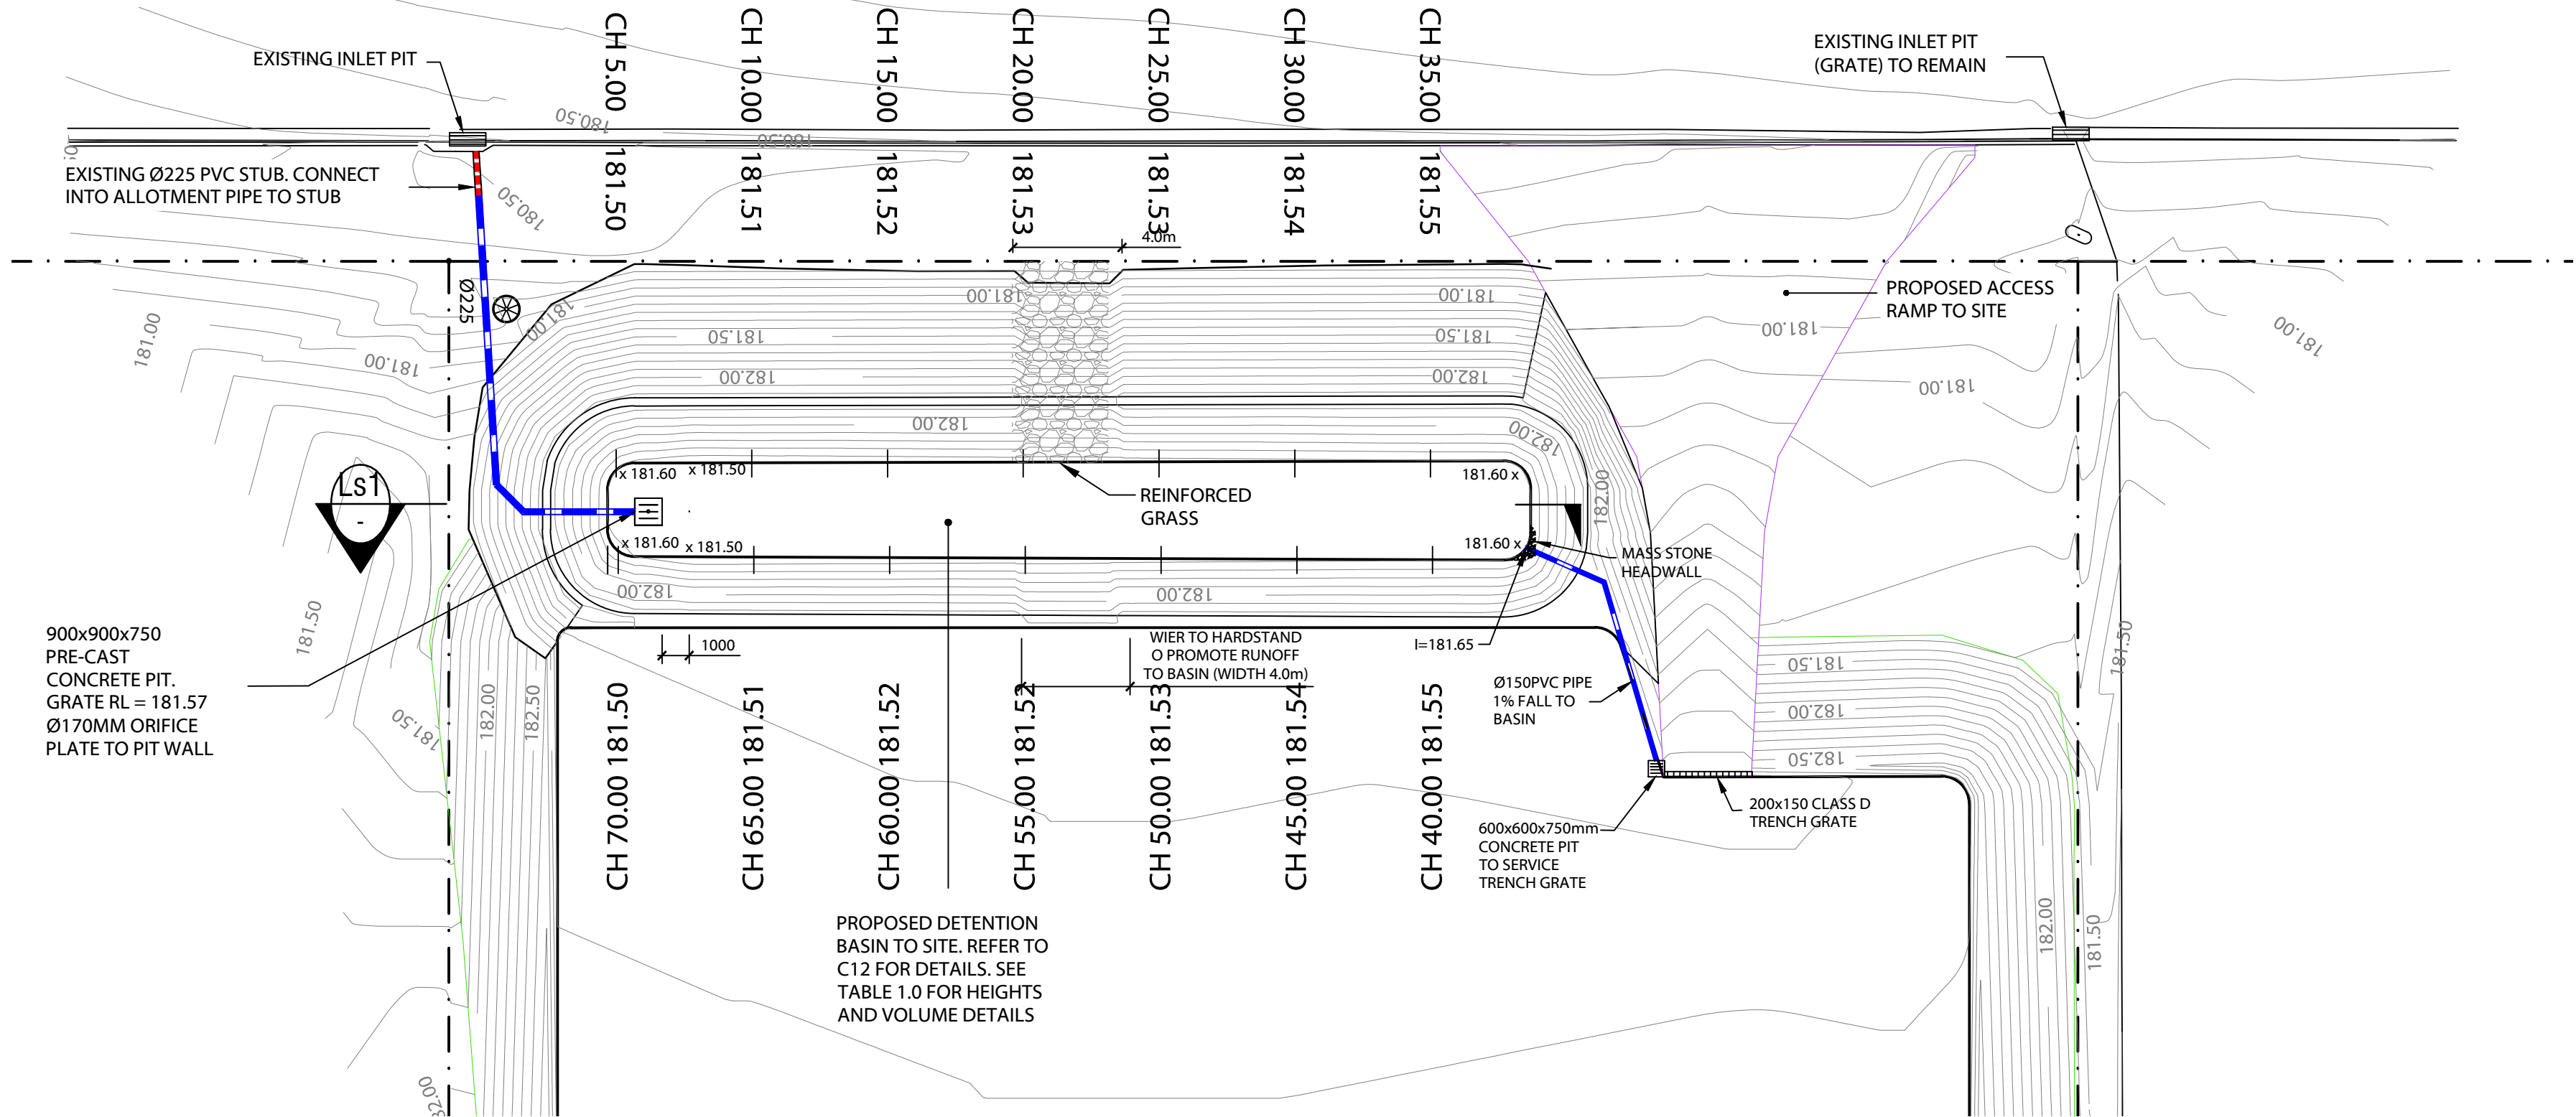
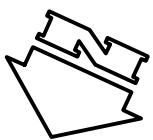
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TURNING TEMPLATE

Scale  
Horizontal:

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Designed	BH	Approved on behalf of RHM Consulting Engineers	04/02/20
Drawn	BC	Project Engineer/Director	Date
Datum	NIL	Drawing No:	Rev
Date	DEC 19	19-027-C10	B





BASIN PLAN  
SCALE: 1:200 (A1)

BASIN VOLUME		
RL	AREA (m <sup>2</sup> )	VOLUME (m <sup>3</sup> )
181.50	0	0
181.60	118.35	8.35
181.70	139.27	21.23
181.80	160.68	36.22
181.90	182.57	53.38
182.00	204.95	72.75
182.10	227.81	94.38
182.20	250.61	118.32
182.25	261.85	131.13

TABLE 1.0: BASIN VOLUME

STORMWATER CALCULATION

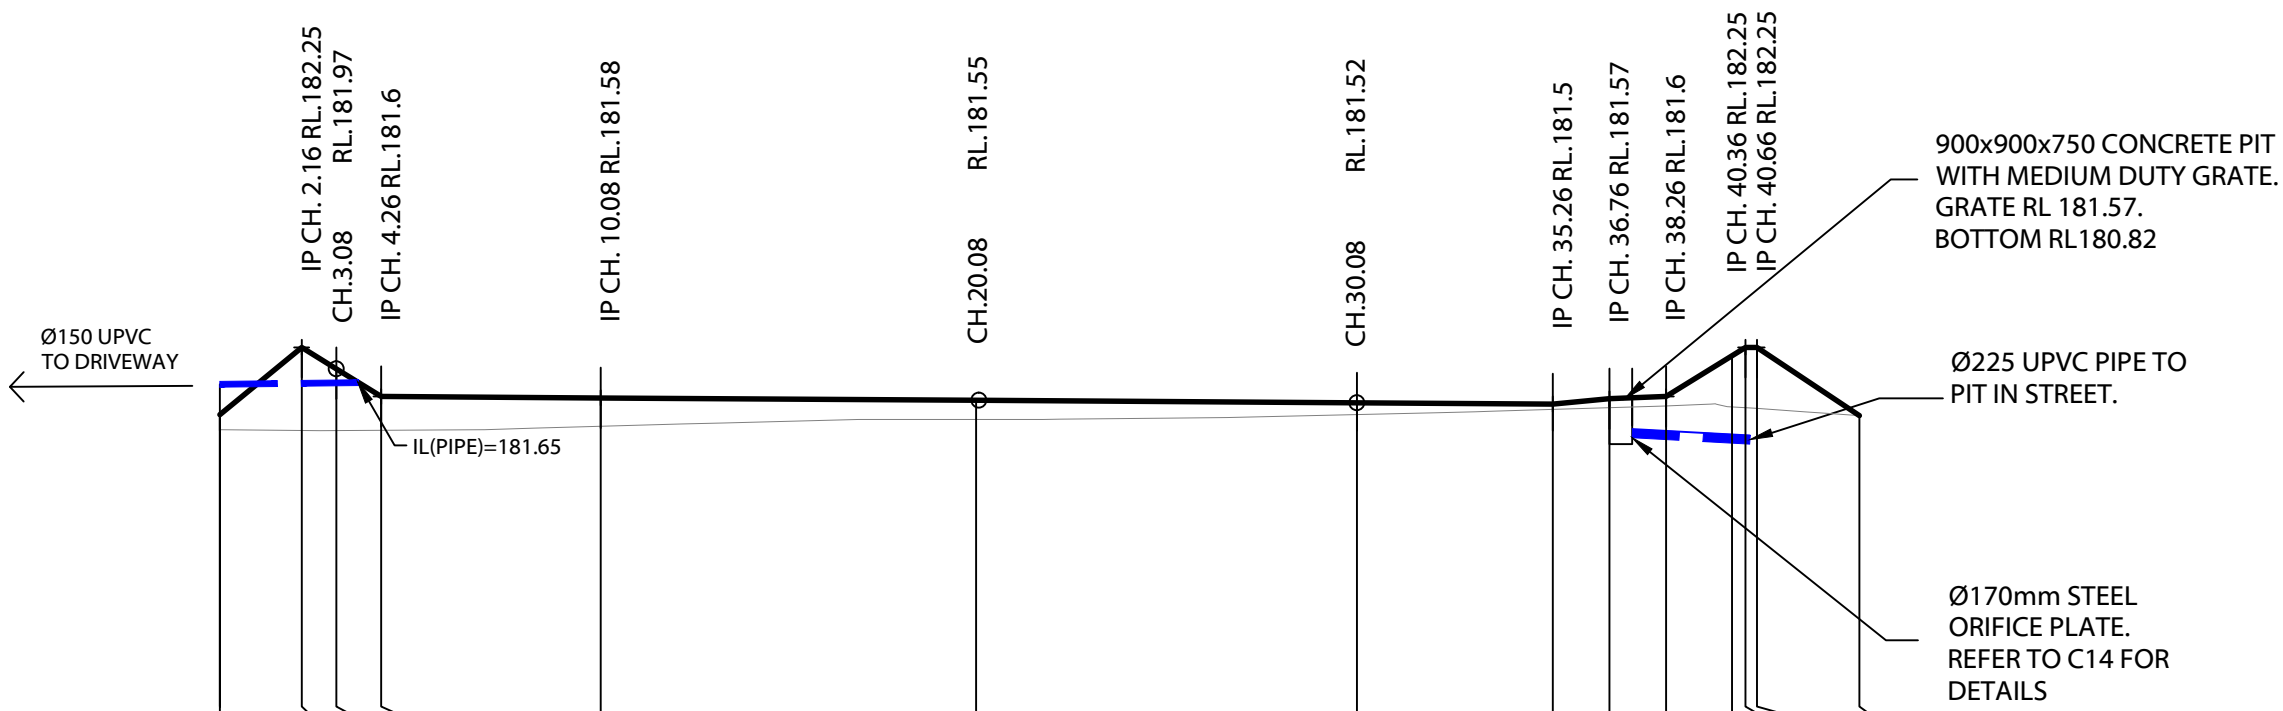
- TOTAL SITE AREA = 6008m<sup>2</sup>
- PERVIOUS AREA = 2108m<sup>2</sup> (35%)
- IMPERVIOUS AREA = 3900m<sup>2</sup> (65%)
- PERMISSIBLE SITE DISCHARGE = 0.106m<sup>3</sup>/sec/hectare  
= 0.106 x 0.6008  
= 0.0063m<sup>3</sup>/sec  
= 63.6 litre/sec
- PROPOSED BASIN VOLUME: REFER TO TABLE 1.0
- STORAGE AND WATER LEVELS IN BASIN WITH Ø170 ORIFICE OUTLET TO ENSURE PSD IS NOT EXCEEDED. SHOWN IN TABLE 2.0.
- FOR STORMS IN EXCESS OF 100 ARI, A WEIR HAS BEEN PROVIDED. THE HEIGHT OF THE WEIR IS RL 182.15 I.E AT THE 100 ARI WATER LEVEL.
- THE PROPOSED WEIR AND OPEN CHANNEL DOWN STREAM OF THE WEIR HAS BEEN DESIGNED FOR 0.244 m<sup>3</sup>/sec.  
WEIR DESIGN:  
- Q<sub>100</sub> = 0.244  
- W = 4.0 (BASED ON 1 IN 3)  
- COEFF = 2.0  
- REQUIRED HEAD (H) = 95mm (182.25 TOP OF BANK)  
- WEIR HEIGHT = 182.15  
- WATER HEIGHT = 182.245

STORM EVENT	OUTLET FLOW (m <sup>3</sup> /SEC)	REQUIRED VOLUME	CRITICAL STORM EVENT	WATER LEVEL	GENERATED FLOWRATE POST DEVELOPMENT (m <sup>3</sup> /SEC)	PRE-DEVELOPMENT FLOWRATE (m <sup>3</sup> /SEC)
100 ARI	0.063	105m <sup>3</sup>	25min	182.16	0.253	0.179
50 ARI	0.061	84m <sup>3</sup>	25min	182.07	0.218	0.143
20 ARI	0.06	43m <sup>3</sup>	25min	181.87	0.197	0.118
10 ARI	0.059	38m <sup>3</sup>	25min	181.85	0.165	0.085
5 ARI	0.058	34m <sup>3</sup>	25min	181.81	0.138	0.064

TABLE 2.0: STORMWATER CHARACTERISTICS

LEGEND

- DENOTES EXISTING GRATE AND PIT TO ENTERPRISE CRESCENT
- DENOTES EXISTING GRATED INLET PIT WITH ENTRY TO ENTERPRISE CRESCENT. PIT HAS AN EXISTING Ø225 PVC STUB.



Vertical Curve Length (m)										
Vertical Curve Radius (m)										
DATUM R.L.177.00										
CUT/FILL DEPTH		0.202								
DESIGN LEVELS ON BASIN CENTRELINE		181.562	182.25	181.967	181.6	181.592	181.55	181.517	181.5	181.498
EXISTING SURFACE ALONG BASIN CENTRELINE		181.16	181.15	181.15	181.15	181.21	181.3	181.36	181.43	181.45
CHAINAGE ALONG BASIN CENTRELINE	0	2.16	3.08	4.26	10.08	20	30.08	35.26	36.76	38.26

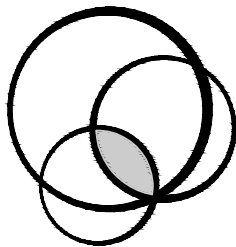
LONGSECTION CENTRELINE OF DETENTION BASIN  
HORIZONTAL SCALE 1:200 (A1)  
VERTICAL SCALE 1:100 (A1)

REV	DESCRIPTION	DATE	BY	REV	DESCRIPTION	DATE	BY
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WILLFAB SUPERFUND  
c/o GRAEME RAY  
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PROPOSED HARDSTAND  
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ABN 82 153 018 800

BASIN PLAN  
AND LONGSECTION

Scale  
Horizontal:

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Designed	BH	Approved on behalf of RHM Consulting Engineers	05/08/20
Drawn	CH	Project Engineer/Director	Date
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Date	JULY 20	19-027-C11	D

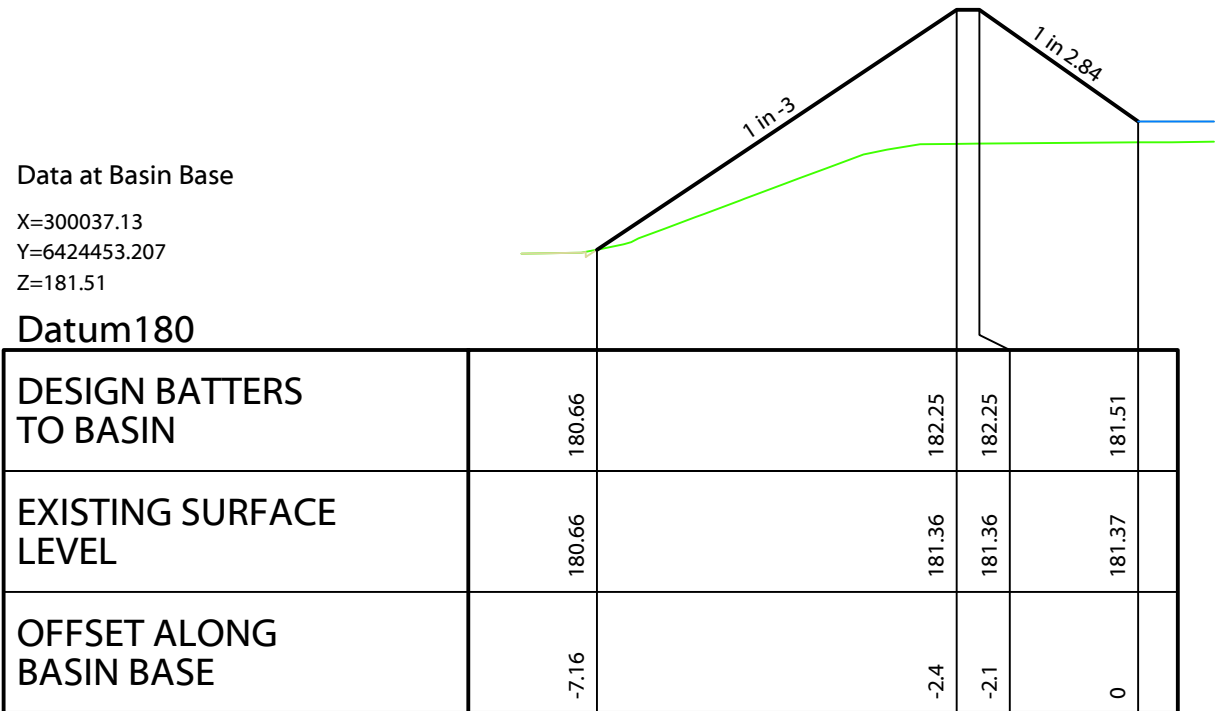


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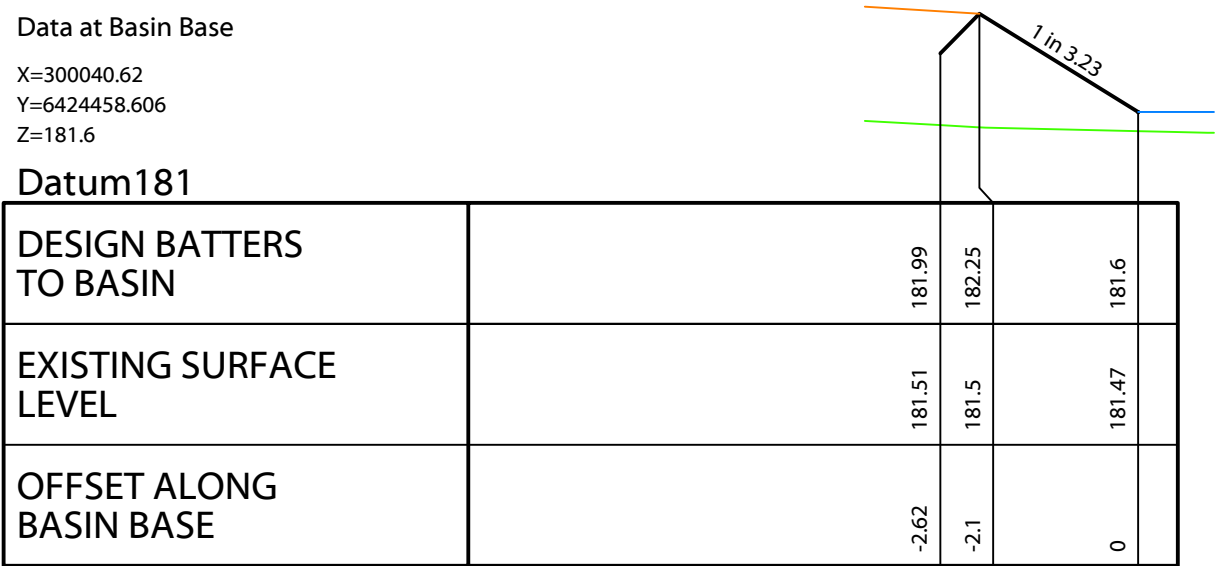
- GRAVEL HARDSTAND AREA
- EXISTING SURFACE LEVELS
- FLOOR TO DETENTION BASIN



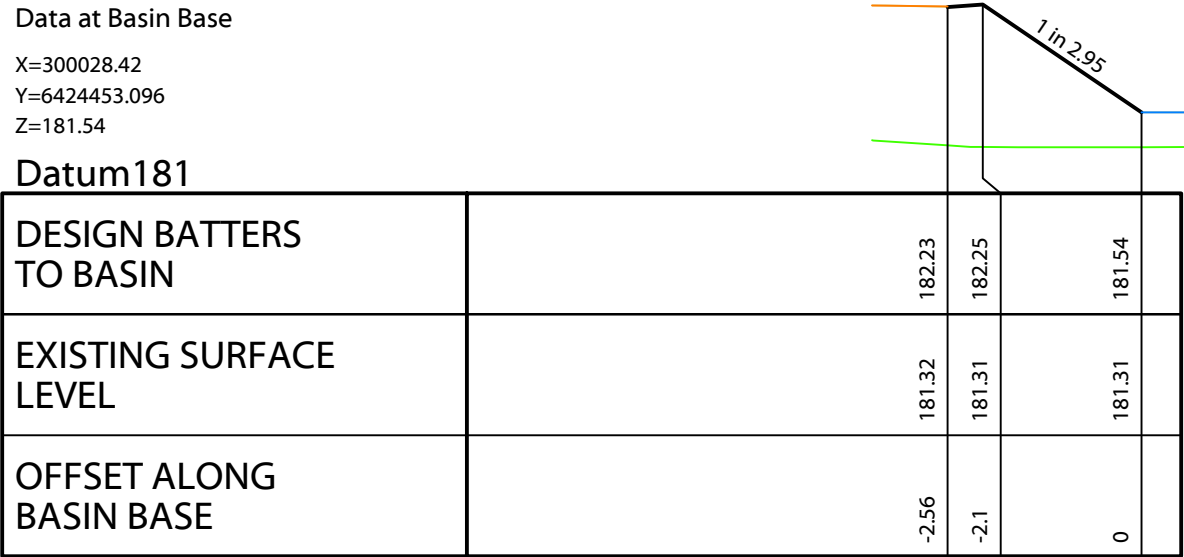
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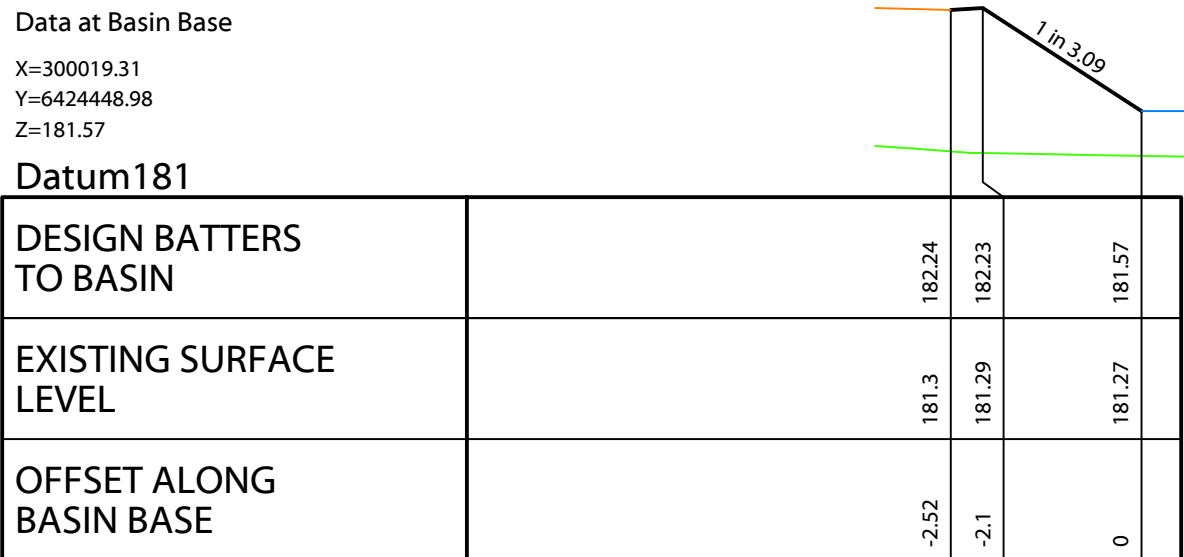
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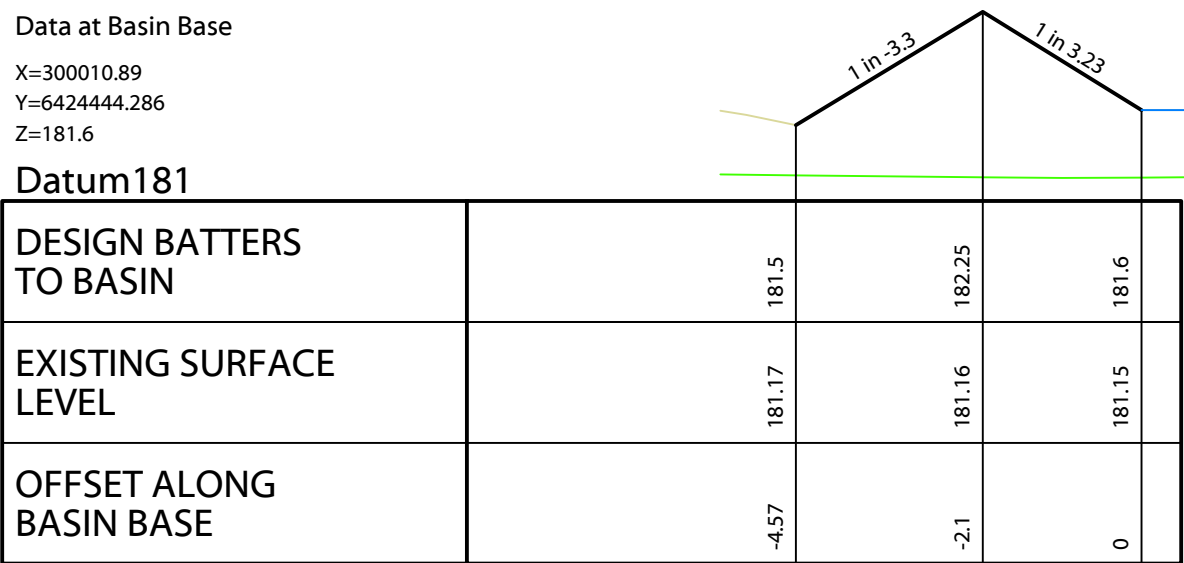
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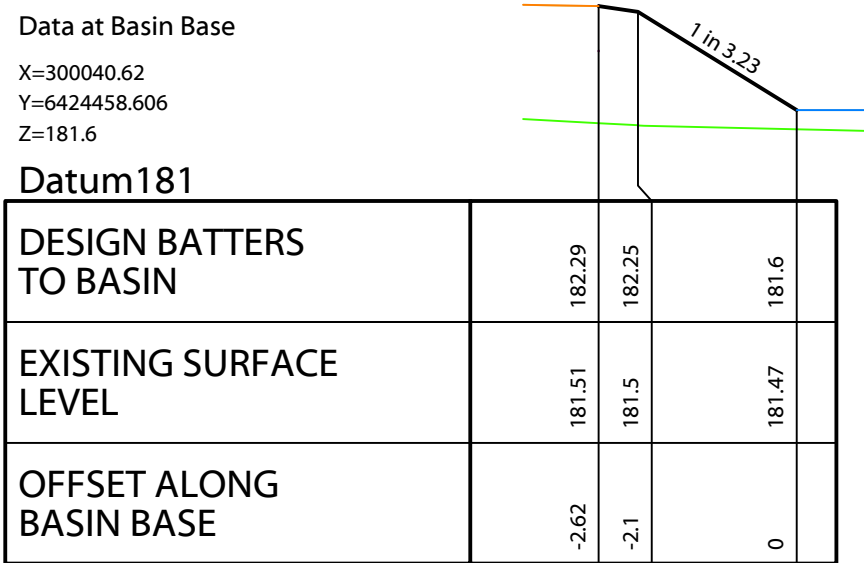
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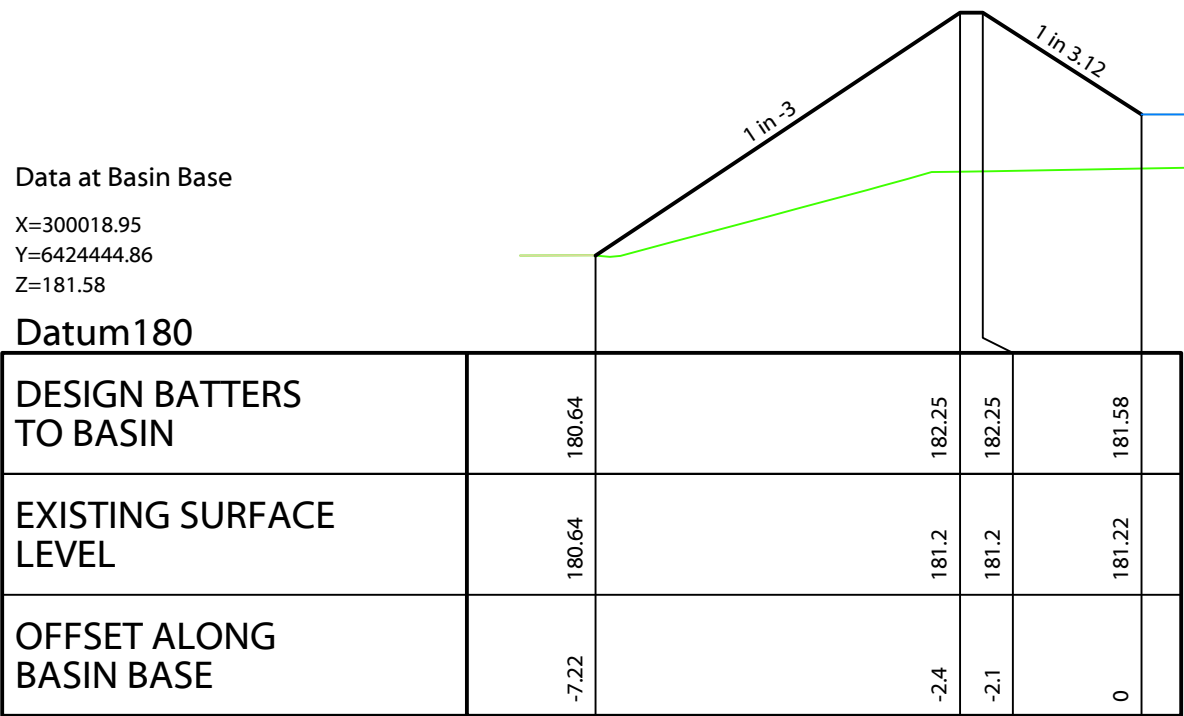
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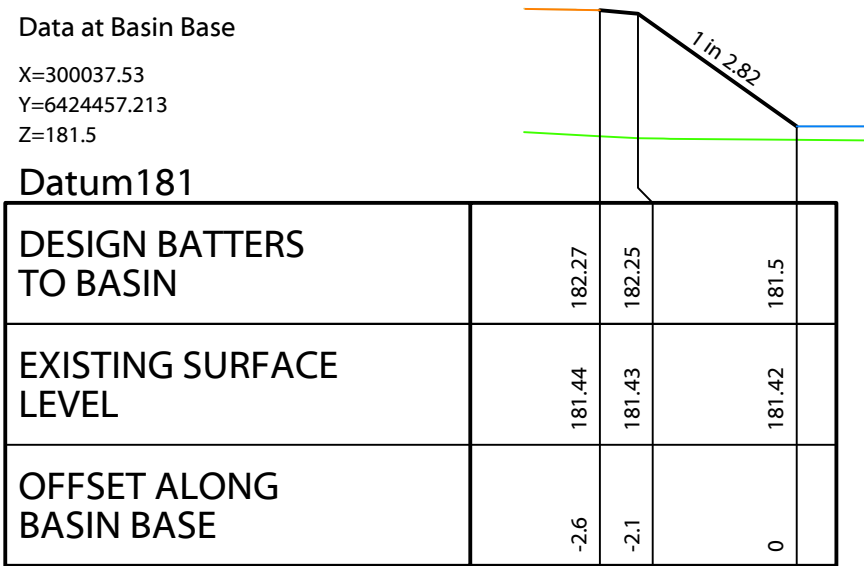
CHAINAGE 40.000



CHAINAGE 73.383



CHAINAGE 30.000



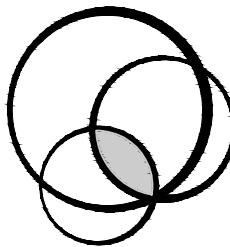
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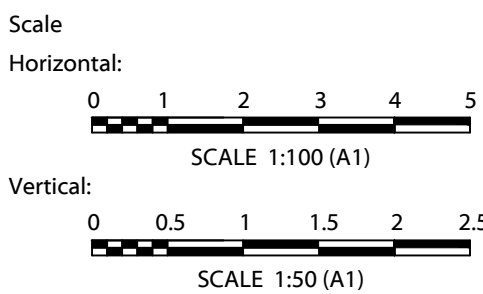
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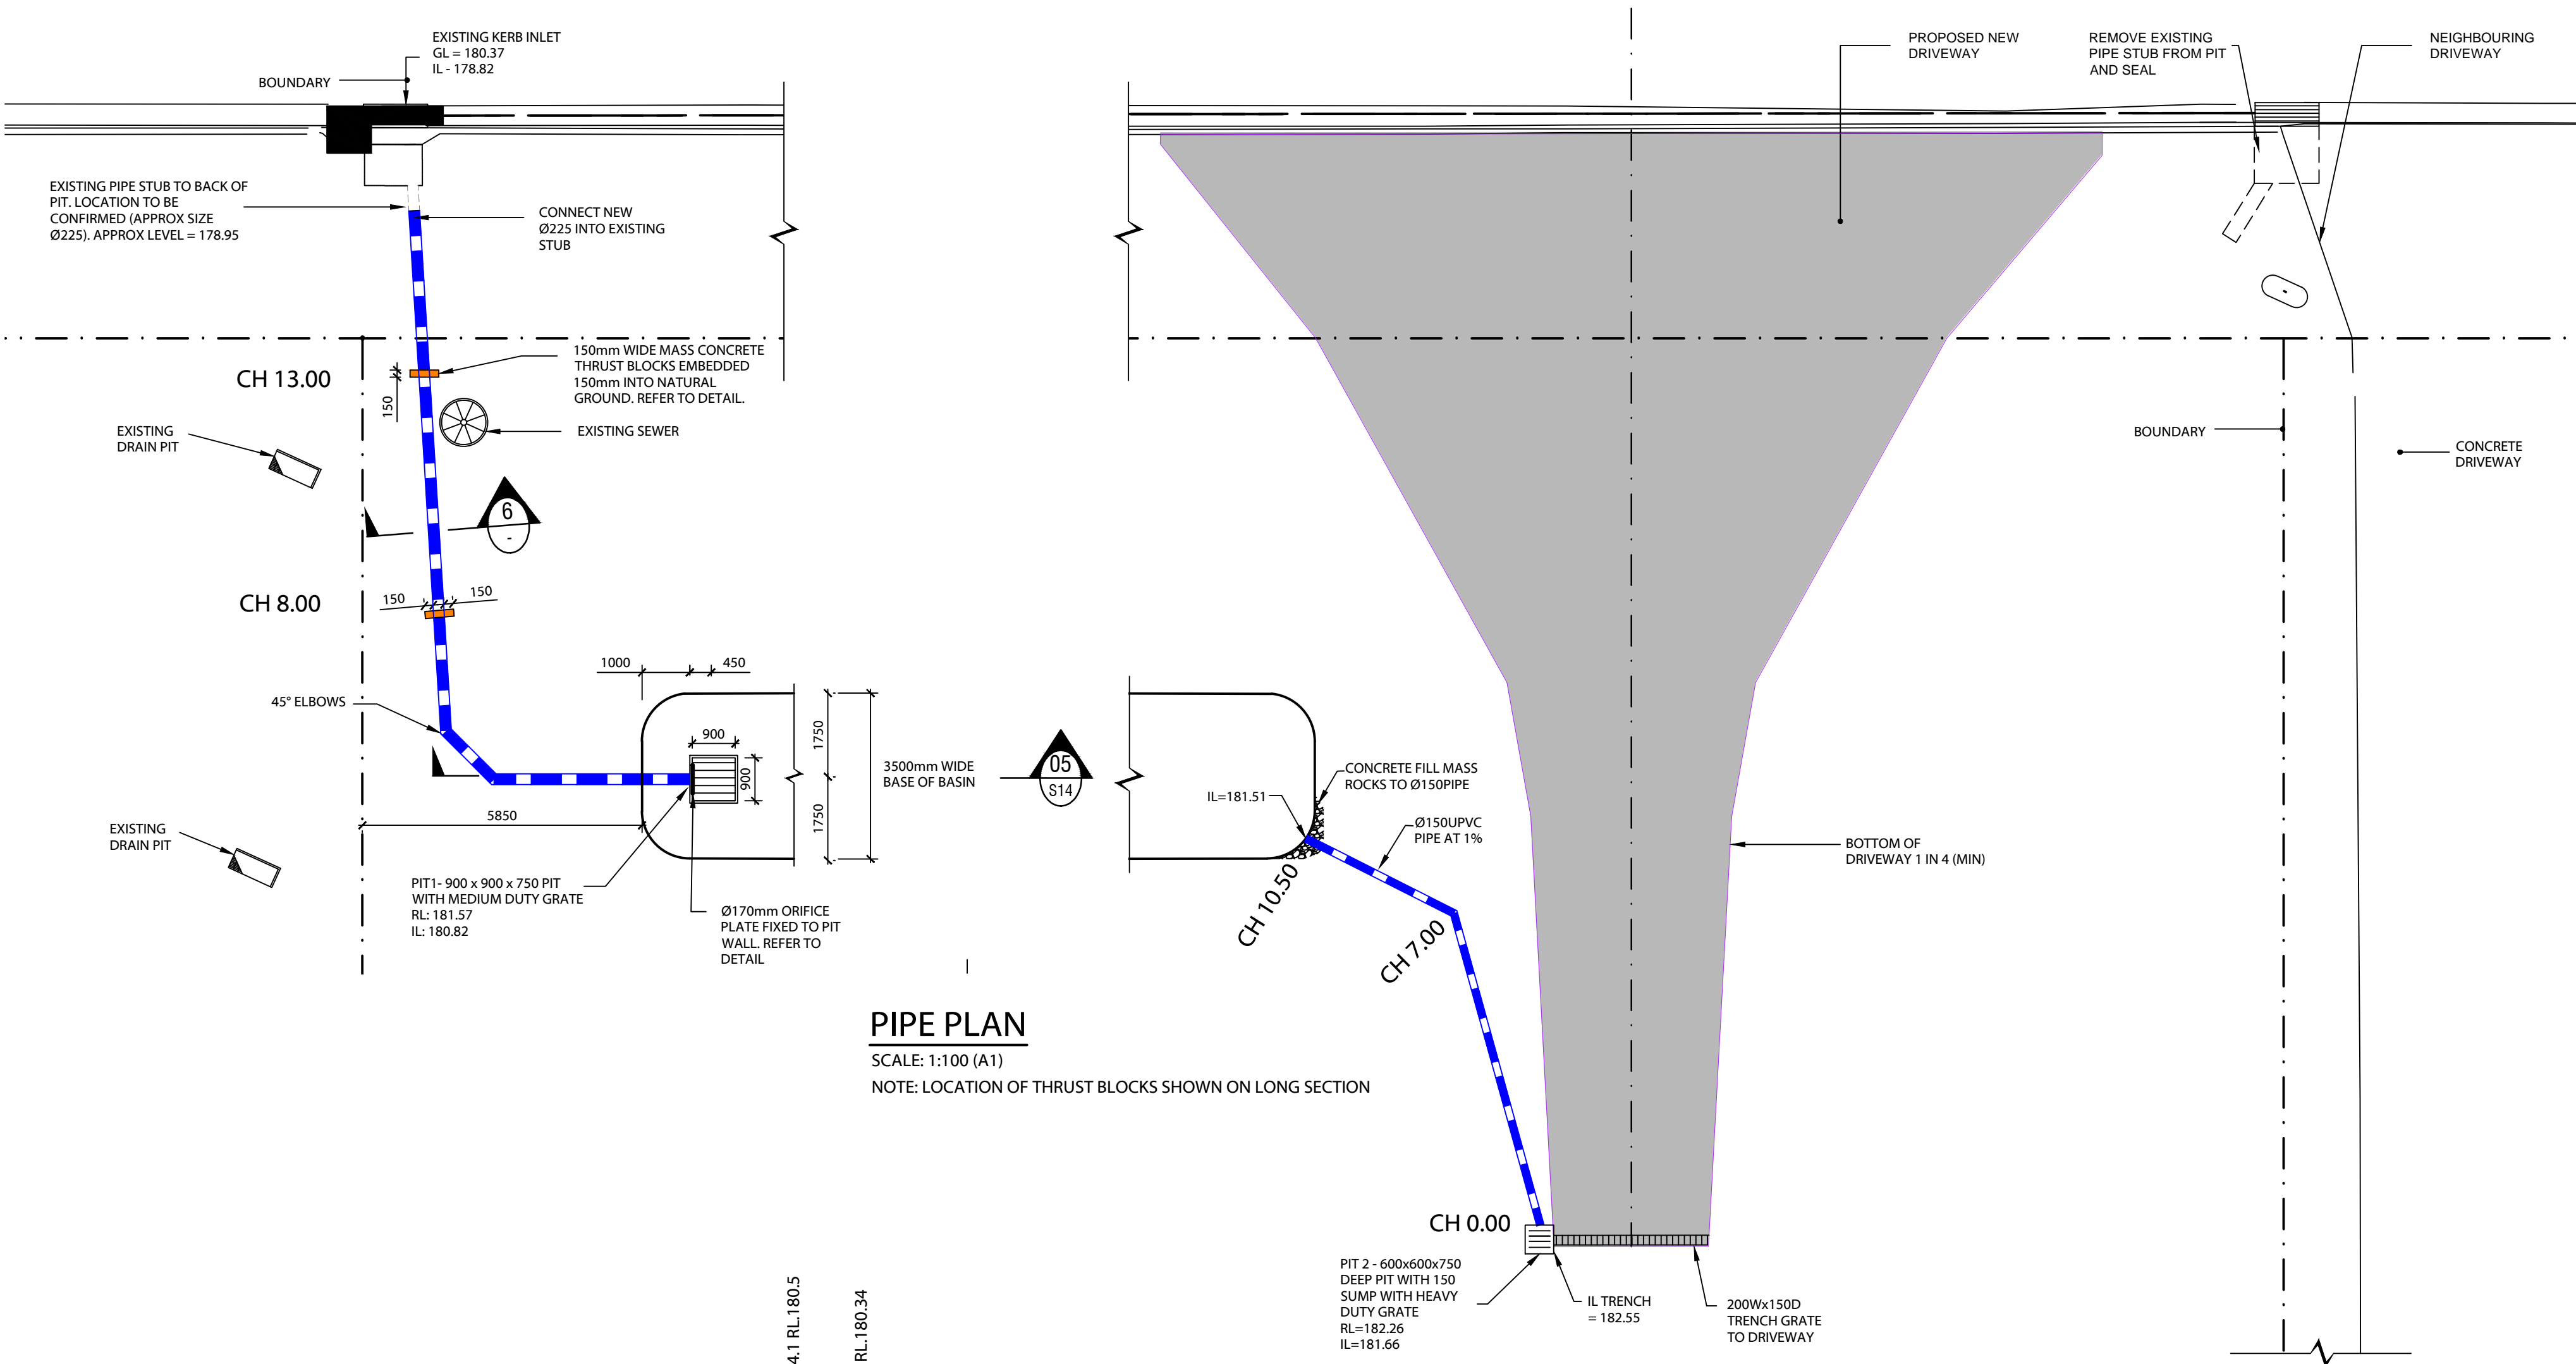
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ABN 82 153 018 800

BASIN CROSS SECTIONS  
SHEET 1



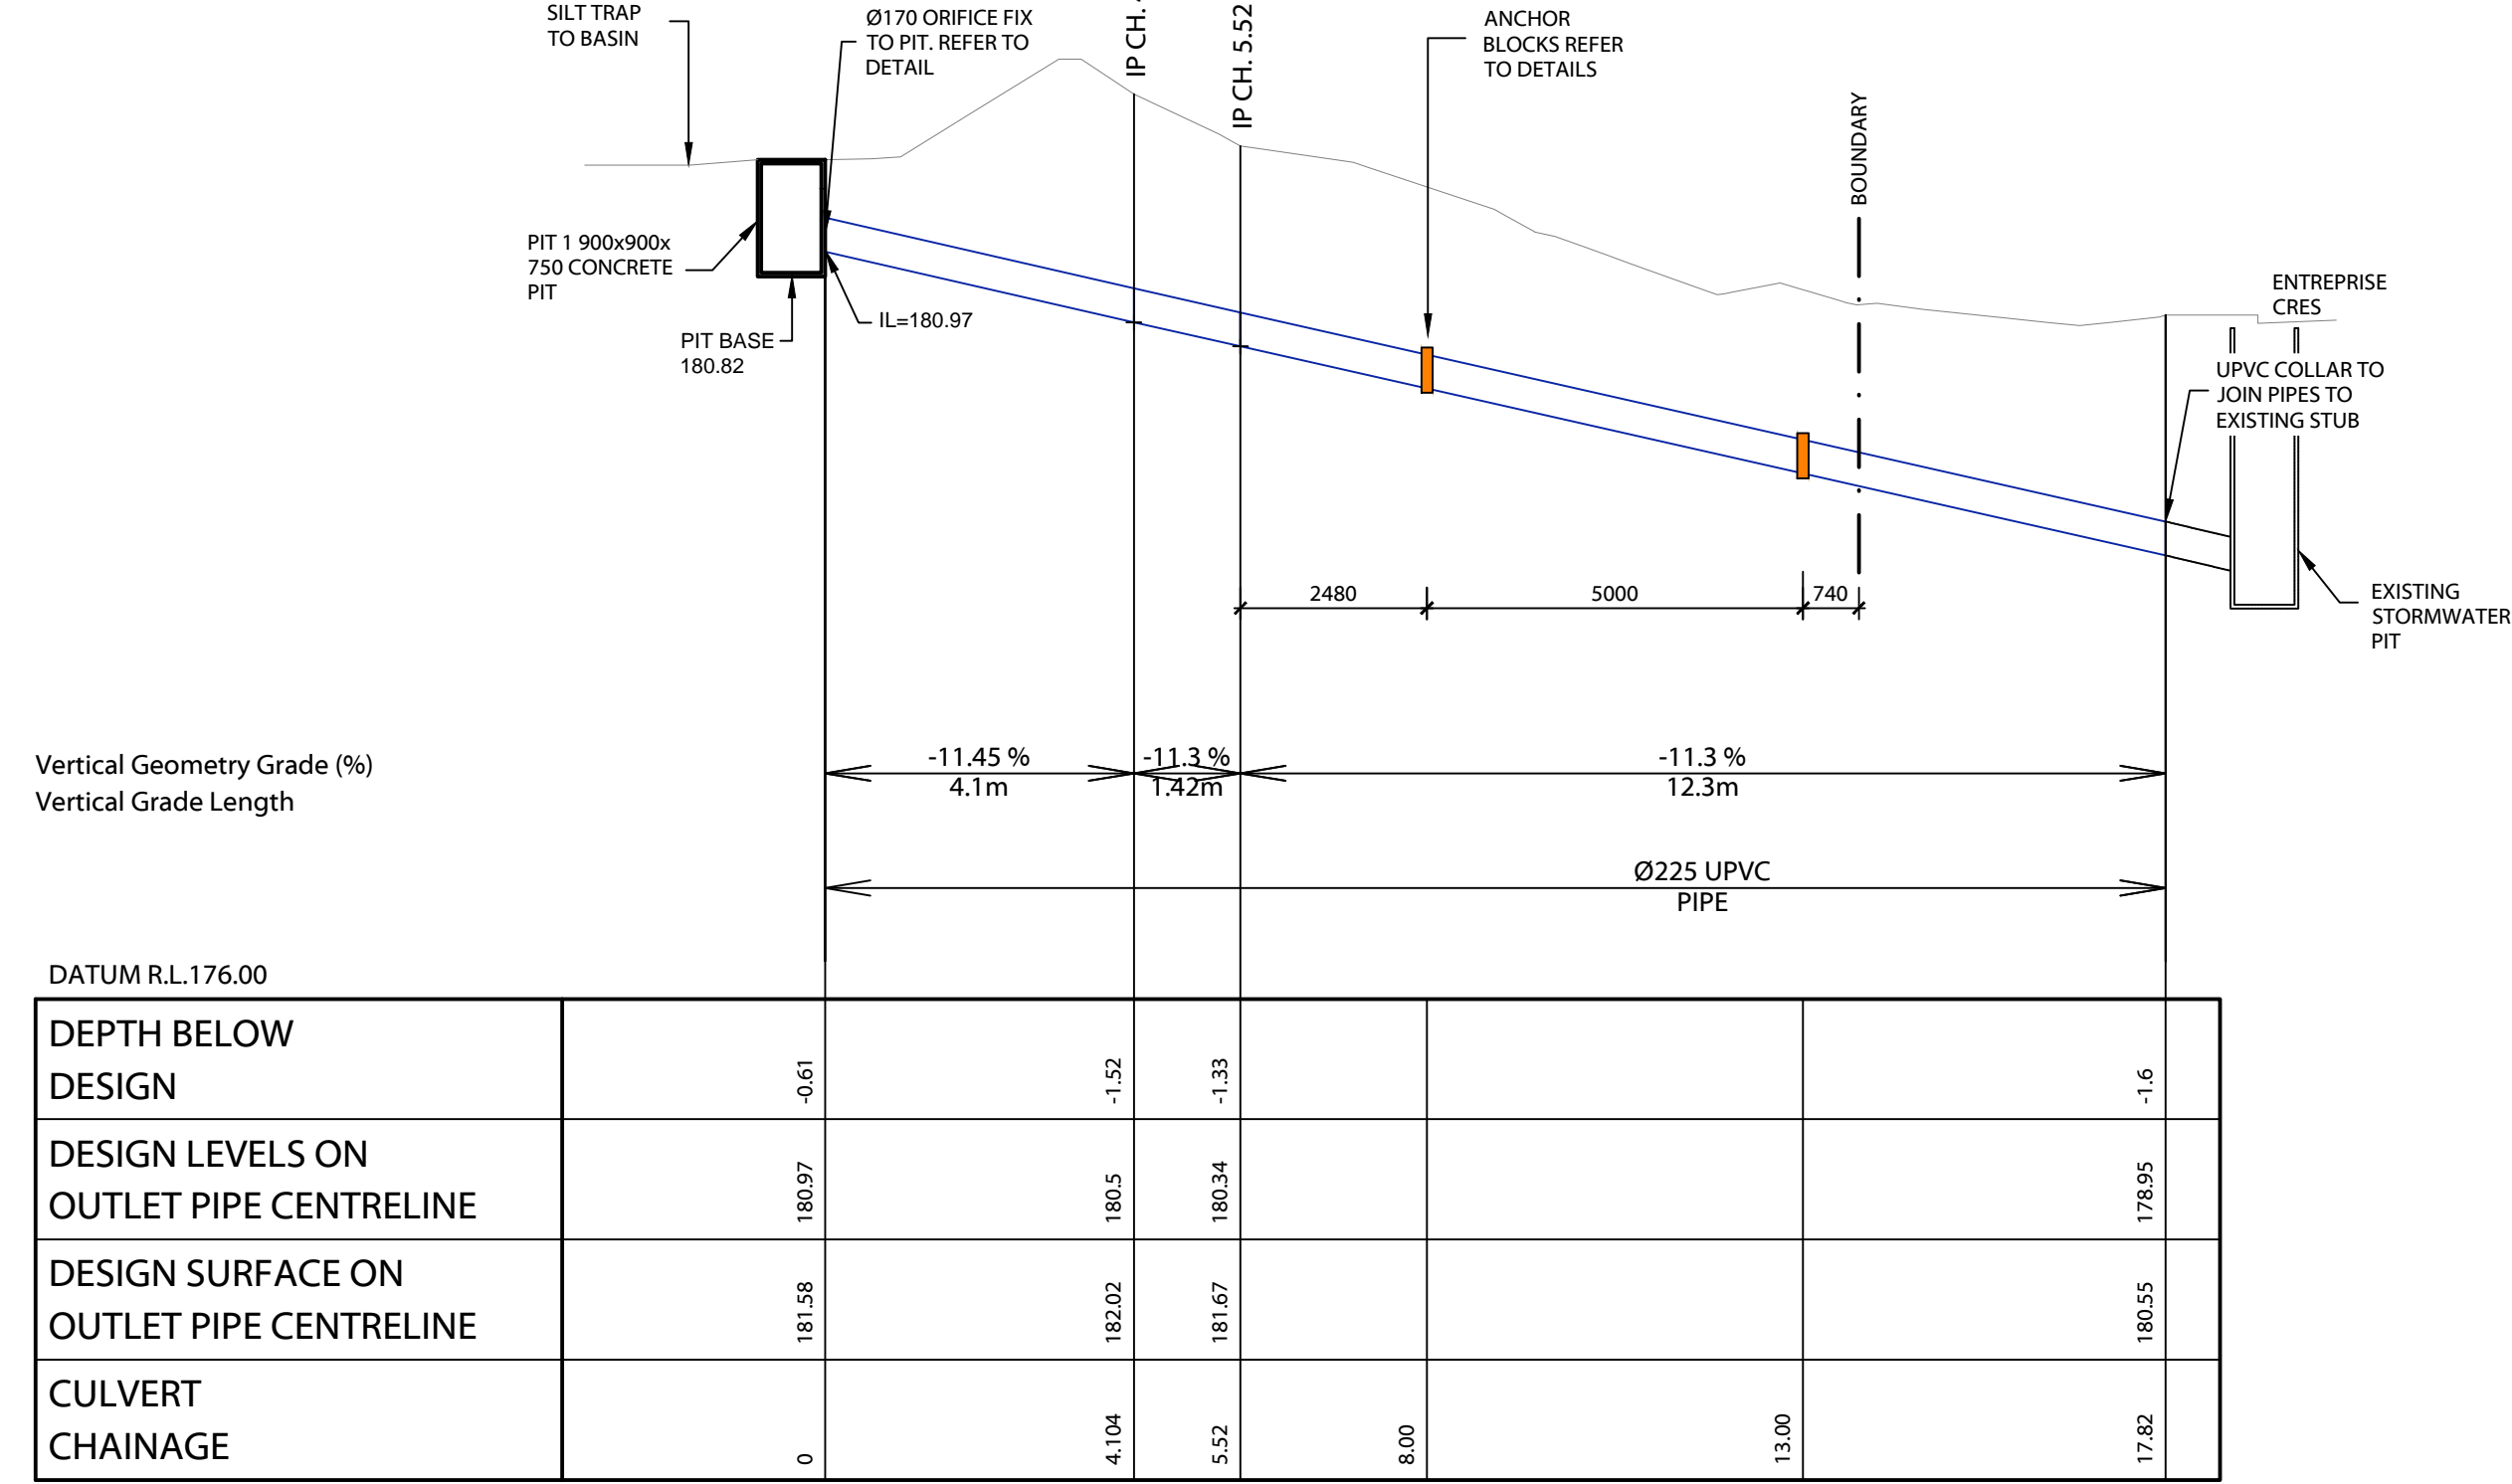
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Designed	BH	Approved on behalf of RHM Consulting Engineers			
Drawn	CH	Project Engineer/Director			
Datum	NIL	Drawing No:			
Date	JULY 20	19-027-C12			
		Rev			
		C			





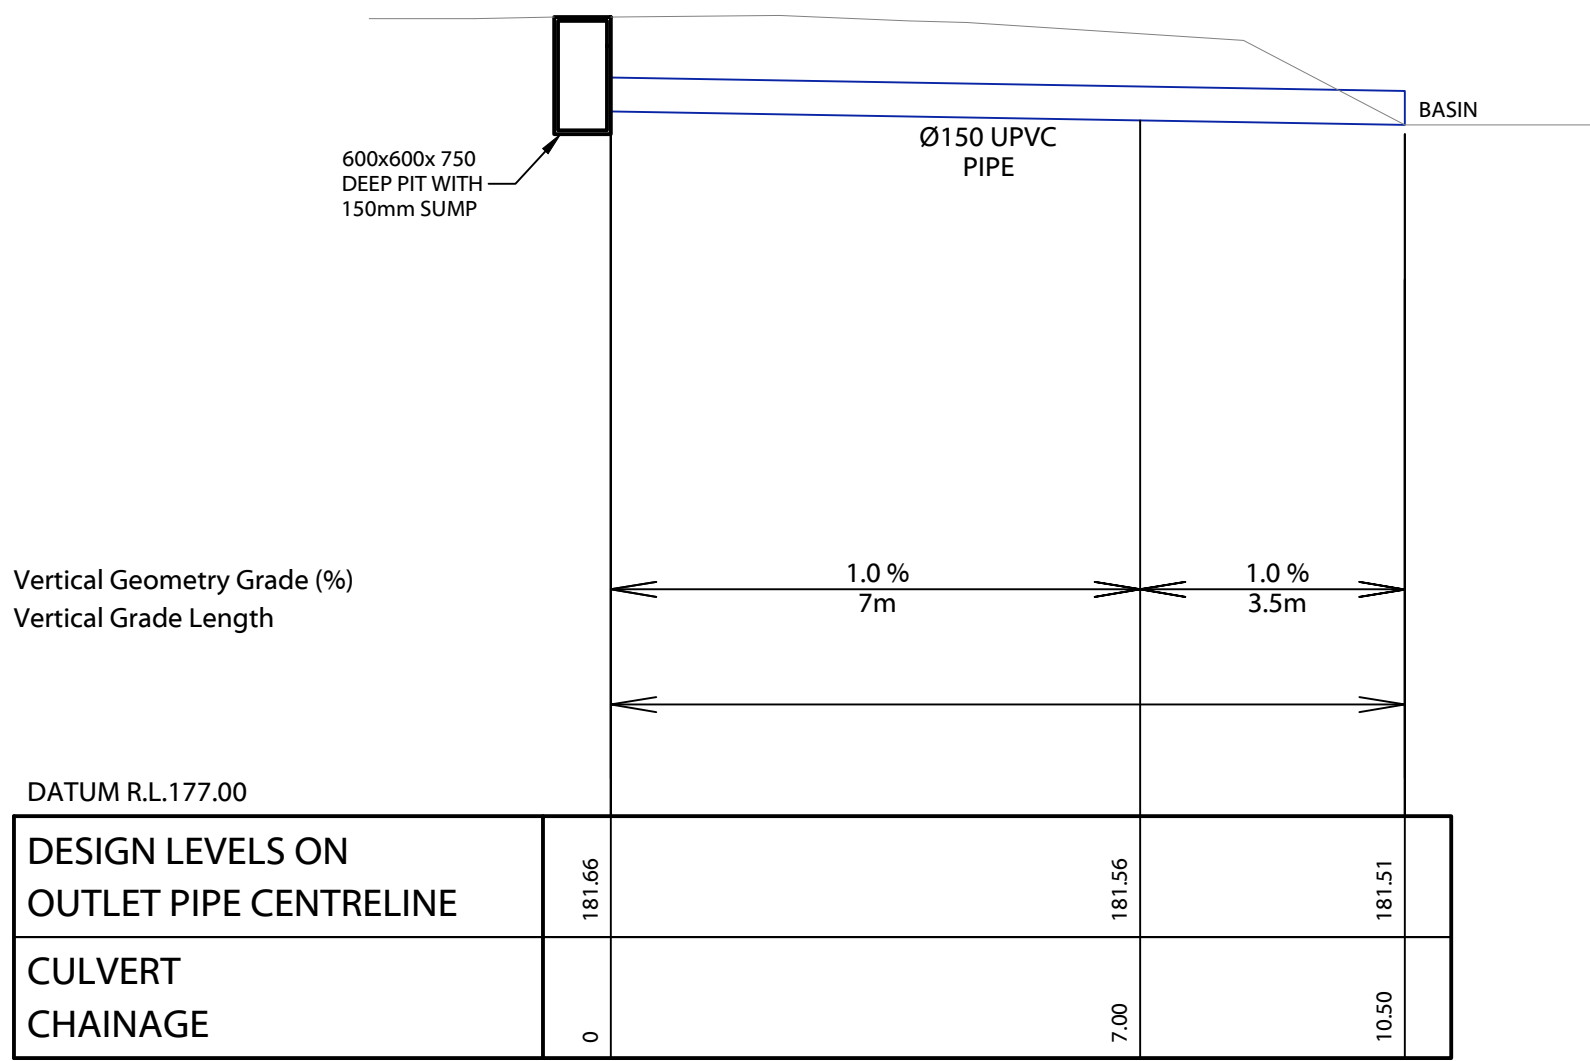
PIPE PLAN

SCALE: 1:100 (A1)  
NOTE: LOCATION OF THRUST BLOCKS SHOWN ON LONG SECTION



LONGSECTION: Outlet Pipe (Ø225mm) From Basin

HORIZONTAL SCALE 1:100 (A1)  
VERTICAL SCALE 1:50 (A1)



LONGSECTION: Outlet Pipe (Ø150mm) From DRIVEWAY

HORIZONTAL SCALE 1:100 (A1)  
VERTICAL SCALE 1:50 (A1)

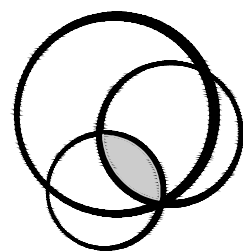
MUSWELLBROOK SHIRE COUNCIL  
DEVELOPMENT CONSENT  
This document forms part of  
Council's Notice of Determination  
  
DA 2020-22  
Approval Date: 22-Sep-20  
Delegated Officer: ALISA EVANS

REV	DESCRIPTION	DATE	BY	REV	DESCRIPTION	DATE	BY
C	ISSUED FOR APPROVAL.	05/08/20	CH				
B	INCREASED HARDSTAND AREA.	04/02/20	BC				
A	ISSUED FOR APPROVAL.	10/01/20	CH				

WILLFAB SUPERFUND  
c/o GRAEME RAY  
PO BOX 136  
LAMBTON, NSW, 2099

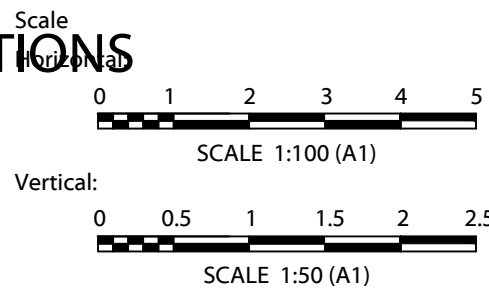
PROPOSED HARDSTAND  
38-40 ENTERPRISE CRESCENT  
MUSWELLBROOK, NSW 2333

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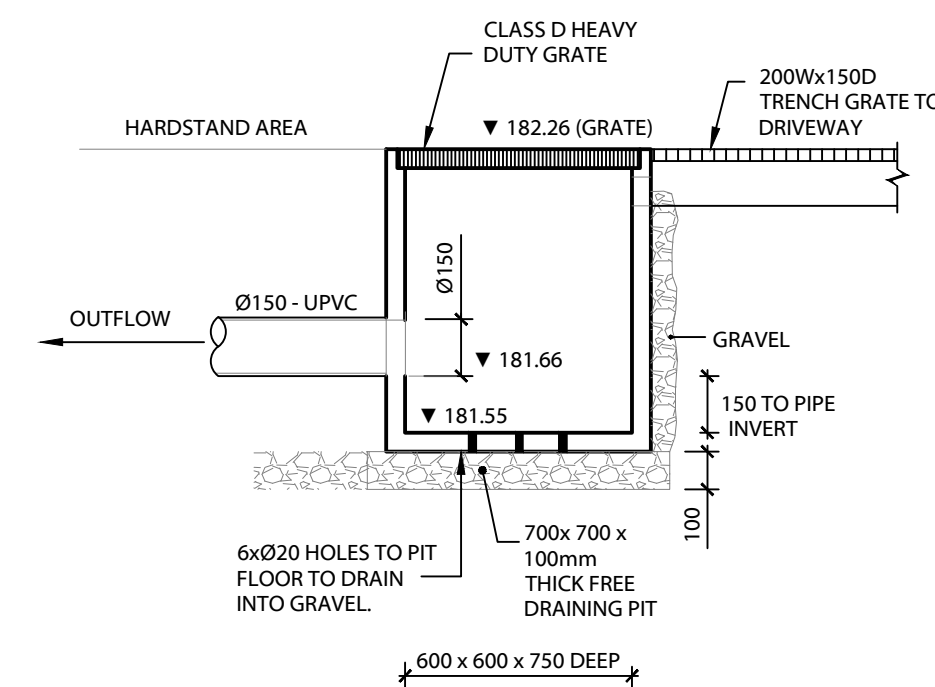
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PIPE PLAN AND LONGHSECTIONS



CIVIL DRAWING			
Designed	BH	Approved on behalf of RHM Consulting Engineers	05/08/20
Drawn	CH	Project Engineer/Director	Date
Datum	NIL	Drawing No:	Rev
Date	JULY 20	19-027-C13	C





## PIT 2 DETAIL

SCALE 1:20 (A1)

SCALE 1:10 (A1)

NOTE:

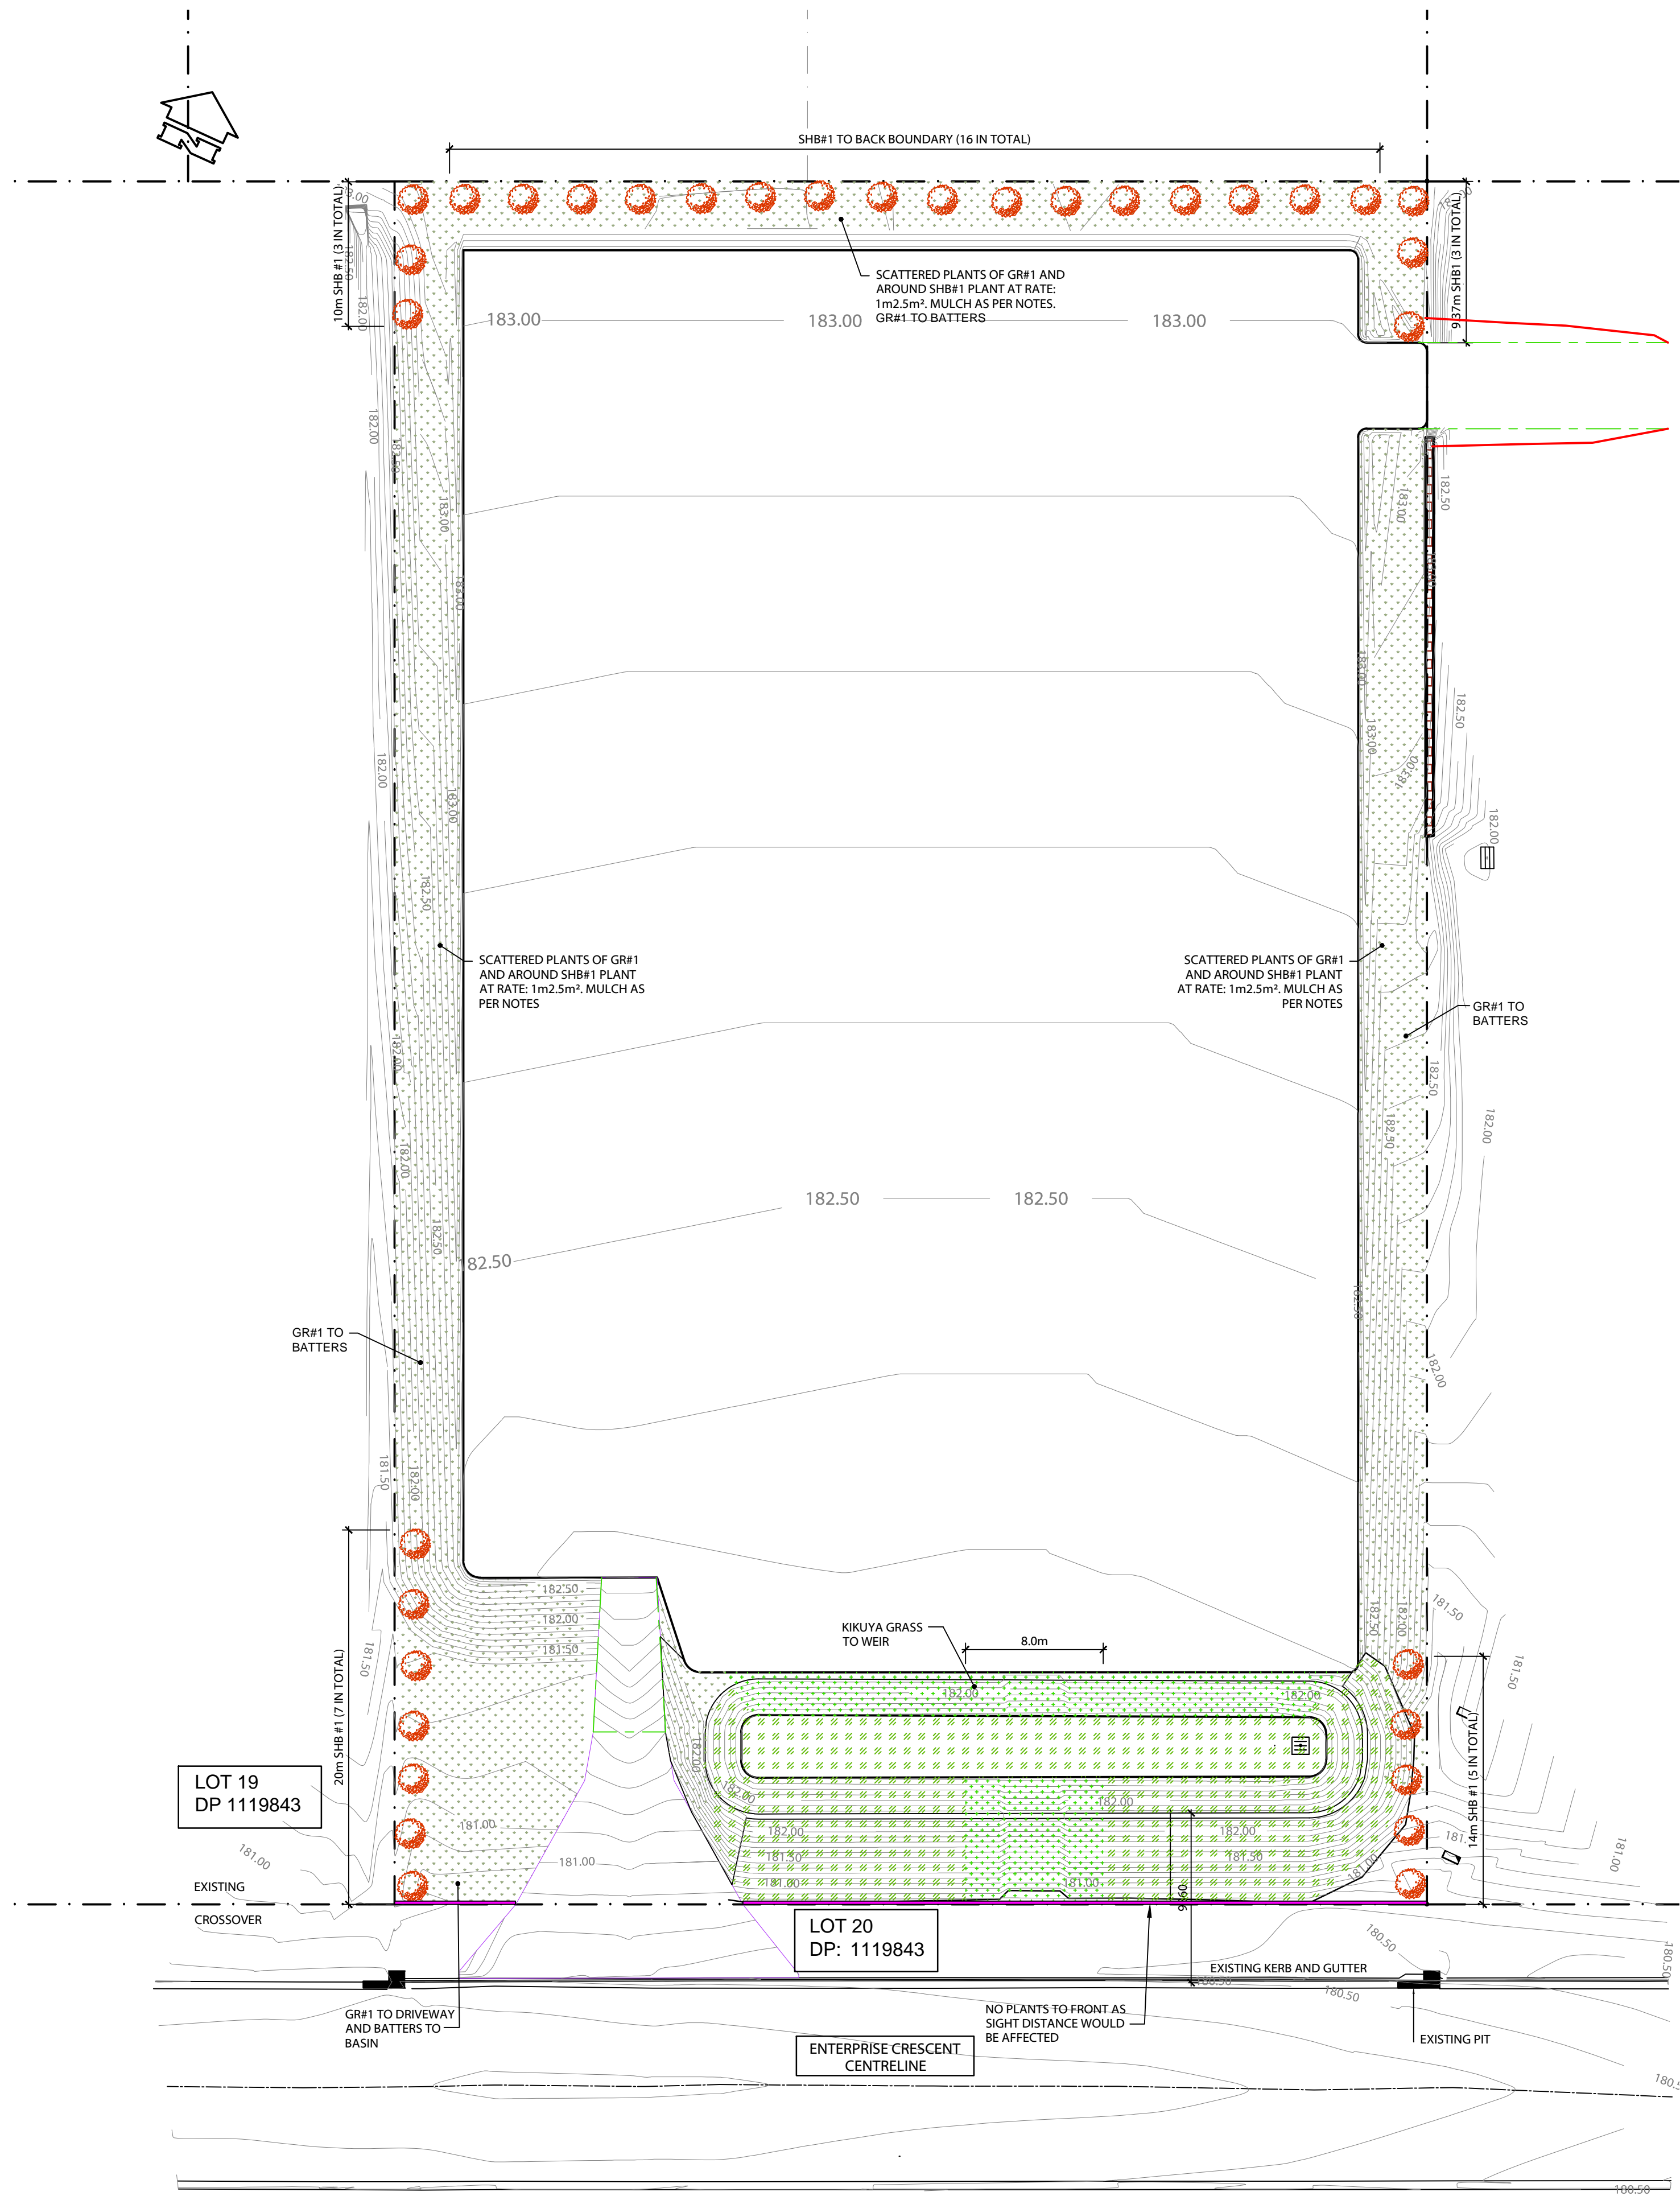
1. \*DIMENSIONS MAY CHANGE TO REFLECT COLLAR LAYOUT AS ANCHOR BLOCK SHOULD BE INSTALLED AROUND COLLAR FOR GREATER STRENGTH.
2. ANCHOR BLOCKS AT CH 8.0 AND CH 13.0



SCALE 1:10 (A1)

[illegible]





NOTES:

1. PRIOR TO PLANNING, THE LAYER TOPSOIL (SOIL FROM STOCKPILE) MUST BE WEEDED AND RAKED TO ENSURE MATERIAL IS NOT COMPACTED.
2. AT LEAST 75MM OF ORGANIC MULCH (E.G. PINE BARK) MUST BE LAID OVER THE EXPOSED TOP SOIL MATERIAL. THIS MULCH IS CRITICAL FOR WEED CONTROL.
3. MULCH AND TOPSOIL TO BE PRE-WATERED PRIOR TO PLANTING. MULCH SHOULD BE KEPT AWAY FROM THE BASE OF ALL PLANTS.
4. THE HOLES FOR THE PLANTS SHOULD BE OVER EXCAVATED TO TWICE THE DIAMETER OF THE POT AND AT LEAST 100MM SURPLUS IN DEPTH. THE ORGANIC FILL SHOULD BE FIRMLY PLACED THE PLANT. WATERING UPON COMPLETION SHOULD OCCUR.
5. PLANT ROOT BALL SHOULD BE WATERED PRIOR TO AND UPON COMPLETION OF PLANTING. ROOT BALL MAY NEED TO BE DISTRIBUTED. REFER TO PLANTING RECOMMENDATIONS AS SUPPLIED.
6. REGULARLY WATER (TWICE WEEKLY IN SPRING) SHOULD OCCUR TO ESTABLISH THE PLANTS. TYPICALLY IS SUGGESTED THAT AT LEAST 1 TO 2 LITRES OF WATER PER PLANT SHOULD BE APPLIED TO THE PLANTS IN THE FIRST 12 WEEKS OR UNTIL ESTABLISHMENT HAS OCCURRED. THIS MAY NEED TO INCREASE IF PLANTING OCCURS IN SUMMER.
7. WEEDING WITHIN FOUR (4) WEEK OF PLANTING IS SUGGESTED. ONGOING WEEDING THEREAFTER IS RECOMMENDED TO ENSURE WEED DENSITY DOES NOT EXCEED 10%.
8. SMALLER SHRUBS SHOULD BE STAKED.
9. PRUNING BI-ANNUAL MAY BE REQUIRED DEPENDING UPON PLANTING GROWTH.
10. DETAILS RELATING TO IMPORTED SOILS TO GARDENS AND TURF AREAS TO REFLECT RECOMMENDATIONS AS NOTED IN A54419.
11. FERTILISING ON ESTABLISHMENT AND DURING SPRING IS RECOMMENDED. RATES OF APPLICATION TO MANUFACTURES DETAILS.
12. PLANT SURVIVAL RATE SHOULD EXCEED 80%. IF THE SURVIVAL RATE IS LESS THAN THIS, ADDITIONAL PLANTING AT THE APPROPRIATE SEASON WILL BE REQUIRED.

LEGEND:

- DENOTES KIKUYA GRASS TO WEIR
- DENOTES SHB#1 SCREENING SHRUBS CALLISTEMON VIMINALIS "SLIM" BOTTLE BRUSH. PLACES 1.5m INSIDE BOUNDARY FENCE SPACED AT 3m CENTERS
- DENOTES GR#1 EREMOPHILA GLABRA "KALBARRI CARPET" TO BE PLANTED TO ALL BATTERS AS SHOWN SUGGESTED PLANTING RATE TO BE 1 PLANT PER 2.5m<sup>2</sup> MULCH AS NOTED IN NOTE #2
- DENOTES NATIVE GRASSES TO BASIN BATTER AND FLOOR AS SHOWN
- DENOTES 100mm HIGH H4 PINE KICKER BOARD FIXED TO FENCE TO RESTRAIN MULCH



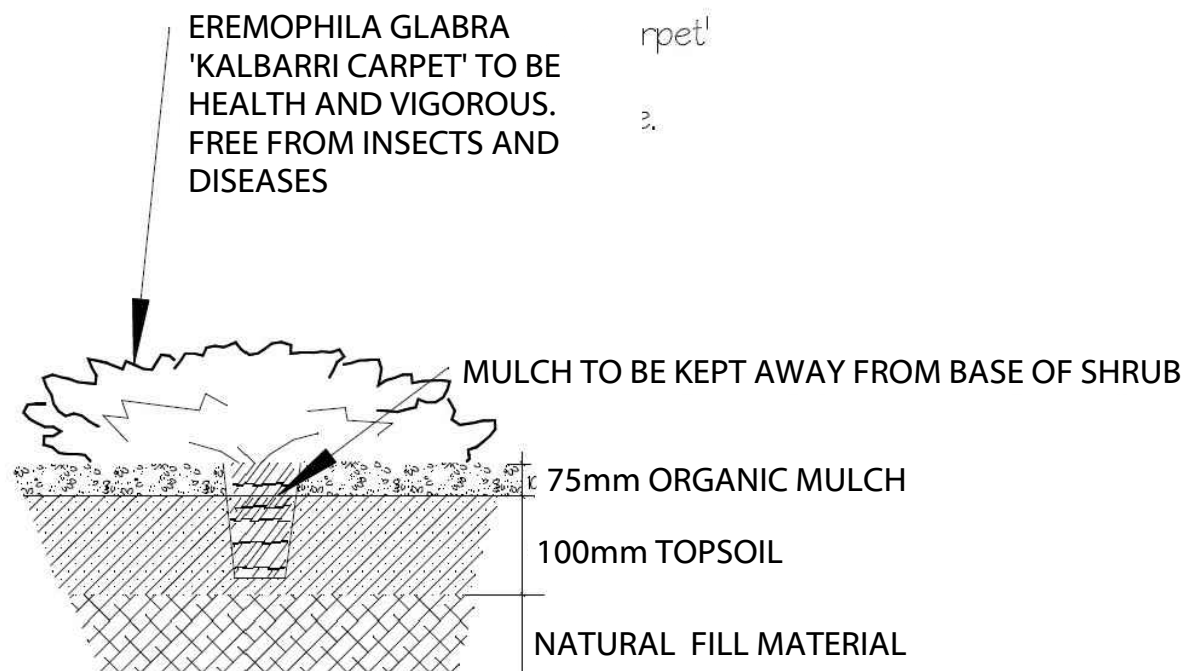
CALLISTEMON VIMINALIS "SLIM"



KIKUYA GRASS

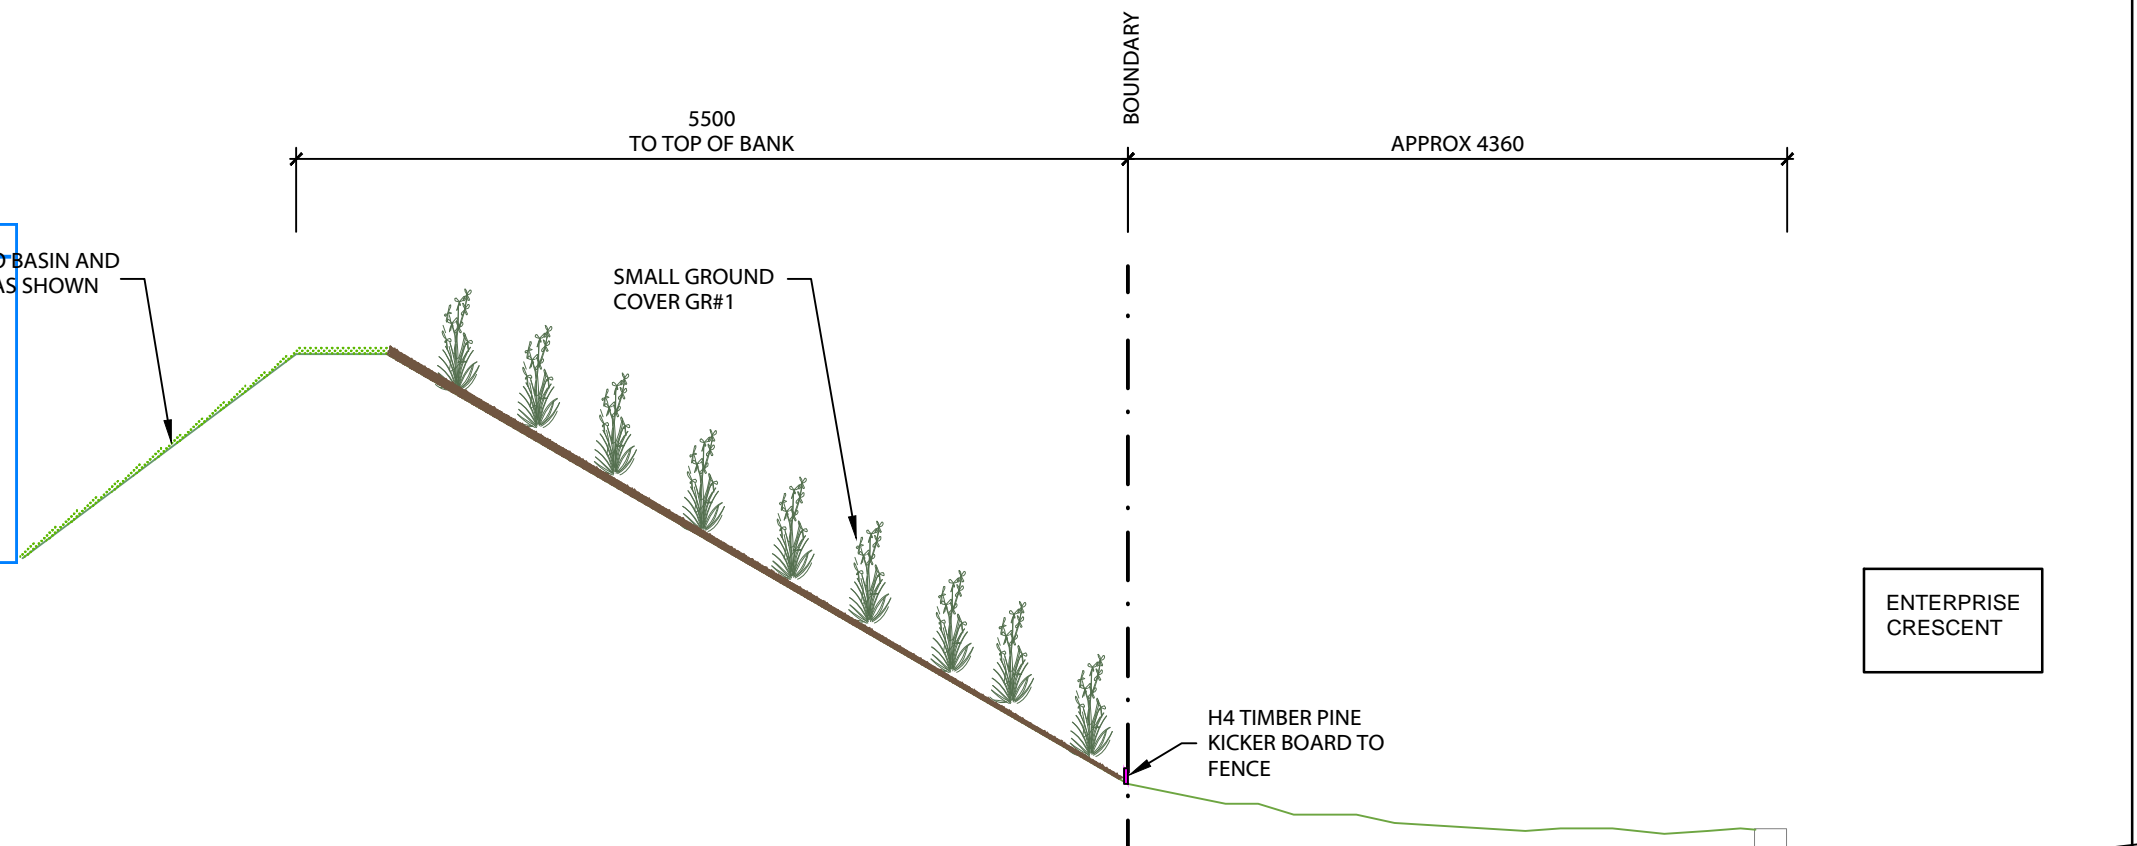


EREMOPHILA GLABRA "KALBARRI CARPET"



PLANT DETAIL

MUSWELLBROOK SHIRE COUNCIL  
DEVELOPMENT CONSENT  
This document forms part of  
Council's Notice of Determination  
DA 2020-22  
Approval Date: 22-Sep-20  
Delegated Officer: ALISA EVANS



BANK LANDSCAPE DETAIL

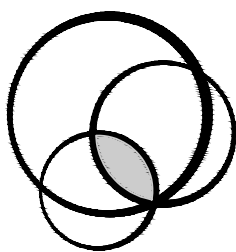
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REV	DESCRIPTION	DATE	BY	REV	DESCRIPTION	DATE	BY
B	ISSUED FOR APPROVAL	05/08/20	CH				
A	GENERAL AMENDMENTS	16/06/20	CH				

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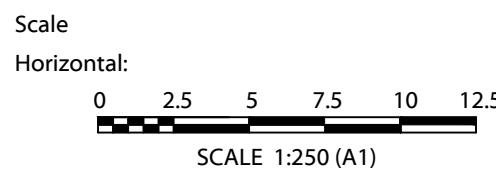
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LANDSCAPE PLAN



CIVIL DRAWING			
Designed	BH	Approved on behalf of RHM Consulting Engineers	05/08/20
Drawn	CH	Project Engineer/Director	Date
Datum	NIL	Drawing No:	Rev
Date	JULY 20	19-027-C15	B