


Site Location

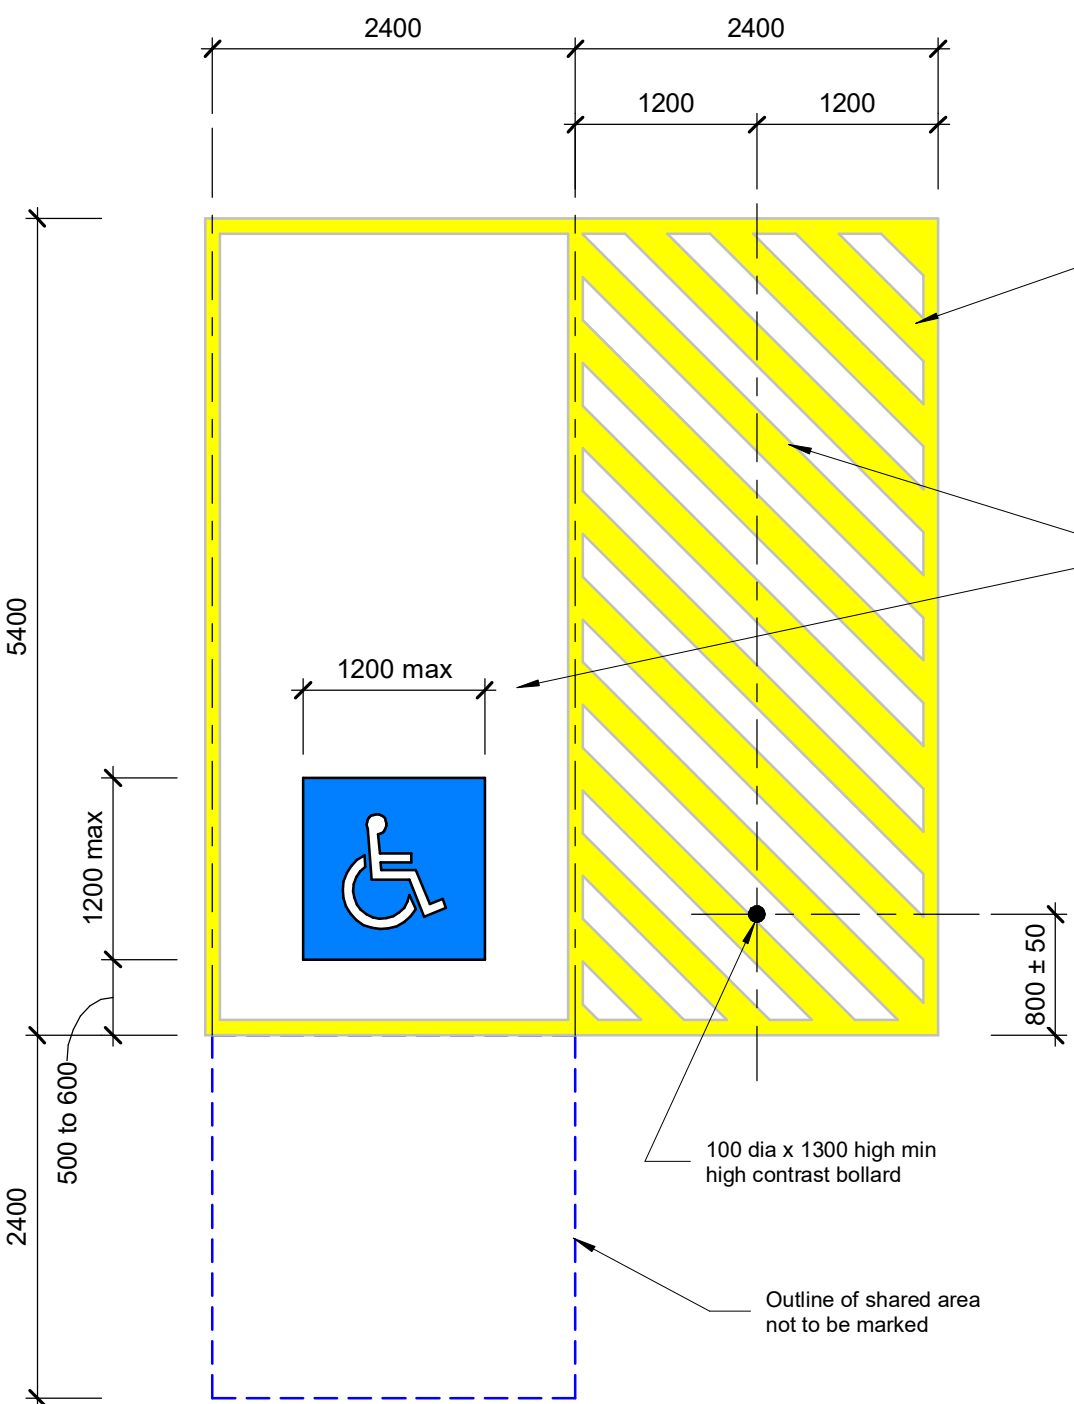

Accessible Carpark Detail

1 : 50

80 to 100mm unbroken lines on all sides with diagonal stripes 150 to 200mm wide with spaces 200 to 300mm between stripes. The stripes to be at an angle of 45 ± 10 degrees to the side of the space.

Accessible car park including bollard & shared area's (marked & unmarked) to be in accordance with AS 2890.6:2009. Pavement slope to be 1:40 max in any direction (1:33 if surface is bituminous seal) in accordance with AS 2890.6 part 2.3. Parking & unloading area surface to be a hard plane slip resistant surface in accordance with AS 2890.6 part 2.3.

Accessible Carpark Notes:

Each dedicated space shall be identified by means of a white symbol of access in accordance with AS1428.1 between 800 to 1000mm high placed on a blue rectangle with no side more than 1200mm, placed as a pavement marking in the centre of the space between 500 & 600mm from it's entry point.

Dedicated parking spaces shall be outlines with unbroken lines 80 to 100mm wide on all sides excepting any side delineated by a kerb, barrier or wall.

No shared markings are to be placed in trafficked areas.


Pavement markings shall be yellow & shall have a slip resistant surface. Raised pavement markers shall not be used for space delineation.

Signposts in public car parks bearing the user limitation "Access Symbol ONLY" should be used if it is necessary to formally reserve spaces for their intended use. Additional words such as "PERMIT MUST BE DISPLAYED" may be added to the signs.

BCA Classification	
Existing Building	Class 5
Existing Dwelling	Class 1a
Proposed Consult Rooms	Class 5

Carpark Table

Dimensions of parking spaces	
Userclass	= 3 (AS 2890.1 Table 1.1)
Length	= 5400 min
Width	= 2600 min (AS 2890.1 Figure 2.2).
Aisle Width	= 5800 min

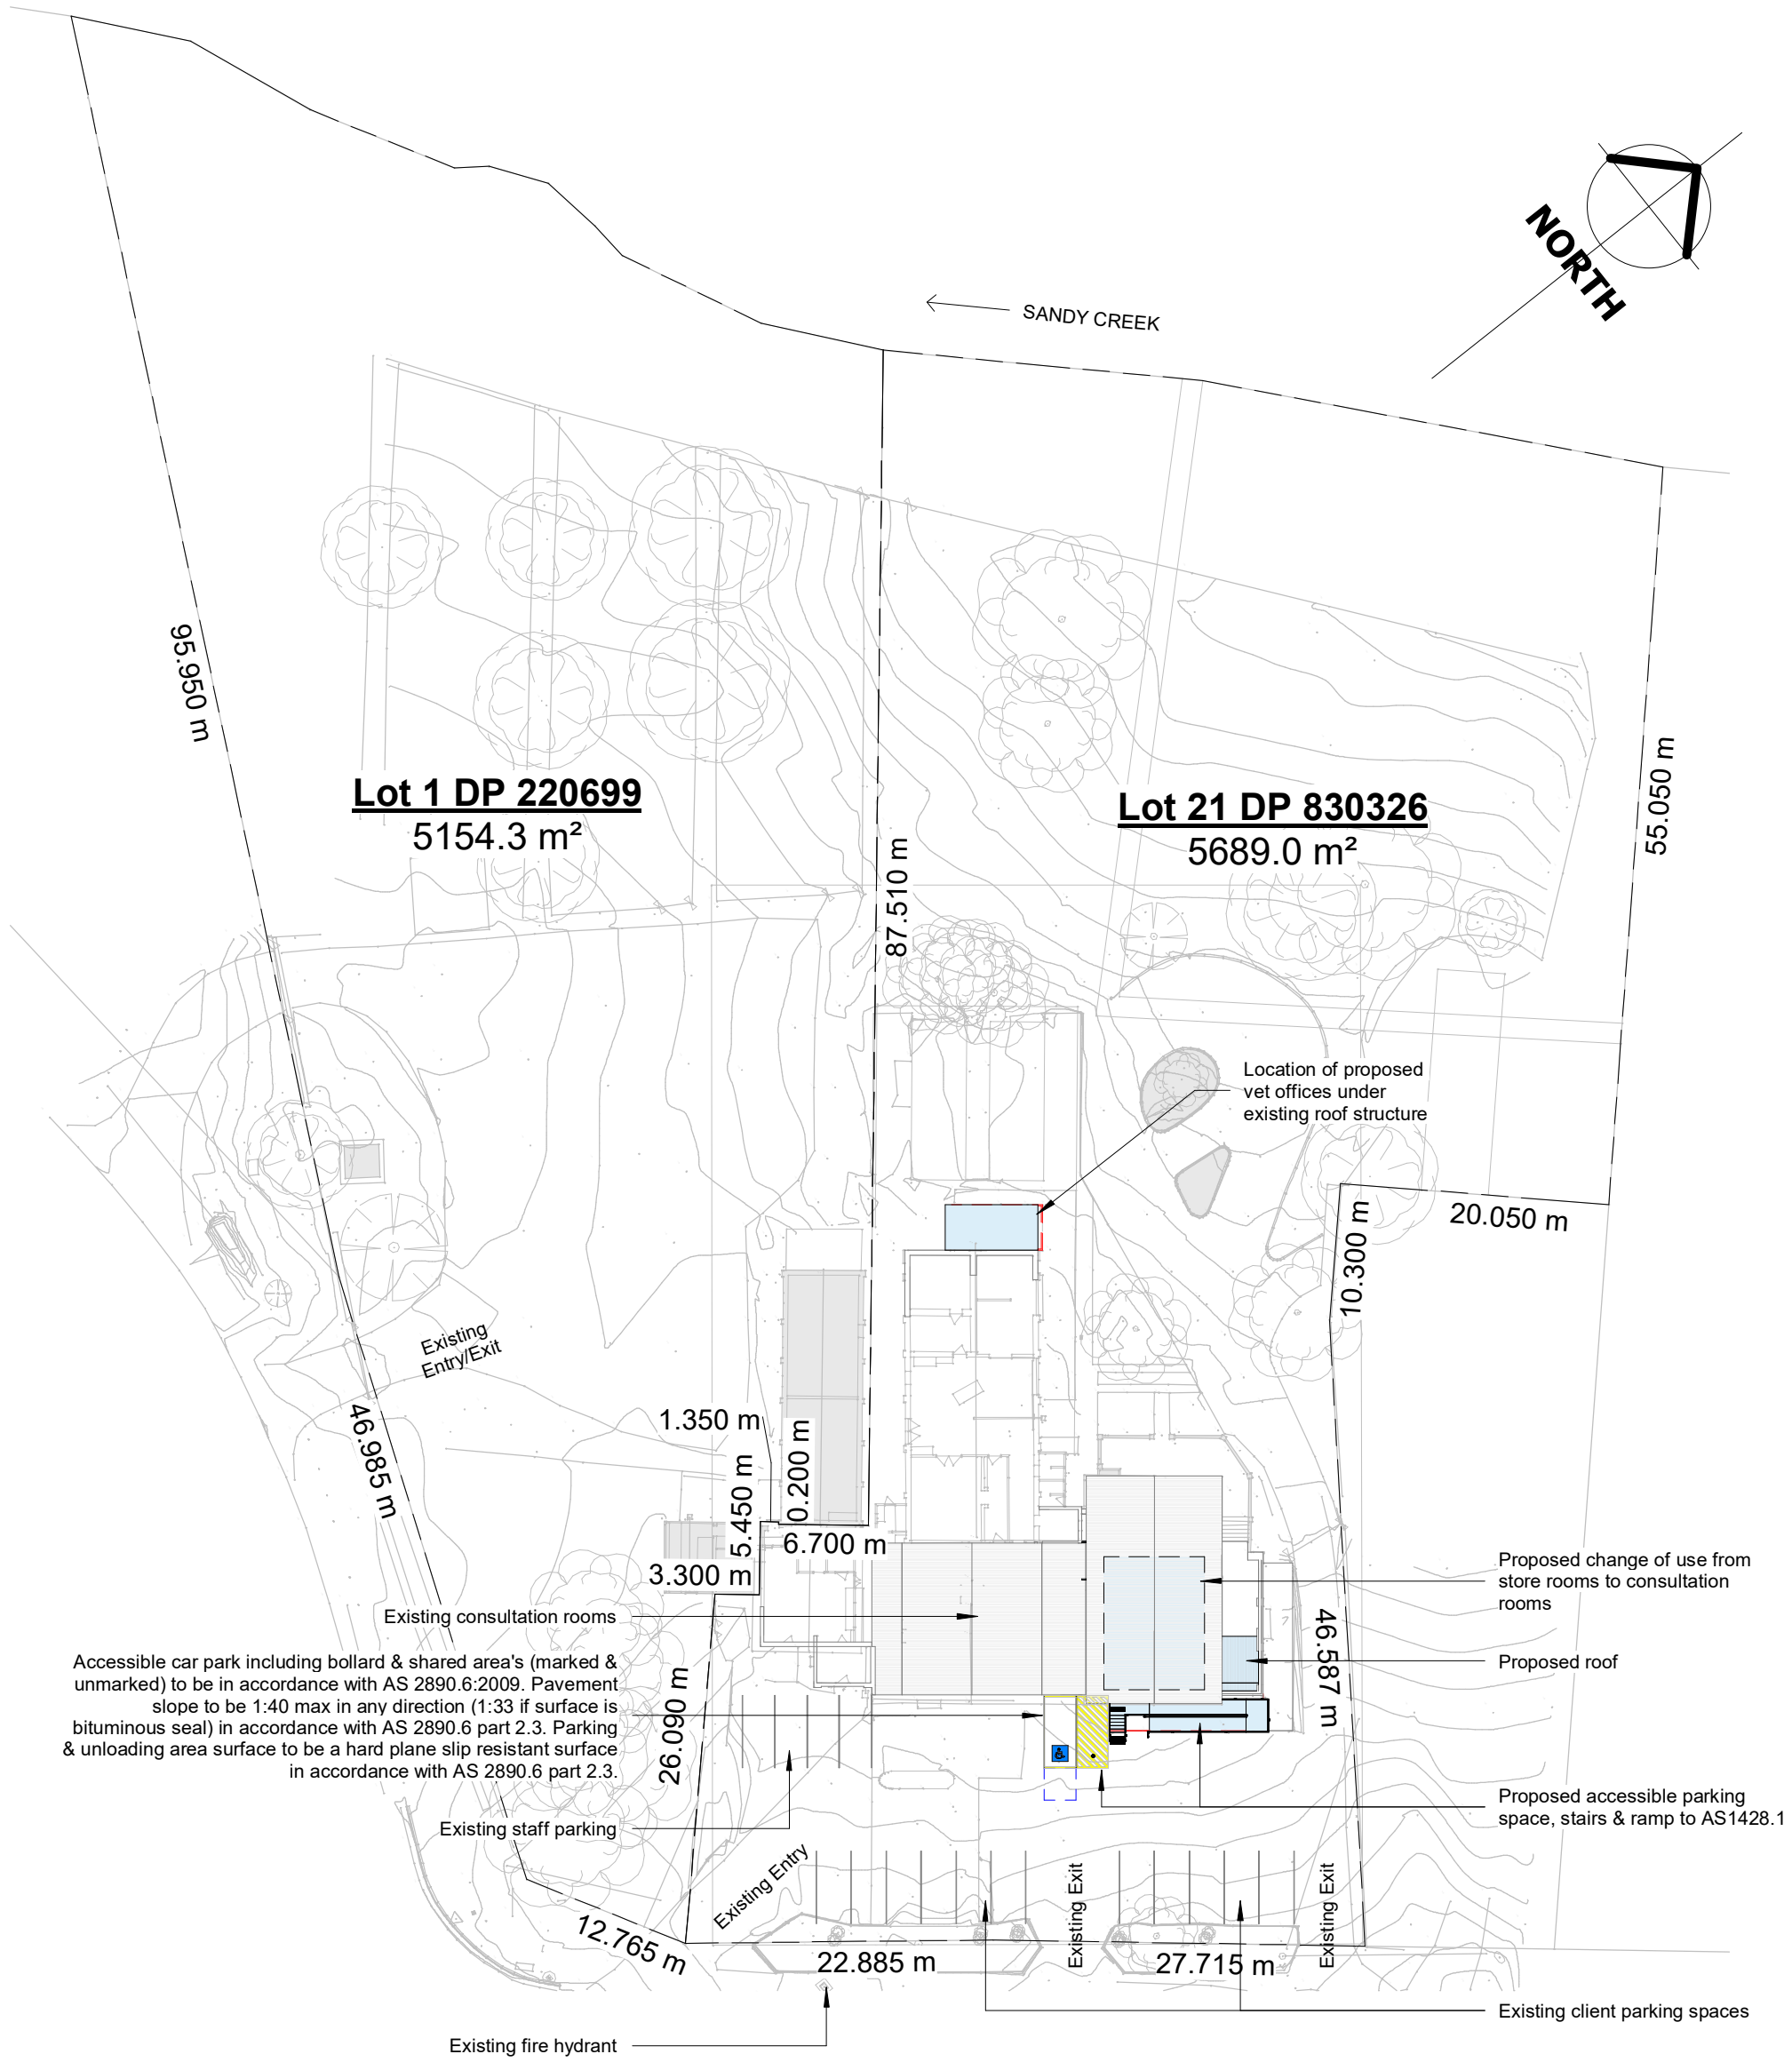

Site Plan

1 : 500

GENERAL NOTES:

CLASS 5 (Single Storey) - Type C Construction

RC slab to be in accordance with Engineers details.
All structural details to be designed & provided by an Engineer.
Written dimensions will take precedence over scale.
Floor finishes to comply with AS 1428.1 Part 7.
Provide external security lights to all exit doors.

All work & materials is to comply with section B of the BCA.

90mm stud walls with plasterboard wall sheeting or the like to selected internal walls.
Finish to remaining walls to be arranged with owners.
All floor & wall linings to comply with specification C1.8 of BCA.
All building work to comply with applicable parts of clause C.10 & Specification C1.10 of the BCA.
All glazing to be supplied and installed in accordance with AS2047 and AS1288.

All paths of travel to comply with part D1.6 of the BCA.
Installation of services or equipment in exits & paths of travel shall comply with Part D2.7 of the BCA.
Where stairs and/or ramps are required, they are to be built in accordance with BCA part D2.13 & table D2.14. All stairs to have slip resistant finish or nosing strip in accordance with table below.

Application	Surface Condition	
	Dry	Wet
Dry Ramp steeper than 1:14	P4 or R11	P5 or R12
Ramp steeper than 1:20 but not steeper than 1:14	P3 or R10	P4 or R11
road or landing surface	P3 or R10	P4 or R11
Nosing or landing edge strip	P3	P4

Thresholds to comply with BCA part D2.15 & As 1428.1
Barriers to prevent falls to comply with BCA part D2.16
Doors opening to required exits must open in an outward direction in accordance with BCA part D2.20.
Door hardware to be supplied and installed in accordance with D2.21 of the BCA
Door signage to comply with BCA part D2.23.
Disabled access to comply with BCA part D3 and AS1428.1
Install compliant signage in accordance with Part D3.6 and Spec D3.6 of the BCA.

Fire blanket to be installed in Kitchen in accordance with E1.10 of the BCA.
Fire extinguishers to be installed in accordance with Part E1.6 and Table E1.6 of the BCA.
Fire extinguishers must be provided during construction in accordance with part E1.9 of the BCA.
Smoke hazard management system to comply with BCA part E2.
Emergency lighting & exit signs to be provided & operated in the event of a power failure & installed in accordance with BCA part E4 & current Australian standards.

All waterproofing to be carried out in accordance with part F1.7 of the BCA and AS 3740.
Building to be damp proofed in accordance with F1.9 of the BCA and high impact vapour barrier provided under slab as per F1.10.
All wet areas are to be graded and drained to a floor waste in accordance with F1.11 of the BCA.
All glazing to be supplied and installed in accordance with part F1.13 of the BCA & AS2047 & AS1288.
Ventilation of rooms to comply with Part F4.5 of the BCA.

Power load shall comply with Section J of the BCA.
All lighting to be installed in accordance with J6 of BCA.


AREAS:

No.	Description	Date
A	DA	02/12/22
2	Pre DA	11/10/22
1	Final review	14/09/22

Note: All levels, dimensions & materials must be verified between owners & builder before commencement of construction.

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PROJECT PROPOSED RENOVATIONS & ACCESSIBLE ENTRY TO PET MEDICAL			
AT 14 ABERDEEN ST, MUSWELLBROOK			
FOR PET MEDICAL			
SIZE A1	SCALE DATE DRAWN	As indicated 13/06/22 PDG	JOB No: 066-22 SHEET No: 1 REV: A

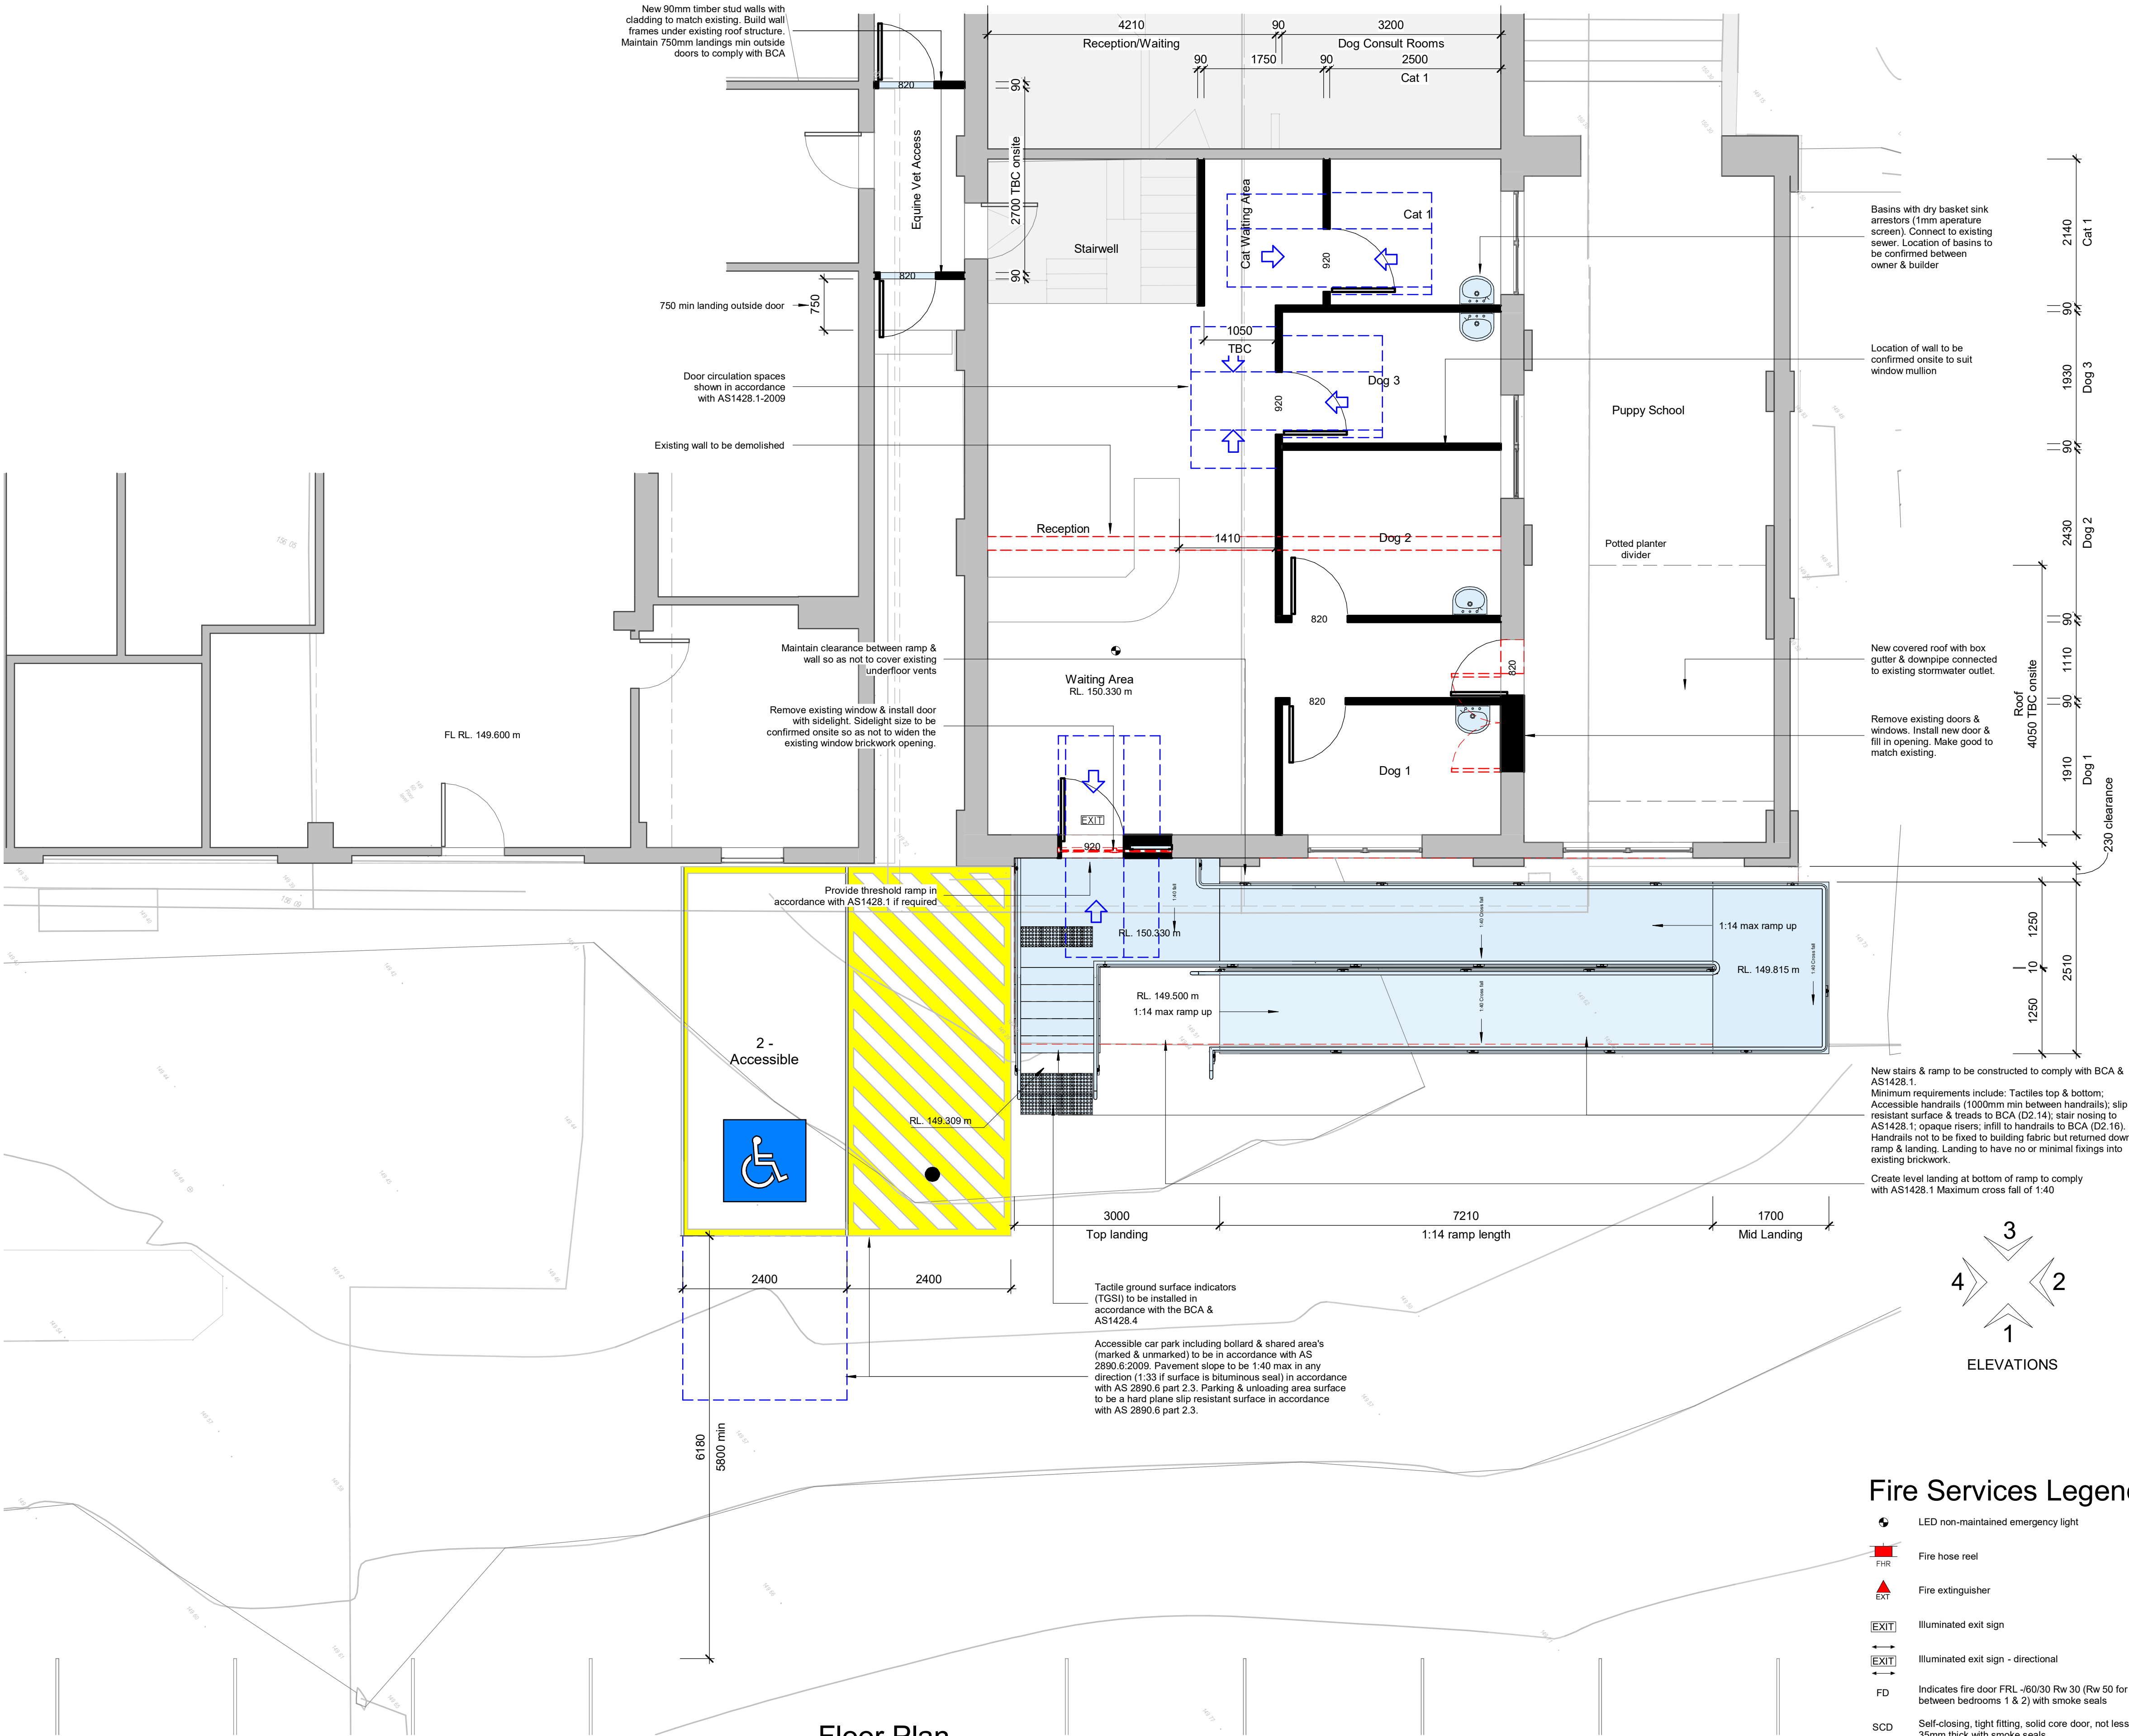

Floor Plan
1 : 50

Fire Services Legend

- LED non-maintained emergency light
- Fire hose reel
- Fire extinguisher
- Illuminated exit sign
- Illuminated exit sign - directional
- FD Indicates fire door FRL -60/30 Rw 30 (Rw 50 for door between bedrooms 1 & 2) with smoke seals
- SCD Self-closing, tight fitting, solid core door, not less than 35mm thick with smoke seals
- FWFD Indicates fire door FRL -90/30 fire doors with smoke seals that are self closing or automatic closing
- FWW Indicates glazed assembly with FRL of -90/90.
- MSBFD Indicates a self-closing fire door having an FRL of not less than -120/30.

GENERAL NOTES:

CLASS 5 (Single Storey) - Type C Construction

RC slab to be in accordance with Engineers details.
All structural details to be designed & provided by an Engineer.
Written dimensions will take precedence over scale.
Floor finishes to comply with AS 1428.1 Part 7.
Provide external security lights to all exit doors.

All work & materials is to comply with section B of the BCA.

90mm stud walls with plasterboard wall sheeting or the like to selected internal walls.
Finish to remaining walls to be arranged with owners.
All floor & wall linings to comply with specification C1.8 of BCA.
All building work to comply with applicable parts of clause C.10 & Specification C1.10 of the BCA.
All glazing to be supplied and installed in accordance with AS2047 and AS1288.

All paths of travel to comply with part D1.6 of the BCA.
Installation of services or equipment in exits & paths of travel shall comply with Part D2.7 of the BCA.
Where stairs and/or ramps are required, they are to be built in accordance with BCA part D2.13 & table D2.14. All stairs to have slip resistant finish or nosing strip in accordance with table below.

Application	Surface Condition	
	Dry	Wet
Dry Ramp steeper than 1:14	P4 or R11	P5 or R12
Ramp steeper than 1:20 but not steeper than 1:14	P3 or R10	P4 or R11
Tread or landing surface	P3 or R10	P4 or R11
Nosing or landing edge strip	P3	P4

Thresholds to comply with BCA part D2.15 & As 1428.1
Barriers to prevent falls to comply with BCA part D2.16
Doors opening to required exits must open in an outward direction in accordance with BCA part D2.20.
Door hardware to be supplied and installed in accordance with D2.21 of the BCA
Door signage to comply with BCA part D2.23.
Disabled access to comply with BCA part D3 and AS1428.1
Install compliant signage in accordance with Part D3.6 and Spec D3.6 of the BCA.

Fire blanket to be installed in Kitchen in accordance with E1.10 of the BCA.
Fire extinguishers to be installed in accordance with Part E1.6 and Table E1.6 of the BCA.
Fire extinguishers must be provided during construction in accordance with part E1.9 of the BCA.
Smoke hazard management system to comply with BCA part E2.
Emergency lighting & exit signs to be provided & operated in the event of a power failure & installed in accordance with BCA part E4 & current Australian standards.

All waterproofing to be carried out in accordance with part F1.7 of the BCA and AS 3740.
Building to be damp proofed in accordance with F1.9 of the BCA and high impact vapour barrier provided under slab as per F1.10.
All wet areas are to be graded and drained to a floor waste in accordance with F1.11 of the BCA.
All glazing to be supplied and installed in accordance with Part F1.13 of the BCA & AS2047 & AS1288.
Ventilation of rooms to comply with Part F4.5 of the BCA.

Power load shall comply with Section J of the BCA.
All lighting to be installed in accordance with J6 of BCA.

- Proposed
- Existing
- Demolished

AREAS:


No.	Description	Date
A	DA	02/12/22
4	Pre DA	11/10/22
3	Final review	14/09/22
2	For review	23/08/22
1	For review	20/06/22

Note: All levels, dimensions & materials must be verified between owners & builder before commencement of construction.


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PROJECT PROPOSED RENOVATIONS & ACCESSIBLE ENTRY TO PET MEDICAL				
AT 14 ABERDEEN ST, MUSWELLBROOK				
FOR PET MEDICAL				
SIZE	SCALE	As indicated	JOB No:	066-22
A1	DATE	13/06/22	SHEET No:	2
	DRAWN	PDG		A




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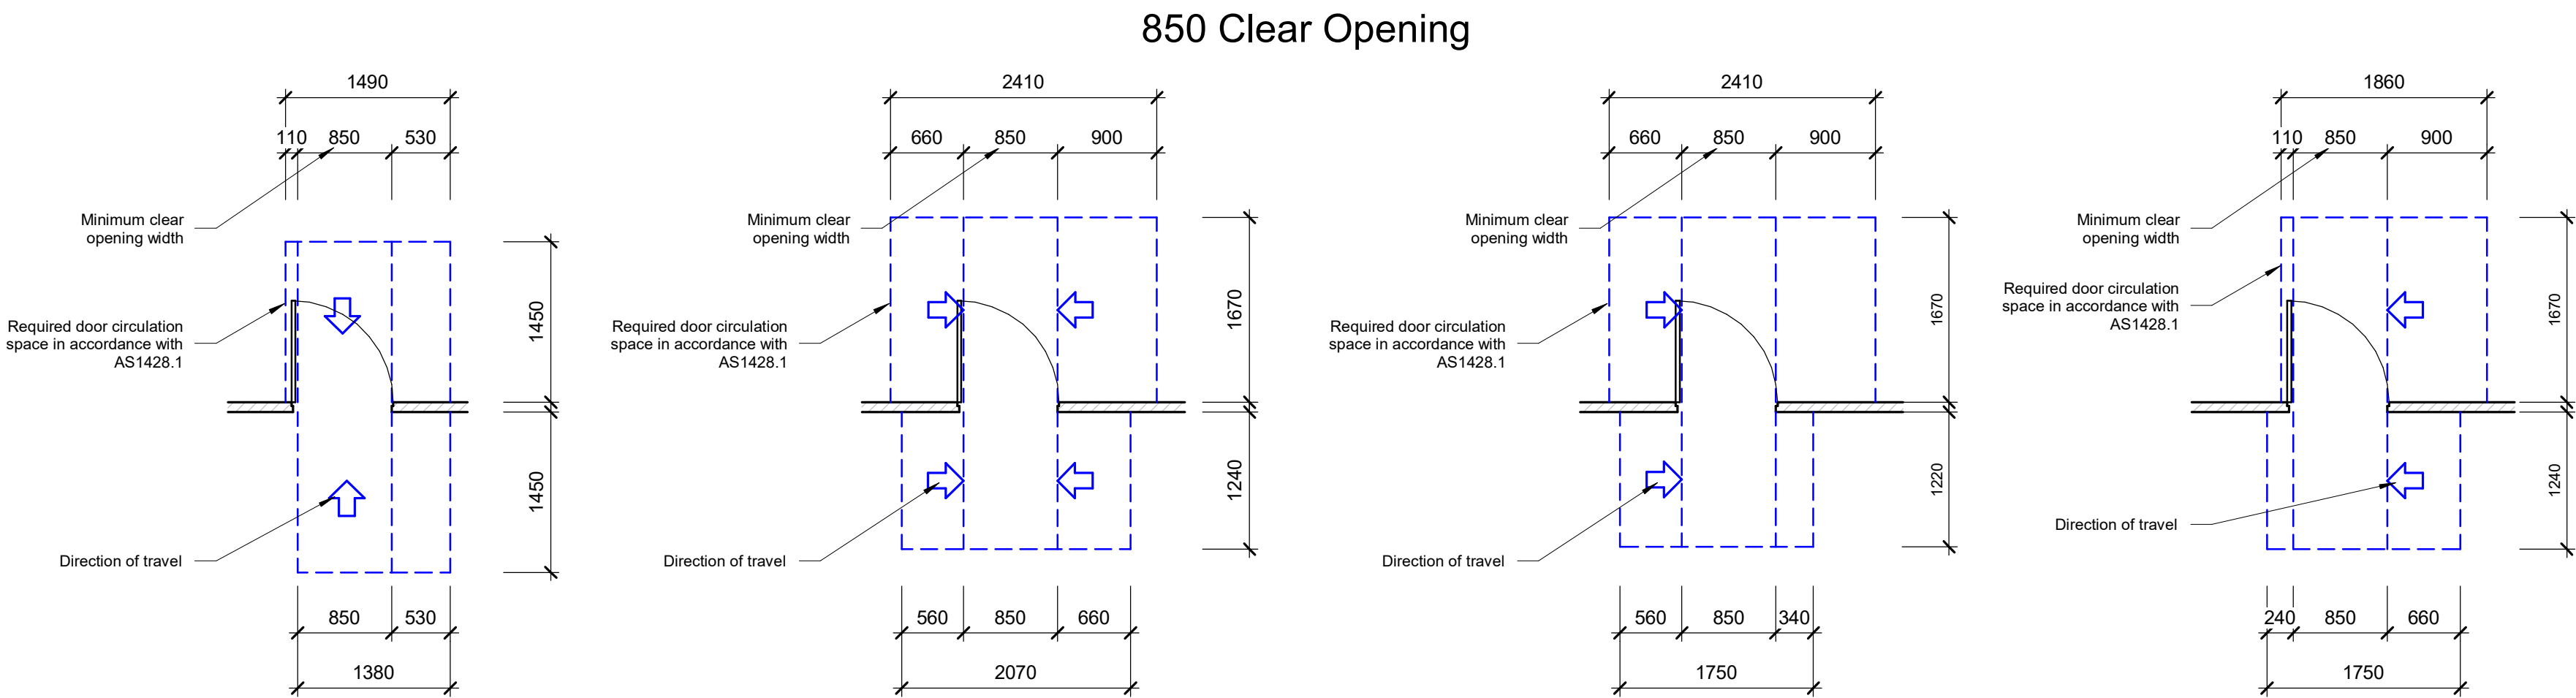
Elevation 2
1 : 50

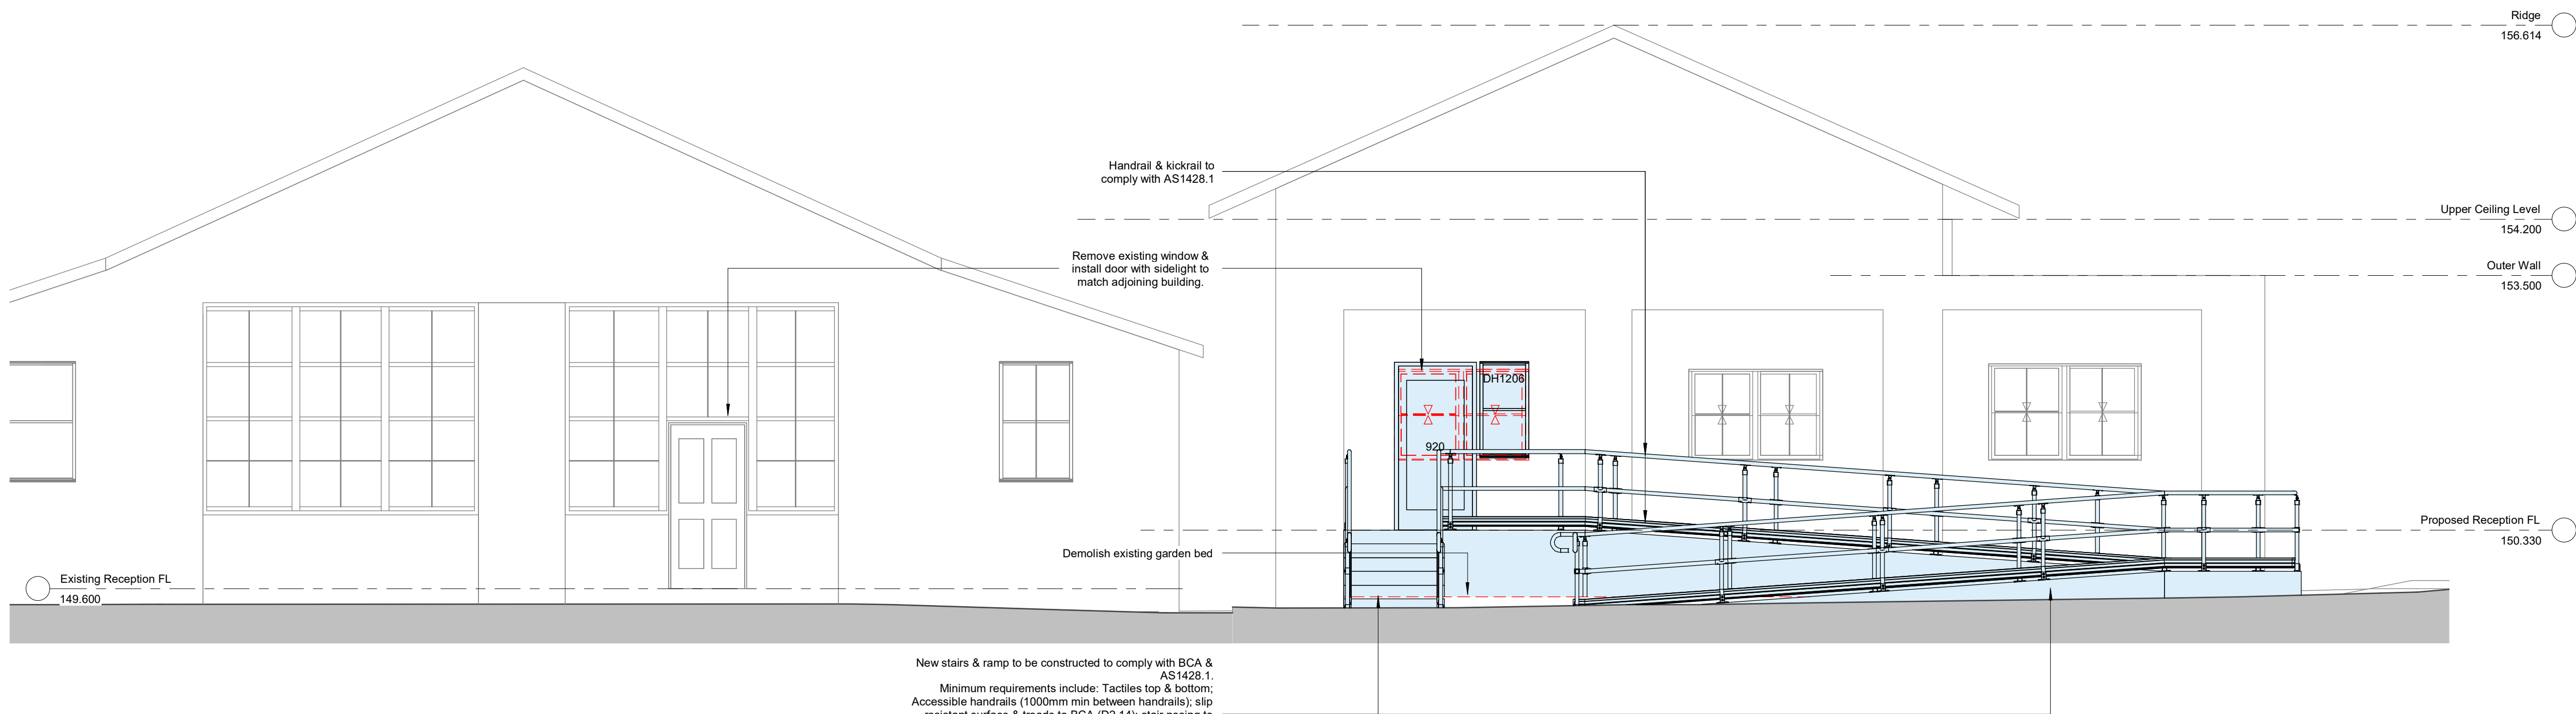

Existing Door & Window

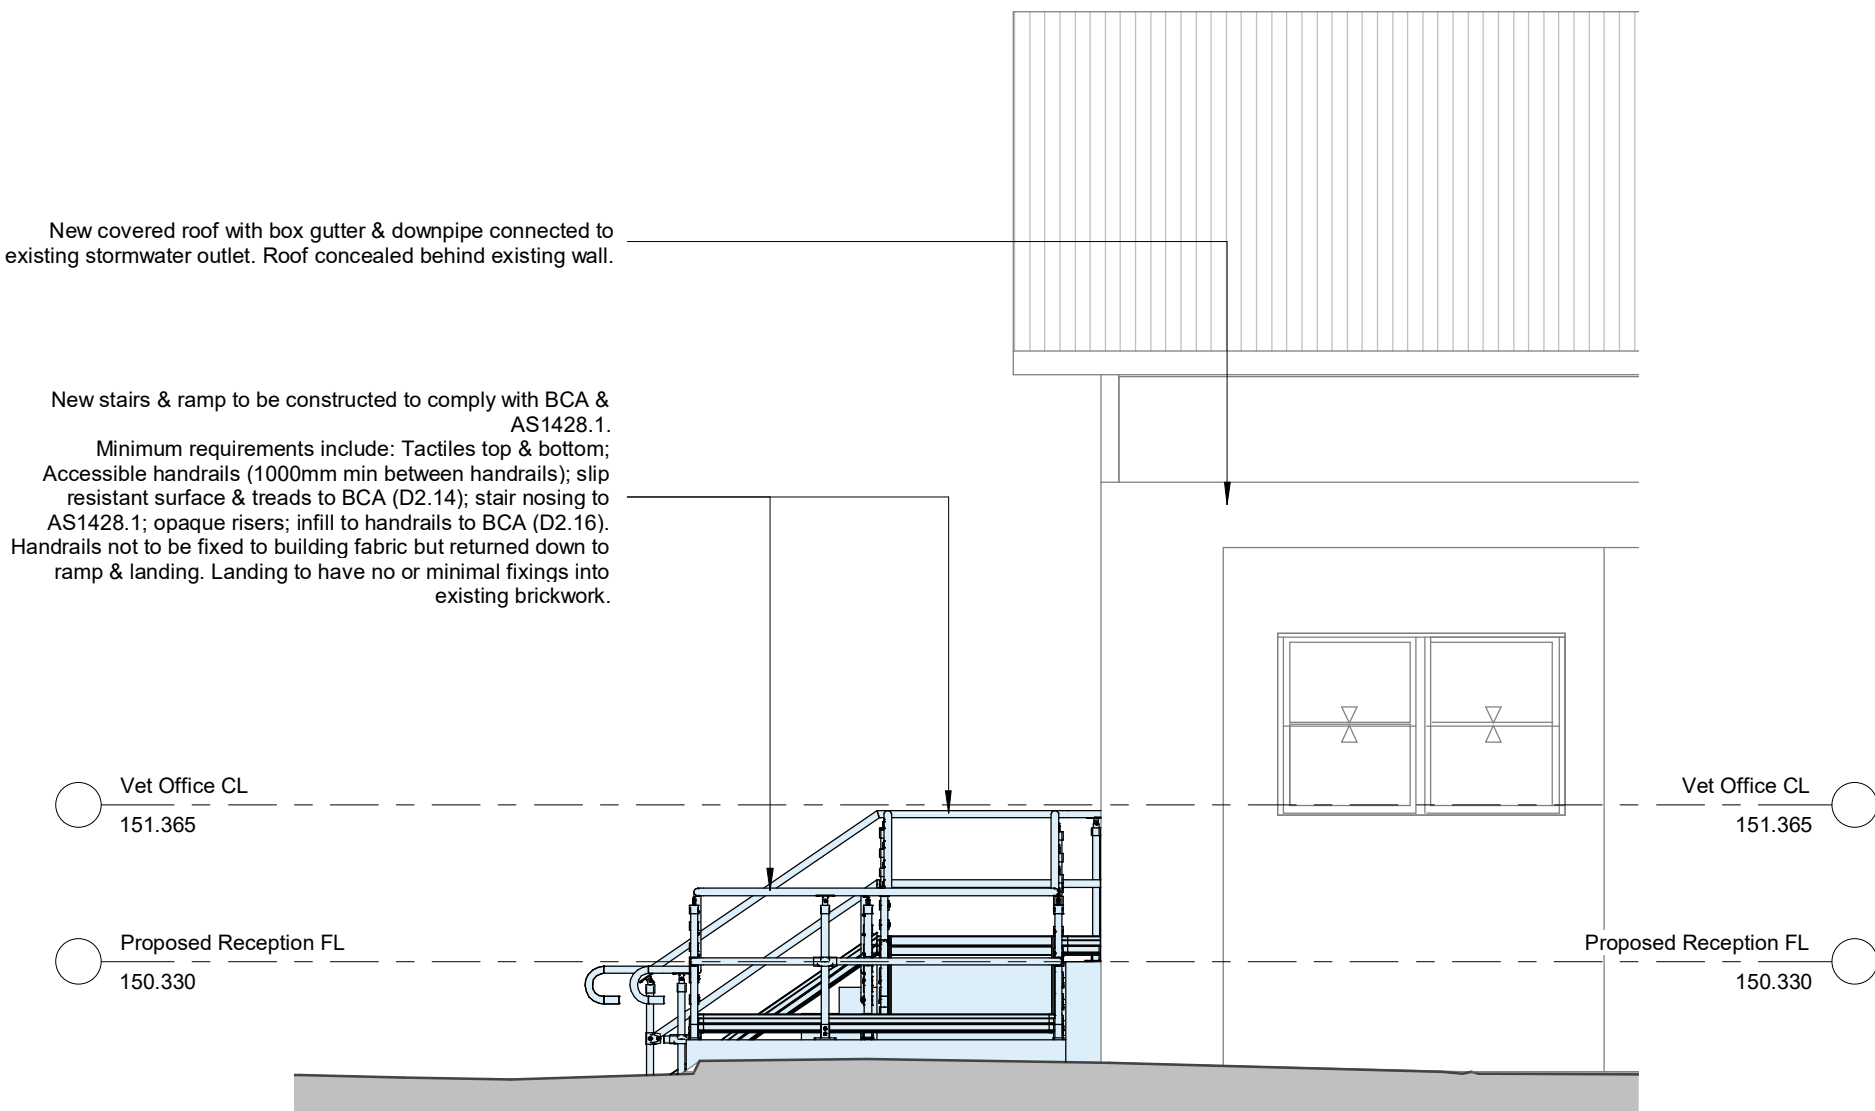

Elevation 4
1 : 50

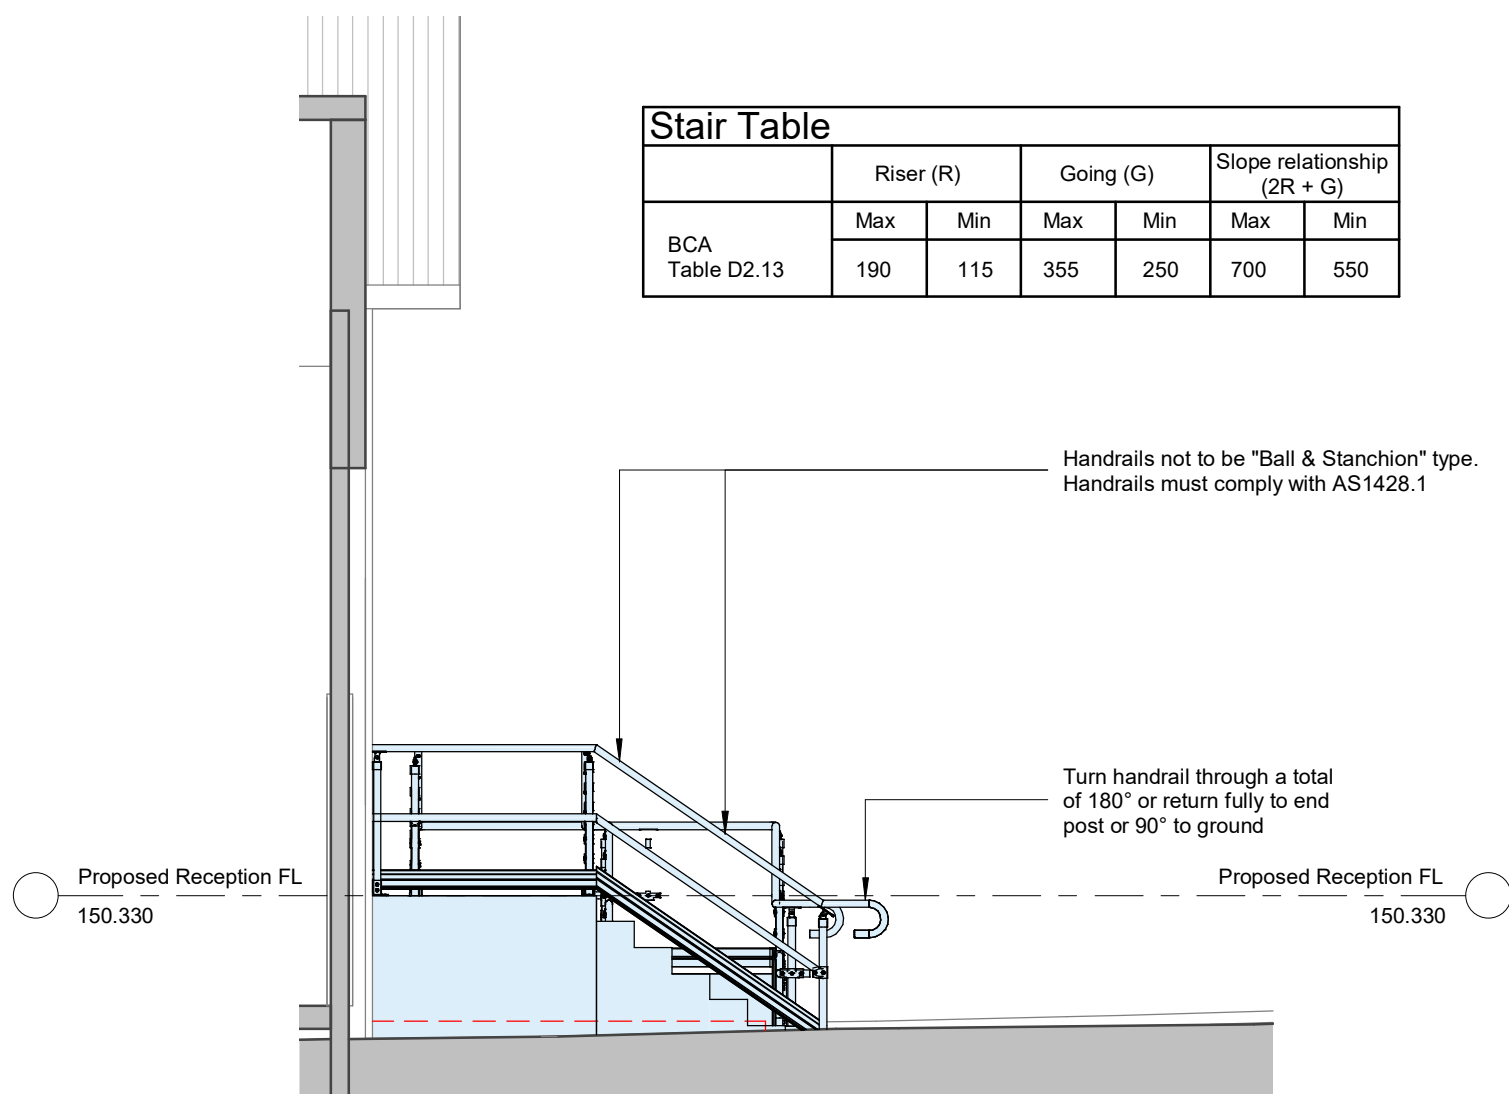

The dimensions shall also apply in mirror image configurations. Dimensions shown are for a clear opening width of 850mm. Other clear opening widths require different circulation spaces. Refer to AS1428.1 for details & dimensions.

Door Circulation Spaces
1 : 50

Circulation Spaces at Doorways

Circulation spaces shall be provided at every doorway, gate, or similar entry way on a continuous accessible path of travel in accordance with AS1428.1-2021 part 10.3.

Circulation spaces at doorways shall have a gradient and crossfall not steeper than 1 in 40.

Doorway circulation spaces shall be used in combination to allow access through doorways in both directions.

The dimensions shall also apply in mirror image configurations. Dimensions shown are for a clear opening width of 850mm. Larger clear opening widths require different circulation spaces. Refer to AS1428.1 part 10 for details & dimensions.

GENERAL NOTES:

CLASS 5 (Single Storey) - Type C Construction

RC slab to be in accordance with Engineers details.
All structural details to be designed & provided by an Engineer.
Written dimensions will take precedence over scale.
Floor finishes to comply with AS 1428.1 Part 7.
Provide external security lights to all exit doors.

All work & materials is to comply with section B of the BCA.

90mm stud walls with plasterboard wall sheeting or the like to selected internal walls.

Finish to remaining walls to be arranged with owners.

All floor & wall linings to comply with specification C1.8 of BCA.

All building work to comply with applicable parts of clause C.10 & Specification C1.10 of the BCA.

All glazing to be supplied and installed in accordance with AS2047 and AS1288.

All paths of travel to comply with part D1.6 of the BCA.

Installation of services or equipment in exits & paths of travel shall comply with Part D2.7 of the BCA.

Where stairs and/or ramps are required, they are to be built in accordance with BCA part D2.13 & table D2.14. All stairs to have slip resistant finish or nosing strip in accordance with table below.

Application	Surface Condition	
	Dry	Wet
Dry Ramp steeper than 1:14	P4 or R11	P3 or R12
Ramp steeper than 1:20 but not steeper than 1:14	P3 or R10	P4 or R11
Read or landing surface	P3 or R10	P4 or R11
Nosing or landing edge strip	P3	P4

Thresholds to comply with BCA part D2.15 & As 1428.1

Barriers to prevent falls to comply with BCA part D2.16

Doors opening to required exits must open in an outward direction in accordance with BCA part D2.20.

Door hardware to be supplied and installed in accordance with D2.21 of the BCA

Door signage to comply with BCA part D2.23

Disabled access to comply with BCA part D3 and AS1428.1

Install compliant signage in accordance with Part D3.6 and Spec D3.6 of the BCA.

Fire blanket to be installed in Kitchen in accordance with E1.10 of the BCA.

Fire extinguishers to be installed in accordance with Part E1.6 and Table E1.6 of the BCA.

Fire extinguishers must be provided during construction in accordance with part E1.9 of the BCA.

Smoke hazard management system to comply with BCA part E2.

Emergency lighting & exit signs to be provided & operated in the event of a power failure & installed in accordance with BCA part E4 & current Australian standards.

All waterproofing to be carried out in accordance with part F1.7 of the BCA and AS 3740.

Building to be damp proofed in accordance with F1.9 of the BCA and high impact vapour barrier provided under slab as per F1.10.

All wet areas are to be graded and drained to a floor waste in accordance with F1.11 of the BCA.

All glazing to be supplied and installed in accordance with part F1.13 of the BCA & AS2047 & AS1288.

Ventilation of rooms to comply with Part F4.5 of the BCA.

Power load shall comply with Section J of the BCA.

All lighting to be installed in accordance with J6 of BCA.

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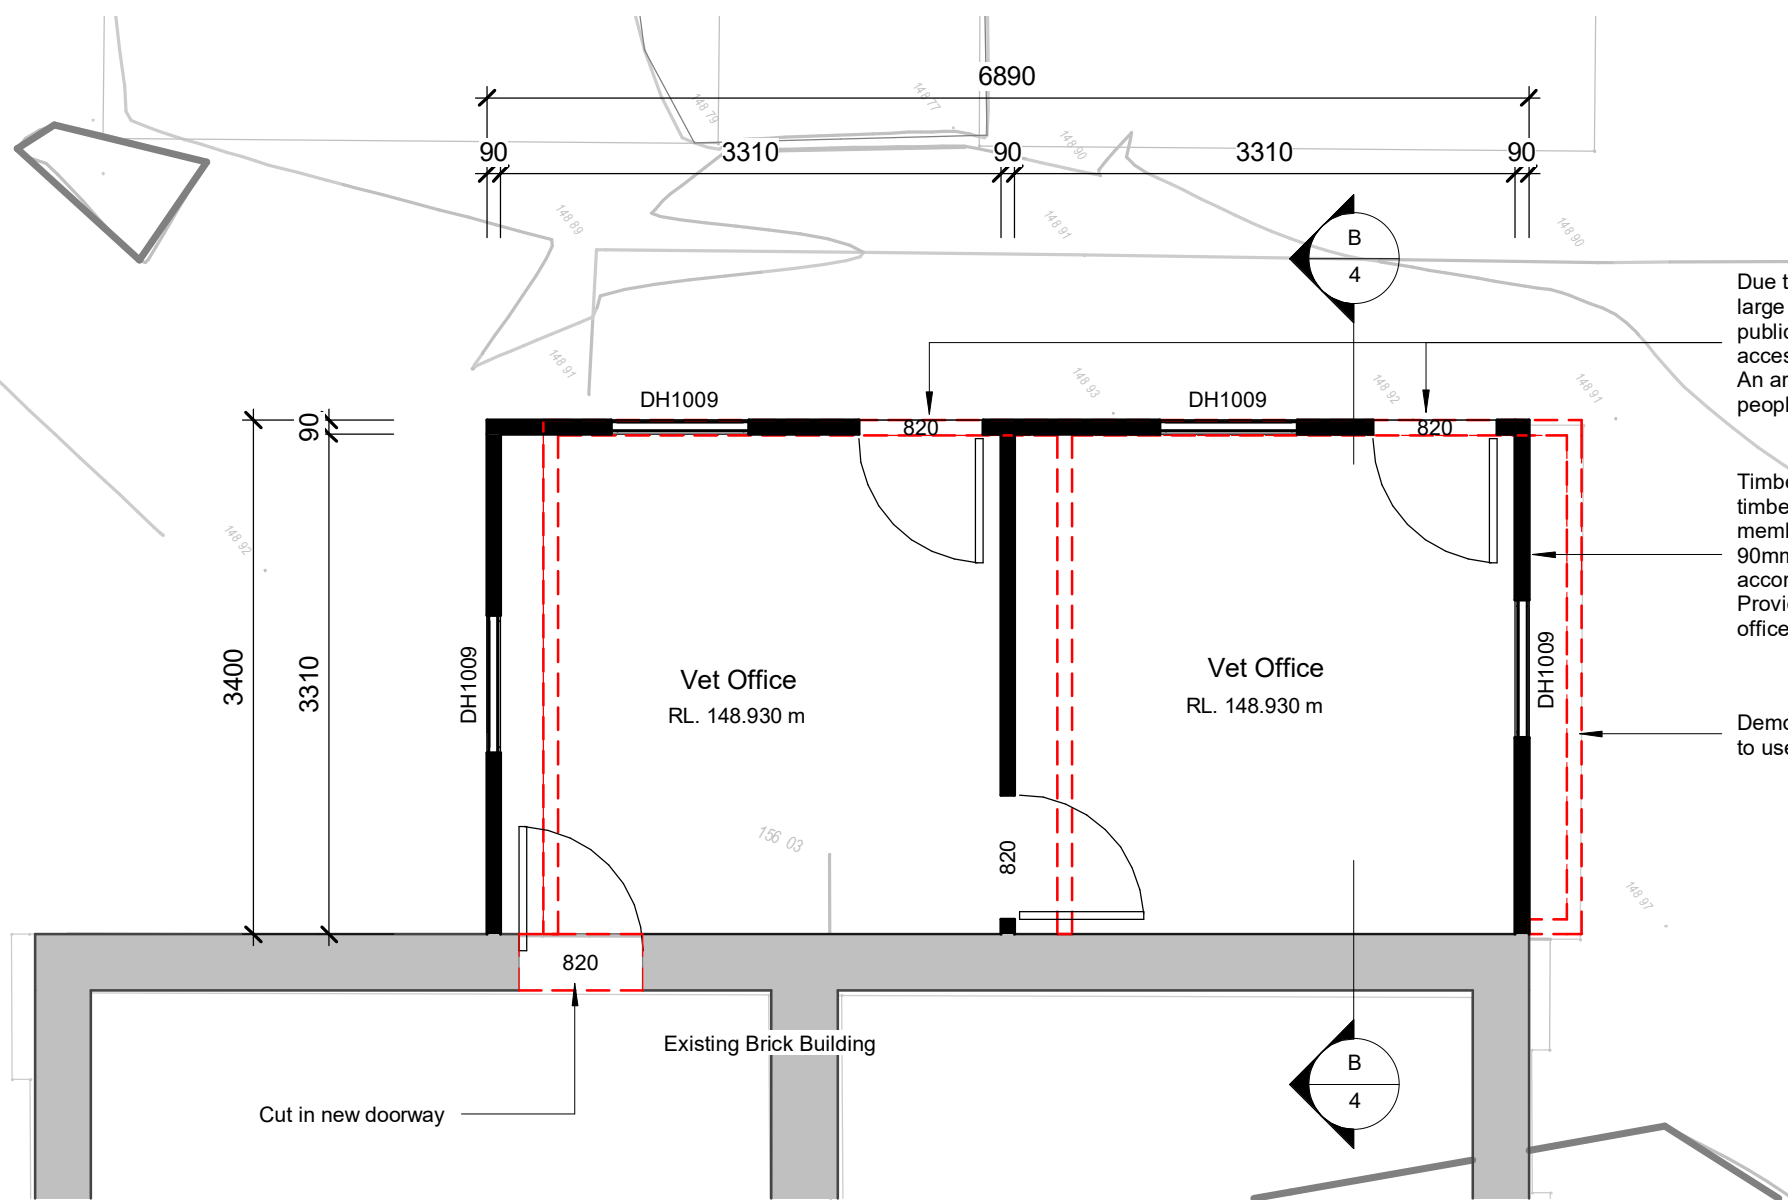
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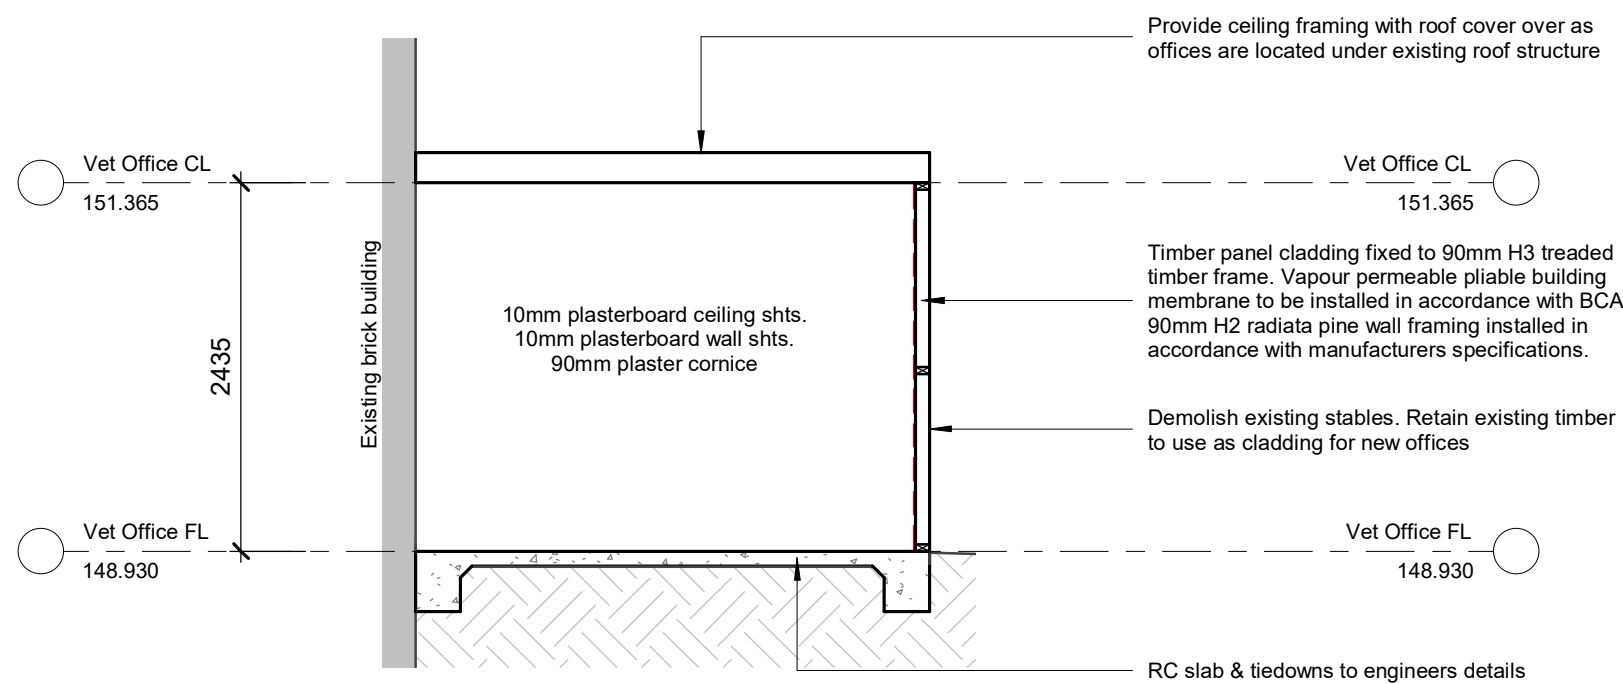
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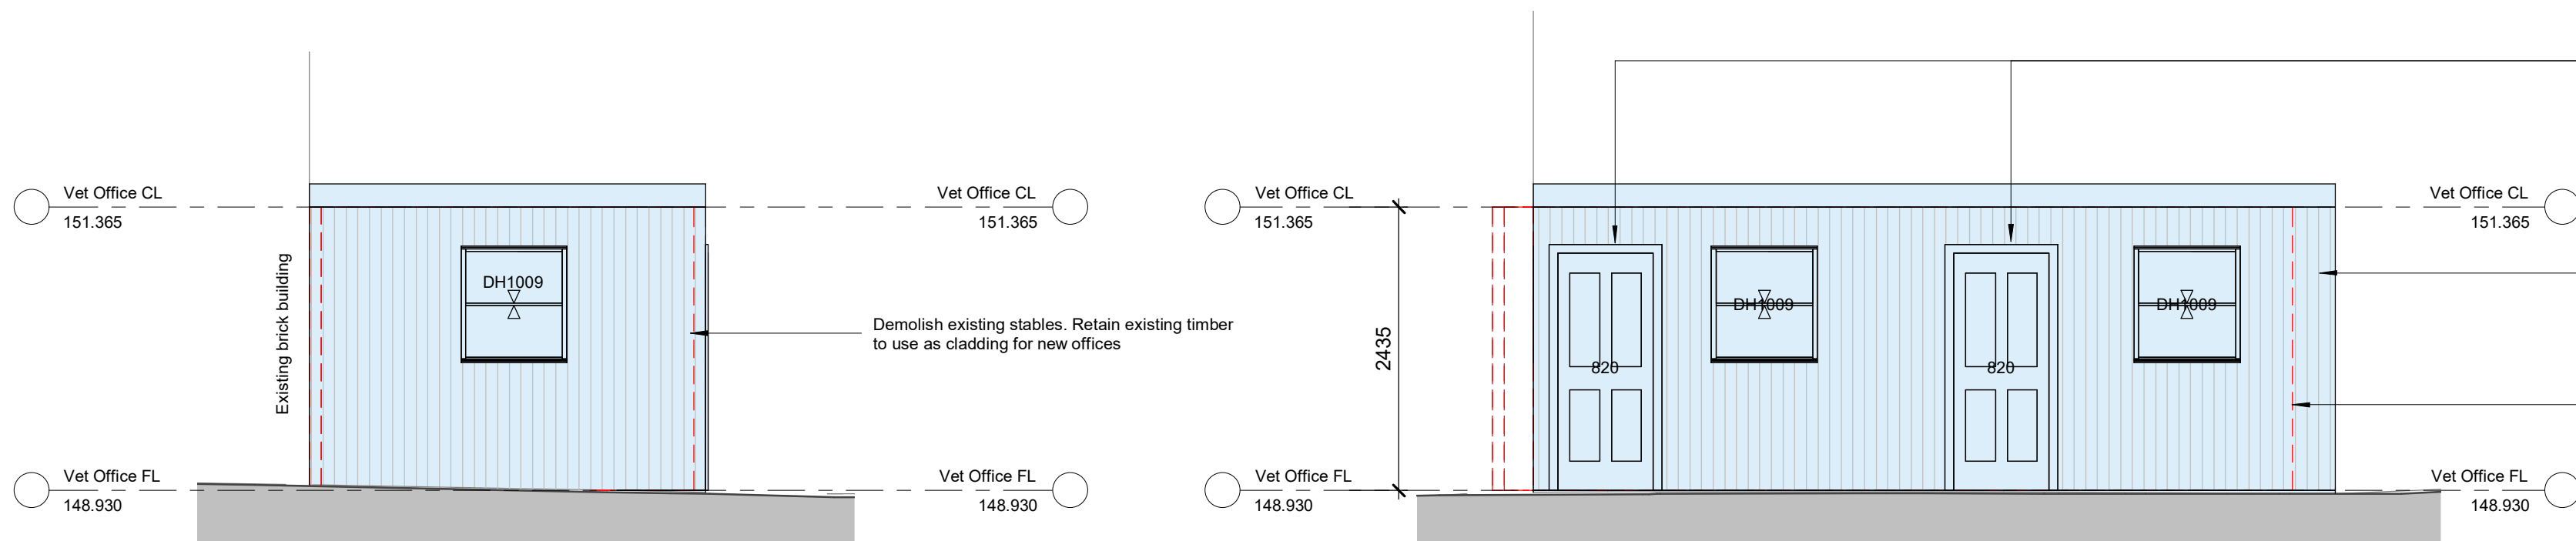
PROJECT PROPOSED RENOVATIONS & ACCESSIBLE ENTRY TO PET MEDICAL				
AT 14 ABERDEEN ST, MUSWELLBROOK				
FOR PET MEDICAL				
SIZE A1	SCALE As indicated	JOB No: 066-22	REV: A	
DATE 13/06/22	PDG	SHEET No: 3		




Proposed Vet Offices Plan
1 : 50



Section B
1 : 50



Proposed Vets Offices - Elevation 2
1 : 50

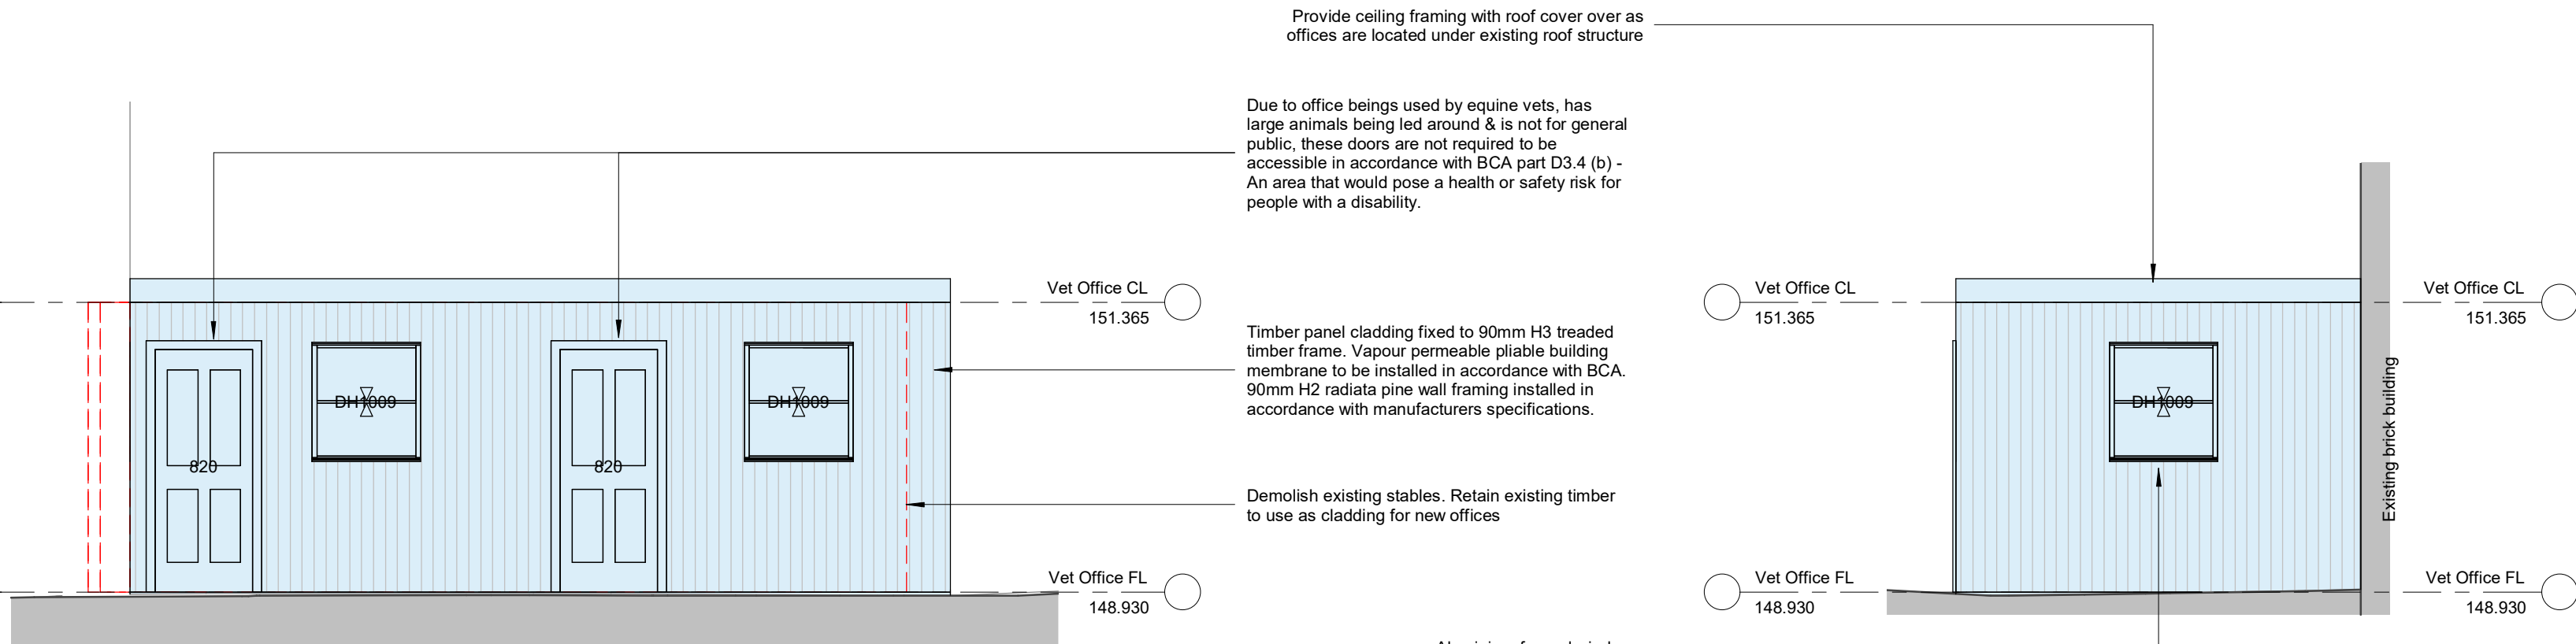

Proposed Vets Offices - Elevation 3
1 : 50

Proposed Vets Offices - Elevation 4
1 : 50

GENERAL NOTES:

CLASS 5 (Single Storey) - Type C Construction

RC slab to be in accordance with Engineers details.
All structural details to be designed & provided by an Engineer.
Written dimensions will take precedence over scale.
Floor finishes to comply with AS 1428.1 Part 7.
Provide external security lights to all exit doors.

All work & materials is to comply with section B of the BCA.

90mm stud walls with plasterboard wall sheeting or the like to selected internal walls.
Finish to remaining walls to be arranged with owners.
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All building work to comply with applicable parts of clause C.10 & Specification C1.10 of the BCA.
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Dry Ramp steeper than 1:14	P4 or R11	P5 or R12
Ramp steeper than 1:20 but not steeper than 1:14	P3 or R10	P4 or R11
Level or landing surface	P3 or R10	P4 or R11
Nosing or landing edge strip	P3	P4

Thresholds to comply with BCA part D2.15 & As 1428.1
Barriers to prevent falls to comply with BCA part D2.16
Doors opening to required exits must open in an outward direction in accordance with BCA part D2.20.
Door hardware to be supplied and installed in accordance with D2.21 of the BCA.
Door signage to comply with BCA part D2.23.
Disabled access to comply with BCA part D3 and AS1428.1
Install compliant signage in accordance with Part D3.6 and Spec D3.6 of the BCA.

Fire blanket to be installed in Kitchen in accordance with E1.10 of the BCA.
Fire extinguishers to be installed in accordance with Part E1.6 and Table E1.6 of the BCA.
Fire extinguishers must be provided during construction in accordance with part E1.9 of the BCA.
Smoke hazard management system to comply with BCA part E2.
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Building to be damp proofed in accordance with F1.9 of the BCA and high impact vapour barrier provided under slab as per F1.10.
All wet areas are to be graded and drained to a floor waste in accordance with F1.11 of the BCA.
All glazing to be supplied and installed in accordance with part F1.13 of the BCA & AS2047 & AS1288.
Ventilation of rooms to comply with Part F4.5 of the BCA.

Power load shall comply with Section J of the BCA.
All lighting to be installed in accordance with J6 of BCA.

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PROJECT
PROPOSED RENOVATIONS & ACCESSIBLE ENTRY TO PET MEDICAL

AT
14 ABERDEEN ST, MUSWELLBROOK

FOR
PET MEDICAL

SIZE	SCALE	As indicated	JOB No:	REV:
A1	DATE	13/06/22	066-22	
	DRAWN	PDG	SHEET No:	4

