# MULTI-RESIDENTIAL DEVELOPMENT

ΑT

59 TINDALE ST, MUSWELLBROOK

PROJECT NUMBER


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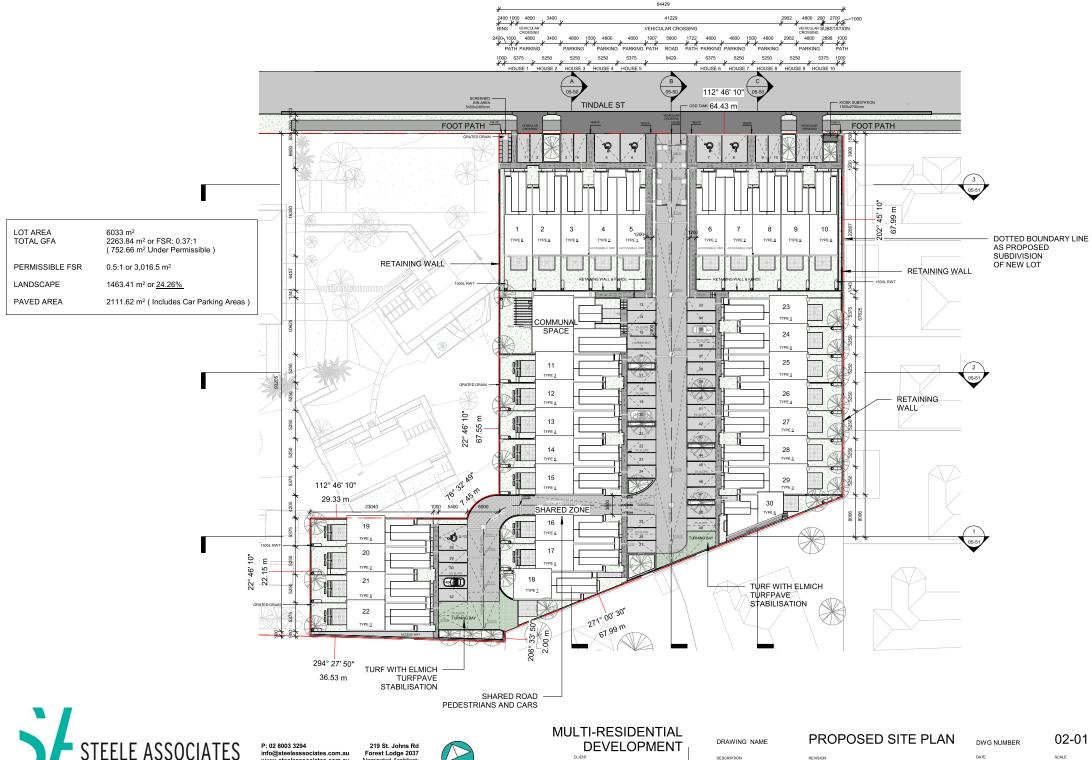
TINDALE INVESTMENTS PTY LTD

STAGE

DA SUBMISSION





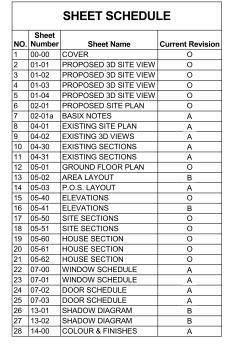

www.steeleassociates.com.au ABN: 43619 007 310

Nominated Architect: Oliver Steele 7474 (C) TINDALE INVESTMENTS PTY LTD

0

DA SUBMISSION

04/04/2023 1:500

### **TINDALE ST STAGE 2 ST19 - BASIX NOTES**

# COMMITMENTS FOR MULTI-DWELLING HOUSES

1.) DWELLINGS

# A.) WATER COMMITMEMTS

1.) THE APPLICANT MUST PLANT INDIGENOUS OR LOW WATER USE SPECIES OF VEGETATION THROUGHOUT THE AREA OF LAND SPECIFIED FOR THE DWELLING IN THE "INDIGENOUS SPECIES" COLUMN OF THE TABLE BELOW, AS PRIVATE LANDSCAPING FOR THAT DWELLING. (THIS AREA OF INDIGENOUS VEGETATION IS TO BE CONTAINED WITHIN THE "AREA OF GARDEN AND LAWN" FOR THE DWELLING SPECIFIED IN THE "DESCRIPTION OF PROJECT" TABLE).

SWIMMING POOL:

1.) THE APPLICANT MUST NOT INSTALL A PRIVATE SWIMMING POOL OR SPA FOR THE DWELLING, WITH A VOLUME EXCEEDING THAT SPECIFIED FOR IT IN THE TABLE BELOW. 2.) THE POOL OR SPA MUST BE LOCATED AS SPECIFIED IN THE TABLE.

### ALTERNATIVE WATER

AL TERMATIVE WATER

1, THE APPLICANT MUST INSTALL, FOR THE DWELLING, EACH
ALTERNATIVE WATER SUPPLY SYSTEM AT LEAST 1500 LITRES
INDIVIDUAL WATER TANK, TO COLLECT RUN-OFF FROM AT LEAST:
77.0 SQUARE METRES OF ROOF AREA, WITH LANDSCAPE A TOTAL
CONNECTIONS, (EXCLUDING ANY AREA WHICH SUPPLIES ANY OTHER ALTERNATIVE WATER SUPPLY SYSTEM), AND TO DIVERT OVERFLOW AS SPECIFIED. EACH SYSTEM MUST BE CONNECTED AS SPECIFIED.

	FIXTURES						
DWELLING NO.	ALL SHOWER HEADS	ALL TOILET FLUSHING SYSTEMS	ALL KITCHEN TAPS	ALL BATHROOM TAPS	HW RECIRCULATION OR DIVERSION		
ALL DWELLINGS	4 STAR (> 6 BUT <= 7.5 L/MIN)	4 STAR	4 STAR	4 STAR	NO		

# B.) ENERGY COMMITMENTS

HOT WATER:

1.)THE APPLICANT MUST INSTALL EACH HOT WATER SYSTEM

SPECIFIED FOR THE DWELLING IN THE TABLE BELOW, SO THAT THE

DWELLING'S HOT WATER IS SUPPLIED BY THAT SYSTEM. IF THE TABLE SPECIFIES A CENTRAL HOT WATER SYSTEM FOR THE DWELLING, THEN THE APPLICANT MUST CONNECT THAT CENTRAL SYSTEM TO THE DWELLING, SO THAT THE DWELLING'S HOT WATER IS SUPPLIED BY THAT CENTRAL SYSTEM.

NATURAL LIGHTING

1.)THIS COMMITMENT APPLIES TO EACH ROOM OR AREA OF THE DWELLING WHICH IS REFERRED TO IN A HEADING TO THE "NATURAL LIGHTING" COLUMN OF THE TABLE BELOW (BUT ONLY TO THE EXTENT SPECIFIED FOR THAT ROOM OR AREA). THE APPLICANT MUST ENSURE THAT EACH SUCH ROOM OR AREA IS FITTED WITH A WINDOW AND/OR

### ALTERNATIVE ENERGY

ALTERNATIVE ENERGY

1.)THE APPLICANT MUST INSTALL THE PHOTOVOLTAIC SYSTEM
SPECIFIED FOR THE DWELLING WITH THE CAPACITY TO GENERATE AT
LEAST 0.9 PEAK KILOWATTS OF ELECTRICITY AS PART OF THE DWELLING UNDER THE "PHOTOVOLTAIC SYSTEM" HEADING OF THE "ALTERNATIVE ENERGY" COLUMN OF THE TABLE BELOW, AND CONNECT TO THAT DWELLING'S ELECTRICAL SYSTEM.

	HOT WATER	BATHROOM VENTILAT	TION SYSTEM	KITCHEN VENTIL	ATION SYSTEM	LAUNDRY VENTILATION SYSTEM		
DWELLING NO.	HOT WATER SYSTEM	EACH BATHROOM	OPERATION CONTROL	EACH KITCHEN	OPERATION CONTROL	EACH LAUNDRY	OPERATION CONTROL	
ALL DWELLINGS	GAS INSTANTANEOUS 5.5 STAR	INDIVIDUAL FAN, DUCTED TO FACADE OR ROOF	MANUAL SWITCH ON/OFF	INDIVIDUAL FAN, DUCTED TO FACADE OR ROOF	MANUAL SWITCH ON/OFF	INDIVIDUAL FAN, NOT DUCTED	MANUAL SWITCH ON/OFF	

### C.) THERMAL COMFORT

1.) THE APPLICANT MUST SHOW ON THE PLANS ACCOMPANYING THE DEVELOPMENT APPLICATION FOR THE PROPOSED DEVELOPMENT, ALL MATTERS WHICH THE THERMAL COMPORT PROTOCOL REQUIRES TO BE SHOWN ON THOSE PLANS. THOSE PLANS MUST BEAR A STAMP OF ENDORSEMENT FROM THE ACCREDITED ASSESSOR, TO CERTIFY THAT THIS IS THE CASE

2.) WHERE THERE IS AN IN-SLAB HEATING OR COOLING SYSTEM, THE (aa) INSTALL INSULATION WITH AN R-VALUE OF NOT LESS THAN 1.0

(ab) INSTALL INSOLATION WITH AN R-VALUE OF NOT LESS THAN LA AROUND THE VERTICAL EDGES OF THE PERIMETER OF THE SLAB, OR (bb) ON A SUSPENDED FLOOR, INSTALL INSULATION WITH AN R-VALUE OF NOT LESS THAN 10 UNDERNEATH THE STAB AND AROUND THE VERTICAL EDGES OF THE PERIMETER OF THE SLAB.

3.) THE APPLICANT MUST CONSTRUCT THE FLOORS AND WALLS OF THE DEVELOPMENT IN ACCORDANCE WITH THESE SPECIFICATIONS: DWELLING NO. 30 CONCRETE SLAB ON GROUND IS 55M2 AND ALL OTHER DWELLINGS CONCRETE SLAB ON GROUND IS 71M2.

	THERMAL LOADS							
DWELLING NO.	AREA ADJUSTED HEATING LOAD (IN MJ/M²/YR)	AREA ADJUSTED COOLING LOAD (IN MJ/M²/YR)						
1	229.0	9.2						
2	183.0	8.8						
3	183.9	8.0						
4	186.2	14.0						
5	230.2	14.6						
6	222.5	11.1						
7	187.7	13.3						
8	183.2	8.3						
9	182.3	8.9						
10	230.1	9.7						
11	172.7	24.4						
12	170.3	23.9						
16	203.5	22.8						
17	178.5	24.4						
18	239.7	16.1						
19	202.7	22.1						
23	208.7	9.8						
26	167.9	9.6						
29	184.4	10.0						
30	235.4	11.9						
13, 20	172.7	24.2						
14, 21	171.7	23.1						
15, 22	207.7	23.1						
24, 28	168.3	11.9						
ALL OTHER DWELLINGS	169.6	10.0						



COMMITMENTS FOR COMMON AREAS AND CENTRAL SYSTEMS/FACILITIES FOR THE DEVELOPMENT (NON-BUILDING

# A.) WATER

1.) THE APPLICANT MUST INSTALL (OR ENSURE THAT THE DEVELOPMENT IS SERVICED BY) THE ALTERNATIVE WATER SUPPLY SYSTEM(S) SPECIFIED IN THE "CENTRAL SYSTEMS" COLUMN OF THE TABLE BELOW. IN EACH CASE, THE SYSTEM MUST BE SIZED, BE CONFIGURED AND BE CONNECTED AS SPECIFIED IN THE TABLE

2.) A SWIMMING POOL OR SPA LISTED IN THE TABLE MUST NOT HAVE A VOLUME (IN KLS) GREATER THAN THAT SPECIFIED FOR THE POOL OR

# B.) ENERGY SYSTEMS AND FIXTURES

1.) THE APPLICANT MUST INSTALL THE SYSTEMS AND FIXTURES SPECIFIED IN THE "CENTRALENERGY SYSTEMS" COLUMN OF THE TABLE BELOW. IN EACH CASE, THE SYSTEM OR FIXTURE MUST BE OF THE TYPE, AND MEET THE SPECIFICATIONS, LISTED FOR IT IN THE

	COMMON AREA VENTILATION SYSTEM						
COMMON AREA	AVENTILATION SYSTEM TYPE	VENTILATION EFFICIENCY MEASURE					
COMMUNITY ROOM	AIR CONDITIONING SYSTEM	TIME CLOCK OR BMS CONTROLLED					

	COMMON AREA LIGHTING							
COMMON AREA	PRIMARY TYPE OF ARTIFICIAL LIGHTINGS	LIGHTING EFFICIENCY MEASURE	LIGHTING CONTROL SYSTEM/BMS					
COMMUNITY ROOM	LIGHT-EMITTING DIODE	TIME CLOCKS	NO					

	COOLING		HEATING		ARTIFICIAL LIGHTING					NATURAL LIGHTING		
DWELLING NO.	LIVING AREAS	BEDROOM AREAS	LIVING AREAS	BEDROOM AREAS	NO. OF BEDROOMS &/OR STUDY	NO. OF LIVING &/OR DINING ROOMS	EACH KITCHEN	ALL BATHROOMS/TOILETS	EACH LAUNDRY	ALL HALLWAYS	NO. OF BEDROOMS &/OR TOILETS	MAIN KITCHEN
18	1-PHASE AIRCONDITIONING 2.5 STAR (OLD LABEL)	1-PHASE AIRCONDITIONING 2.5 STAR (OLD LABEL)		1-PHASE AIRCONDITIONING 2.5 STAR (OLD LABEL)	2 (DEDICATED)	1 (DEDICATED)	YES (DEDICATED)	YES (DEDICATED)	YES (DEDICATED)	YES (DEDICATED)	0	YES
30	1-PHASE AIRCONDITIONING 2.5 STAR (OLD LABEL)	1-PHASE AIRCONDITIONING 2.5 STAR (OLD LABEL)		1-PHASE AIRCONDITIONING 2.5 STAR (OLD LABEL)	1 (DEDICATED)	1 (DEDICATED)	YES (DEDICATED)	YES (DEDICATED)	YES (DEDICATED)	YES (DEDICATED)	0	YES
4,5,6,7	1-PHASE AIRCONDITIONING 2.5 STAR (OLD LABEL)	1-PHASE AIRCONDITIONING 2.5 STAR (OLD LABEL)		1-PHASE AIRCONDITIONING 2.5 STAR (OLD LABEL)	1 (DEDICATED)	1 (DEDICATED)	YES (DEDICATED)	YES (DEDICATED)	YES (DEDICATED)	YES (DEDICATED)	0	NO
ALL OTHER DWELLINGS	1-PHASE AIRCONDITIONING 2.5 STAR (OLD LABEL)	2 (DEDICATED)	1 (DEDICATED)	YES (DEDICATED)	YES (DEDICATED)	YES (DEDICATED)	YES (DEDICATED)	0	NO			



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219 St. Johns Rd Forest Lodge 2037 Nominated Architect Oliver Steele 7474 (C) MULTI-RESIDENTIAL DEVELOPMENT

DRAWING NAME


**BASIX NOTES** 

DWG NUMBER

SCALE 1:1000

02-01a

DESCRIPTION REVISION TINDALE INVESTMENTS PTY LTD DA SUBMISSION 24/03/2023 Α

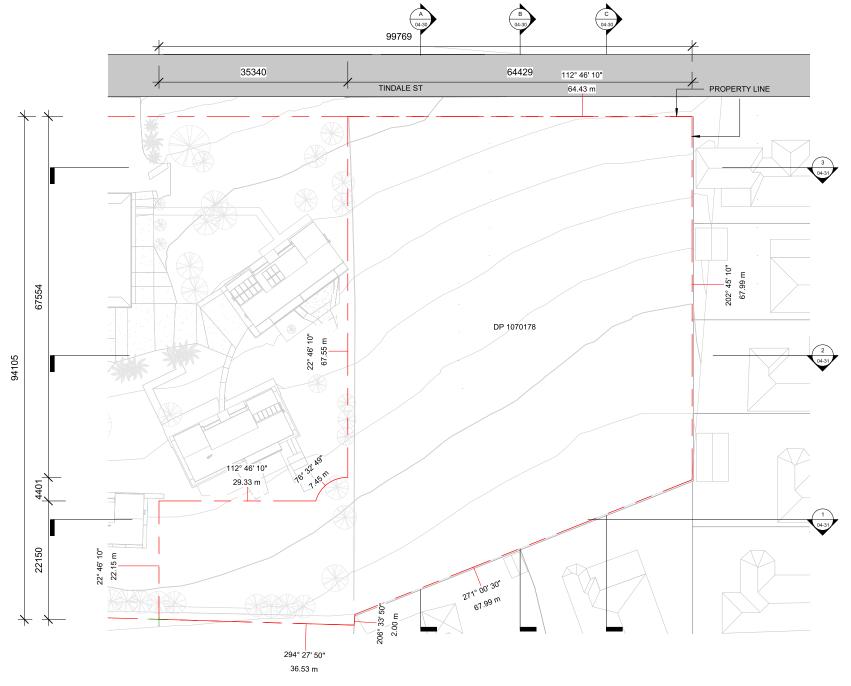



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**EXISTING SITE PLAN** 

DRAWING NAME


DA SUBMISSION

DWG NUMBER DATE

04-01





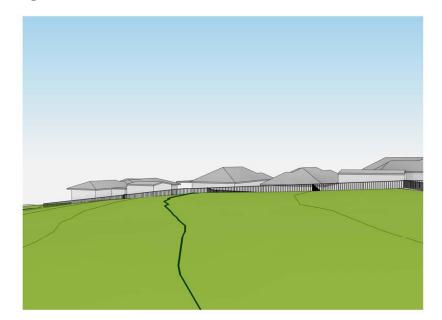

EXISTING WEST VIEW




EXISTNG SOUTH VIEW



EXISTING EAST VIEW

DA SUBMISSION


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DRAWING NAME

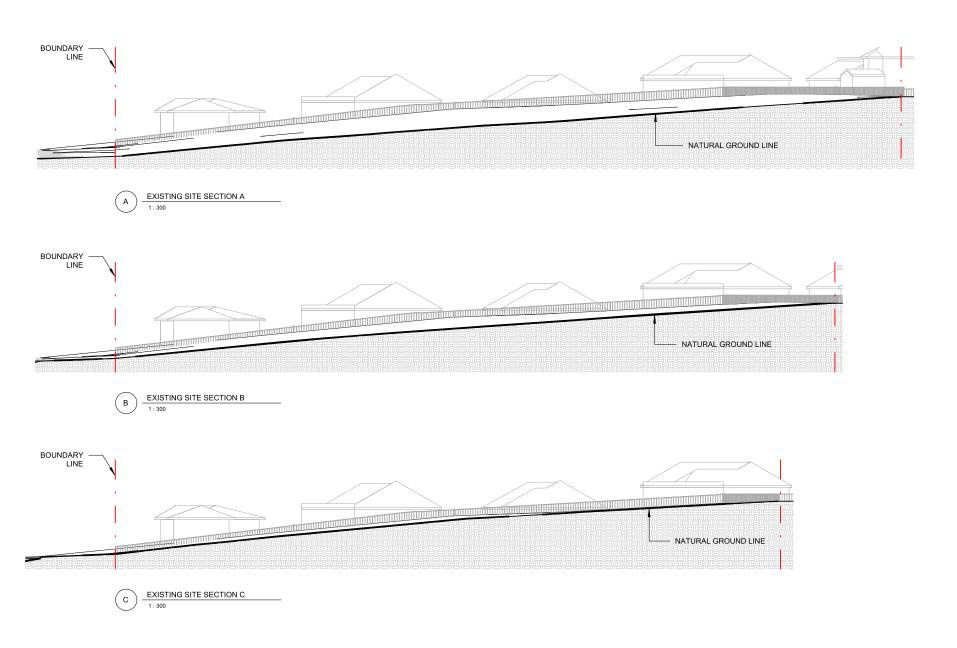DA SUBMISSION

DESCRIPTION



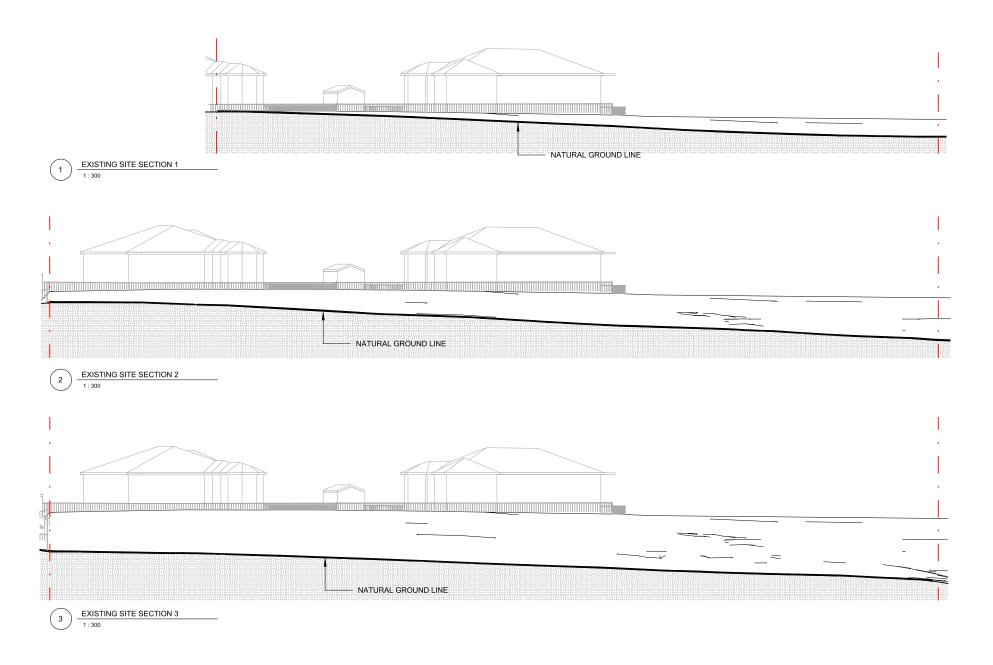


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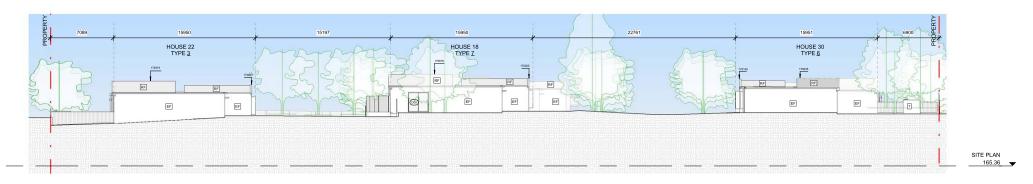
DA SUBMISSION

1:300

09/02/2023

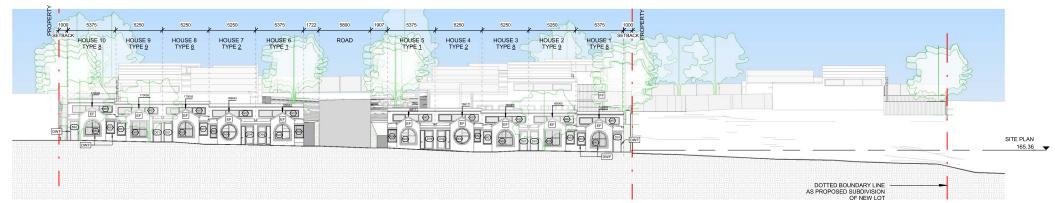

STREETSCAPE ELEVATION



SOUTH ELEVATION

EXTERIOR WALL FINISH

ROOF FINISH

INTERNAL WALL FINISH

FENCES FINISH

WINDOWS & DOORS FRAMES

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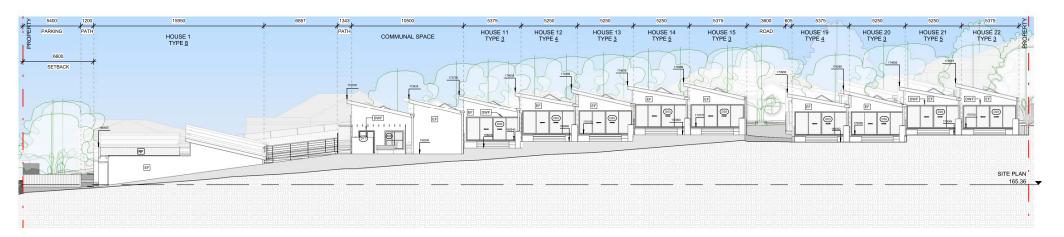
**ELEVATIONS** 

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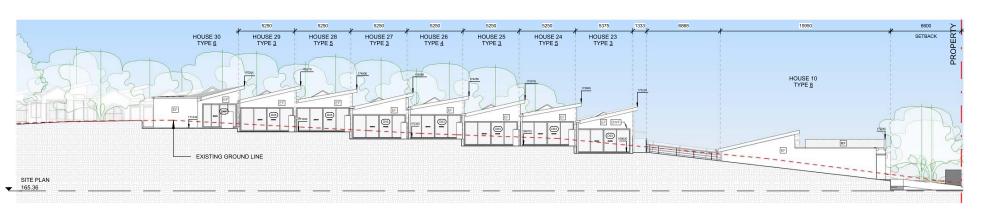
05-40 DWG NUMBER

As indicated

04/04/2023



1 WEST ELEVATION



EAST ELEVATION

STEELE ASSOCIATES

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DRAWING NAME ELEVATIONS
DESCRIPTION REVISION

DA SUBMISSION

EXTERIOR WALL FINISH


INTERNAL WALL FINISH
WINDOWS & DOORS FRAMES


DWG NUMBER 05-41


04/04/2023

ROOF FINISH


As indicated

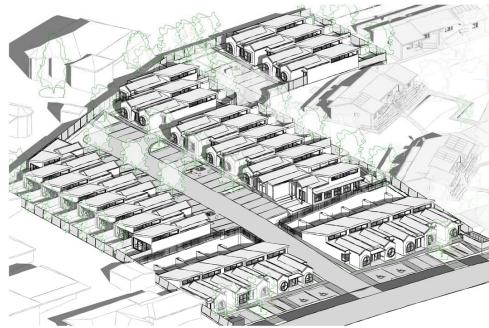

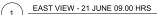


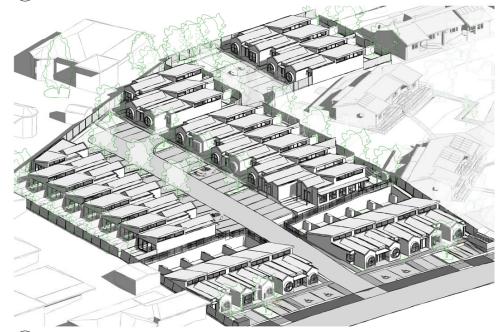

EAST VIEW - 21 JUNE 11.00 HRS

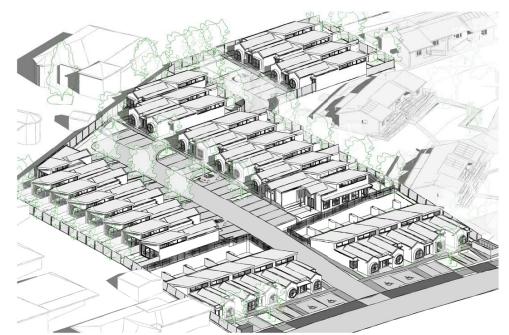

EAST VIEW - 21 JUNE 10.00 HRS

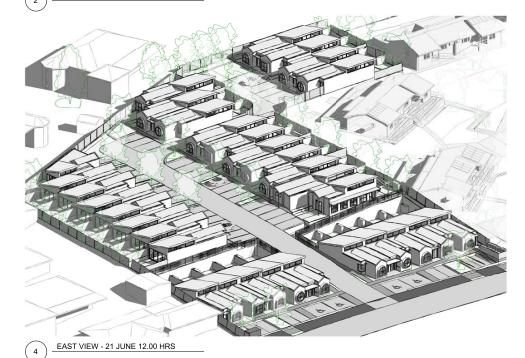

MULTI-RESIDENTIAL DEVELOPMENT

DRAWING NAME

DESCRIPTION

DA SUBMISSION

SHADOW DIAGRAM

DWG NUMBER

SCALE

13-01







EAST VIEW - 21 JUNE 15.00 HRS

DA SUBMISSION

NATURAL WHITE

**EF** EXTERIOR WALL FINISH

**DULUX NATURAL WHITE** RGB - 237 - 237 - 227

ROOF FINISH

DULUX WOODLAND GREY RGB - 083 - 084 - 079

**VIVID WHITE** 

B12

INTERNAL WALL FINISH

**DULUX VIVID WHITE** RGB - 244 - 246 - 235

FENCES FINISH

COLORBOND WOODLAND GREY RGB - 075 - 076 - 070

**VIVID WHITE** 

**DWF** WINDOWS & DOORS FRAMES

DULUX VIVID WHITE RGB - 244 - 246 - 235



Α

DA SUBMISSION

1:15