

118 Maitland Street, Muswellbrook Preliminary Site Investigation February 2024

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Approval and Authorisation

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1 INTRODUCTION

1.1 Background

Broadcrest Consulting Pty. Ltd. was engaged by Curious Minds Early Learning Centre PTY LTD to conduct a Preliminary Site Investigation at 118 Maitland Street, Muswellbrook (hereafter referred to as the site). The assessment will accompany a Development Application for the proposed construction of a new childcare centre.

A site inspection was undertaken on 23 January 2024 which involved a visual assessment of accessible areas of concern on the site, and the drilling of four (4) soil profiling boreholes. Details of the findings are presented within the body of this report, as well as an assessment of significance with regards to the findings of the investigation.

1.2 Objectives

The objectives of the Preliminary Site Investigation (PSI) are to:

- To identify any past or present potentially contaminating activities
- To describe the site and discuss its condition
- To determine the nature and possible extent of any contamination on site
- To identify potential contamination migration routes, and
- To determine the need for any further Detailed Site Investigation (DSI).

1.3 Scope of Works

The scope of works included the following:

- Acquisition of a Mapping and Spatial Information Report (Appendix B) comprising;
 - Cadastre and topography
 - Historical aerial imagery
 - o EPA Contaminated Land Records and Records of Notice
 - Previous land uses
 - Groundwater bores
 - o Geology and soils
 - Land zoning
- Acquisition and review of Historical Land Titles
- Acquisition and review of Section 10.7 Planning Certificate
- A review of past and current site uses
- An inspection of accessible areas of concern the site
- Drilling of soil profiling boreholes, and
- Reporting in accordance with the associated legislations and guidelines.

This assessment does **not** include a hazardous building materials assessment of any buildings. Where necessary, it is recommended that be undertaken by a suitably licensed and experienced building inspector / hygienist or equivalent prior to any future alterations or demolition.

1.4 Legislative Requirements

The legislative framework for the report is based on State Environmental Planning Policy (Resilience and Hazards) and the following Acts and Regulations:

- Protection of the Environment Operations Act (1997)
- Contaminated Land Management Act (1997)
- Protection of the Environment Operations (General) Regulation 2021

In addition, the following guidelines have been applied where necessary:

- Sampling Design Guidelines (NSW EPA, 1995)
- Guidelines for Consultants Reporting on Contaminated Sites (NSW EPA, 2020).
- National Environmental Protection Measure (NEPC, 2013)
- Waste Classification Guidelines Part 1: Classifying Waste (NSW DECCW, 2014)
- Australian Standard AS 4482.1 Guide to the Sampling and Investigation of Potentially Contaminated Soil. Part 1: Non-volatile and Semi-Volatile Compounds

1.5 Proposed Development

The assessment will accompany a Development Application for the proposed construction of a childcare centre consisting of on-site structure and landscaped areas (Figures 1.1 and 1.2). Included in the proposal is an underground basement carpark



Figure 1-1: Proposed childcare centre.



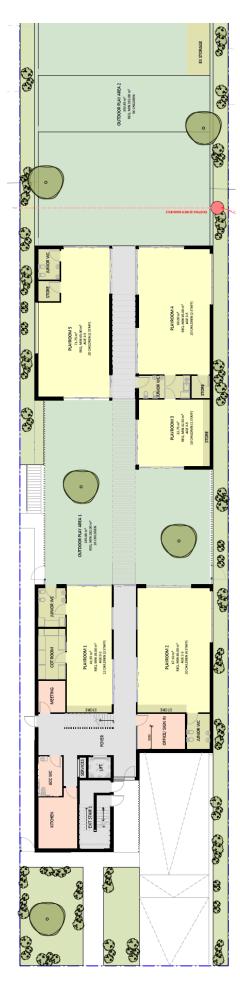


Figure 1-2: Partial site plan delineating location of on-site structures and landscaped areas.

2 PRELIMINARY SITE INVESTIGATION

2.1 Site Identification and Location

The site is 118 Maitland Street, Muswellbrook (Lot 34 of DP 229367) (Figure 2.1). It occupies approximately 1,397m² of Residential (R1) zoned land within Muswellbrook LGA.



Figure 2-1: Site Location (NSW Spatial Information Exchange)

2.2 Site inspection

A site inspection was undertaken on 23 January 2024 by Broadcrest Pty Ltd consultant Cheyne Hudson (CEnvP). At the time of inspection, the site was occupied by a single-story residential structure, driveway and carport within a low-density residential setting. The dwelling has been constructed on bearers and joists connected to brick piers. The remainder of the site consists of lawn and scattered trees at the rear. There were no obvious visual indicators of site contamination.

The investigation focused primarily on the proposed childcare centre as displayed in Figure 1.2. Photographs of the existing site structures and land-use setting are provided in Figures 2.2 and 2.3.



Figure 2-2: On-site residential structure, as viewed from Maitland Street facing north-east.



Figure 2-3: Rear yard, as viewed from rear of property facing south-west.

2.3 Surrounding land use

The site is situated within a parcel of Low-Density Residential (R1) zoned land, the other surrounding land use includes parcels of Productivity Support (E3) to the west and north-west, and Private Recreation (RE2) on the north-western boundary of the site, per Muswellbrook Council DCP. The site is bordered by:

- Low-Density Residential use to the north
- Low-Density Residential and mixed commercial to the south
- Muscle Creek and Muswellbrook Golf Course to the north-east, and
- New England Highway, followed by mixed residential and commercial land usage to the south-west.

2.4 Topography

The site occupies a relatively flat surface, ranging from approximately 151 – 152 m AHD, sloping softly to the north-east, at a gradient <5%. However, the sites natural topography has been altered slightly in the southern portion of the site, having been filled and levelled (Figure 2.4)



Figure 2-4: Photograph depicting front yard of site, location of potential uncontrolled filling.

2.5 Visual Amenity

The site was in use in a low-density residential setting. The site was vegetated with both native and foreign grasses. No visual amenity issues were noted.

2.6 Geology and Soil Landscape Mapping

A review of NSW Government SEED eSpade (v2.2) indicates the site occurs on the Hunter Soil Landscape. The Hunter Soil Landscape consists of level plains and river terraces of the Hunter River with elevations of 20 - 60 m. Slopes are 0 - 3%. The width of the plains ranges from 200 - 3,200 m. Local relief is generally less than 10 m.

The main soils are all formed in alluvium. They include Brown Clays and Black Earths (Ug5.34, Ug5.17) on prior stream channels and on tributary flats, with Chernozems (Uf5.1) on prior stream channels adjacent to Dartbrook and Brays Hill soil landscapes and in many of the valleys such as Martindale and Widden. Alluvial Soils (loams – Um5 and sands – Um5.52, Um6.1, Uc) occur on levees and flats adjacent to the present river channel. Red Podzolic Soils and Lateritic Podzolic Soils (Dr2.11, Db2.41) are located on old terraces, with Non-calcic Brown Soils (Db1.13) and Yellow Solodic Soils in some drainage lines.

2.7 Surface and Ground Water Hydrology

The site currently consists of almost 90% permeable vegetated surface. Stormwater infiltration is expected to be moderate on across the site surface. Prevailing run-off direction is east towards Muscle Creek on the north-eastern (down-gradient) boundary of the site.

A review of regional groundwater bores has been undertaken (Appendix B). Nine (9) bores were identified within 250m search radius of the site. Table 2.1 below lists those bores within 250m of the site. Bore depths within the search radius range between 6.0m – 10.1m BGL with no recorded standing water levels within any of the bores. It is considered unlikely that site activities have detrimentally impacted upon groundwater. Similarly, groundwater is highly unlikely to pose any kind of vapour issue in this locality.

Table 2.1: Groundwater Bores within 250m

Reference	Elevation (mAHD)	Drill Depth (m)	SWL (mBGL)	Purpose
21010151.1.1	150.3	N/A	N/A	N/A
GW022043.1.1	151.73	N/A	N/A	Irrigation
GW022229.1.1	160.69	10.1	N/A	Irrigation
GW022230.1.1	151.33	6.7	N/A	Irrigation
GW023484.1.1	153.12	7.6	N/A	Irrigation
GW029528.1.1	151.24	6.4	N/A	Irrigation
GW032825.1.1	151	6	N/A	Irrigation
GW034580.1.1	152.64	9.1	N/A	Irrigation

GW043852.1.1	151.72	6	N/A	Irrigation
GW044696.1.1	152.44	7.3	N/A	Water Supply

2.8 Receptors and Sensitive Environments

The nearest sensitive environmental receivers delineated on Figure 2.5 and are as follows:

- Muscle Creek, a tributary to Hunter River located on the north-eastern boundary of the site (down-gradient)
- Residential properties, located on the northern and southern site boundary (up-gradient)

There are no schools, pre-schools, day care centres or similar within 100m of the site.

2.9 Fill Materials

The sites natural topography has been altered to a minor extent within the south-eastern portion of the yard, consisting of potentially uncontrolled cutting and filling (circa 2019). Borehole drilling within the front yard (south-eastern portion of site) indicates that potential coal wash material had been used for filling to 300mm depth on the site.

Four (4) boreholes were drilled across the site – two (2) within the south-eastern portion of the site, one (1) within the central portion of the site and one (1) within the northern site extent (Figure 2.6). The two (2) boreholes within the south-eastern portion of the site revealed shallow fill material consisting of coal-wash. Remaining soil boreholes revealed a natural profile reminiscent of the local soil landscape.

No odours or foreign materials, were observed within any borehole. Soil Logs are provided below and photographs are available within Appendix C.

Boreholes 1 and 4

0 – 300 mm Dark-grey coal-wash material

300 – 1,600+mm Silty CLAY with trace sand and gravel

1,600 – 4,900mm Silty Clayey SAND with gravel

4,900 mm Refusal – conglomerate or cobbles.

Borehole 2 and 3

0 – 1,600+mm Silty CLAY with trace sand and gravel

1,600 – 4,900mm Silty Clayey SAND with gravel

4,900 mm Refusal – conglomerate or cobbles.



Figure 2-5: Site boundary showing prominent and sensitive features within 100m offset



Figure 2-6: Location of boreholes drilled on site

2.10 Material Storage and Handling

A site inspection was undertaken on 23 January 2024 by Broadcrest Pty Ltd consultant Cheyne Hudson (CEnvP). At the time of inspection, the site was occupied. The property was being used for low-density residential purposes. It is anticipated that low volumes of chemicals would have been stored within original packaging within cupboards and sheds on site. However, no large volumes of chemicals are expected to have been stored on site.

2.11 NSW EPA Site Records

A strategy to systematically assess, prioritise and respond to notifications under the Contaminated Land Management Act 1997 (CLM Act) has been developed by the EPA. This strategy acknowledges the EPA's obligations to make information available to the public under Government Information (Public Access) Act 2009.

Sites appearing in the list of *NSW Contaminated Sites Notified to the EPA* indicate that the notifiers consider that the sites are contaminated and warrant reporting to EPA. However, the contamination may or may not be significant enough to warrant regulation by the EPA. The EPA needs to review and, if necessary, obtain more information before it can determine as to whether the site warrants regulation. A site will appear on the *Contaminated Land: Record of Notices* once the EPA has issued a regulatory notice in relation to the site under the Contaminated Land Management Act 1997 (CLM Act) or Protection of the Environment Operations Act 1997 (POEO Act).

Facilities will also appear on the *Register of Environmental Protection Licenses* once a license application has been submitted, approved or revoked under the Protection of the Environment Operations Act 1997 (POEO Act). A search on all databases for the site and premises within 250m thereof was undertaken (Appendix B). The results are provided within Tables 2.2 – 2.7.

Table 2.2: List of Sites Notified to the NSW EPA within 250m

Site	Reference	Activity	Distance	Direction
Nil	-	-	-	-

Table 2.3: List of NSW EPA Listed Contaminated Sites within 250m

Site	Address	Activity	Distance	Direction
Nil	-	-	-	-

Table 2.4: List of NSW EPA Monitored Sites within 250m

Site	License	Address	Activity	Distance	Direction
Nil	-	-	-	-	-

Table 2.5: List of NSW EPA Licensed Premises within 250m

Site	License	Address	Activity	Distance	Direction
Nil	-	-	-	-	-

Table 2.6: National Liquid Fuel Facilities within 250m

Site	Address	Activity	Distance	Direction
Nil	-	-	-	-

Table 2.7: POEO Notices Issued Sites within 500m

Site	Address	Туре	Distance	Direction
Nil	-	-	-	-

2.12 Historical Business Directories

A list of Dry Cleaners, Motor Garages & Service Stations registered with Google within 500m of the site was compiled. Results mapped to premises or road intersection accuracy are summarised in Table 2.8 below. Results from further abroad or mapped with less accuracy can be viewed within Appendix B.

Table 2.8: Dry Cleaners, Motor Garages & Service Stations registered with Google within 500m

Name	Activity	Distance	Direction
GHG Mechanical	Mechanical	65m	South-east
Muswellbrook Toyota and Hino	Car Sales / repairs	115,	West

2.13 Section 10.7 Certificate

Section 10.7 certificates as issued by Lithgow City Council has been reviewed (Appendix D). With regard to Section 59(2) of the Contaminated Land Management Act 1997, Council is NOT aware of either allotment being:

- Significantly contaminated land within the meaning of that Act
- Subject to a management order within the meaning of that Act
- Subject of an approved voluntary management proposal
- Subject to an ongoing maintenance order within the meaning of that Act, or
- Subject of a site audit statement within the meaning of that Act.

Council is NOT aware that the land includes residential premises that are listed on the Register kept under the *Home Building Act 1989*, Part 8, Division 1A (loose-fill asbestos insulation).

2.14 Historical Land Titles

A review of Historical Land Titles as provided by InfoTrack Pty Ltd was undertaken (Appendix E), a summary of which is provided within Tables 2.9. It is noted that.

- Muswellbrook Coal Company Pty Limited and J. & A. Brown & Abermain Seaham Collieries Limited were a co-owner of the site between 1967 1977
- Leases Nil

Table 2.9: Historical Land Titles

Date of Acquisition and term held	Registered Proprietor(s) & Occupations where available	Reference to Title at Acquisition and sale
27.12.1956 (1956 to 1957)	William Joseph Davies (Timber Getter)	Volume 7226 Folio 60
04.01.1957 (1957 to 1966)	Herbert Walter Hollins (Labourer)	Volume 7226 Folio 60 Then Volume 9615 Folio 98 Now Volume 10366 Folio 232
16.09.1966 (1966 to 1967)	Ronald Walter Ellis James (Surveyor) Cynthia Rose James (Married Woman)	Volume 10366 Folio 232
23.06.1967 (1967 to 1977)	Wood Hall Holdings Limited Now Wood Hall Limited J. & A. Brown & Abermain Seaham Collieries Limited Muswellbrook Coal Company Pty Limited	Volume 10366 Folio 232
15.11.1977 (1977 to 1982)	J. & A. Brown & Abermain Seaham Collieries Limited Wood Hall Limited	Volume 10366 Folio 232
30.07.1982 (1982 to 2008)	Lyndon Theo Piefke Sharon Lee Piefke	Volume 10366 Folio 232 Now 34/229637
18.04.2008 (2008 to 2011)	Gregory Lynne Hall Linda Emily Hall	34/229637
13.10.2017 (2017 to 2022)	Gregory Lynne Hall	34/229637
21.12.2022 (2022 to date)	# Lilianne Abounader # Jacky Angelovska	34/229637

2.15 Historical Aerial Photographs

A review of historical aerial photographs provided in Appendix B was undertaken. The results of which are summarised in Table 2.12.

Table 2.12: Findings of the Historical Photograph Review

Year	Description
1958	 Very low resolution black and white aerial photograph Site vegetated with pasture grass Dirt road parallel to south-western boundary Creek line running adjacent north-eastern site boundary Surrounding region largely undeveloped with minor rural residential structures Land to north in use as golf course
1974	 Low resolution black and white aerial photograph Residential structure constructed in southern portion of site Two (2) small sheds appear in north-eastern corner of site Surrounding region beginning to be developed for Low-Density Residential use
1989	 Moderate resolution colour aerial image No significant changes to site New warehouse developed approximately 120m north-west of site One (1) small shed appears on central northern boundary of site
1998	 Moderate resolution colour aerial image No significant changes to site
2017	 High resolution colour aerial image Sheds in north-eastern corner of site have been removed
2019	 High resolution colour aerial image Earthworks occurring in south-eastern portion of site
2020	 High resolution colour aerial image One (1) small shed appears on central northern boundary of site – replaces previous Rubbish appears on north-eastern boundary of site, both within and outside of site extent
2021	 High resolution colour aerial image No significant changes to site
2022	 High resolution colour aerial image Rubbish on north-eastern portion of site cleared
2023	 High resolution colour aerial image No significant changes to site Conditions per site inspection

2.16 Key Points

- The site has been occupied since pre-1974
- No indicators of significant demolition works were observed
- Minor earthworks and potentially uncontrolled filling occurred within the south-eastern portion of the site in 2019.

2.17 Information Gaps

A site history has been established using the sources outlined in Section 2 above. Although inferences have been drawn based on 'point in time' documents and aerial photographs, the information presented is consistent the industry standard and considered suitable for assessing the overall site history.

3 SUMMARY OF FINDINGS AND RECOMMENDATIONS

3.1 Site Observations

A site inspection was undertaken on 23 January 2024 by Broadcrest Pty Ltd consultant Cheyne Hudson (CEnvP). At the time of inspection, the site was occupied by a single-story residential structure, driveway and carport within a low-density residential setting. The dwelling has been constructed on bearers and joists connected to brick piers. The remainder of the site consists of lawn and scattered trees at the rear.

The site natural topography has been altered in the south-eastern portion of the site, consisting of a minor level of earthworks and potential importation and spreading of coal wash. Four (4) boreholes were drilled across the site – two (2) within the south-eastern portion of the site, one (1) within the central portion of the site and one (1) within the north-eastern portion of the site. The two (2) boreholes within the south-eastern portion of the site revealed shallow fill materials consisting of coal-wash. Remaining soil boreholes revealed a natural profile reminiscent of the local soil landscape. No odours or foreign materials, were observed within any borehole

3.2 Regional

The site is situated within a parcel of Low-Density Residential (R1) zoned land, the other surrounding land use includes parcels of Productivity Support (E3) to the west and north-west, and Private Recreation (RE2) on the north-western boundary of the site, per Muswellbrook Council DCP. The site is bordered by:

- Low-Density Residential use to the north
- Low-Density Residential and mixed commercial to the south
- Muscle Creek and Muswellbrook Golf Course to the north-east, and
- New England Highway, followed by mixed residential and commercial land usage to the south-west.

3.3 Historical

Review of historical aerial photographs indicates the site has been in use in a low-density residential setting since pre-1974. Other than removal of two small sheds, no significant indicators of uncontrolled demolition were observed to have taken place. A minor level of earthworks occurred within the south-eastern portion of the site in 2019.

3.4 Areas and Contaminants of Potential Concern

Table 3.1 below lists locations and contaminants of potential concern that have been identified by this assessment.

Table 3.1: Areas and Contaminants of Potential Concern

Area of Concern	Contaminants of Concern	Source	Risk	Area
Filled areas within 40m of the proposed residence	Heavy Metals, TRH, PAH, BTEXN	Coal Wash	Moderate	~250 m²
Footprint of former yard sheds	Heavy Metals, TRH, PAH, BTEXN	Yard equipment	Low	~30 m²

3.5 Potential Risks to Onsite Receptors

Heavy Metals, Hydrocarbons (TRH / PAH), and BTEXN have been identified as potential contaminants of concern within coal-wash material imported and spread across the south-eastern portion of the site. The constituents of the coal wash depend on the nature of the surrounding geology and mining processes used. This can be a mixture of any rock or soil strata present in the coal seam being mined.

This material has been largely stabilised with vegetation but will likely be disturbed upon commencement of construction of the proposed childcare development, and as such represents an exposure risk to on-site receptors (via direct dermal contact and / or inhalation of dust). Future occupants of the property, including children, may also encounter the coal-wash whilst interaction with landscaped areas or gardening.

3.6 Potential for Migration of Contaminants

Coal wash fill material has been placed within the south-eastern portion of the site. This locality has been largely stabilised with vegetation but will be disturbed upon commencement of construction of the proposed childcare centre. As such these localities may be temporarily vulnerable to the elements of wind, rain and erosion. As such, the risk of contamination migration to the north-east is considered low-moderate.

3.7 Recommendations

Based on the findings of this investigation, it is recommended that:

 The Areas of Concern outlined in Table 3.1 are investigated by way of a Detailed Site Investigation (DSI) to ascertain the suitability of imported coal-wash media to be retained on site. This investigation could be staged commencing with a reduced number of samples to first qualify and quantify the constituents of the coal wash. Subject to the outcome of the first stage, additional sampling and analysis may become necessary.

- 2. Any waste material from the site, including soil, be pre-classified in accordance with the NSW EPA Waste Classification Guidelines by a suitably qualified person prior to excavation or removal from site. If encountered, potentially hazardous materials must be handled by suitably licensed contractors and disposed at a licensed facility appropriate to their classification.
- 3. The property owners should commission a suitably licensed and experienced building inspector / hygienist or equivalent to inspect the existing residence on site prior to any alteration or demolition works. The subsequent demolition works follow the recommendations within that HAZMAT report and any requirements of Safework NSW. A **Clearance Certificate** prepared by a suitably qualified person must be provided clearly indicating the site has been cleared of potentially hazardous building materials.
- 4. If encountered, potentially hazardous materials must be handled by suitably licensed contractors per Safework NSW regulations and disposed at a licensed facility appropriate to their classification.
- 5. Should any unidentified or potentially contaminated material be excavated whilst on site it is recommended that the advice of a trained and experienced contaminated lands consultant be sought. The site foreman should be advised immediately for appropriate action.

4 CONCLUSIONS

Broadcrest Consulting Pty. Ltd. was engaged by Curious Minds Early Learning Centre PTY LTD to conduct a Preliminary Site Investigation at 118 Maitland Street, Muswellbrook (hereafter referred to as the site). The assessment will accompany a Development Application for the proposed demolition of an existing residence and construction of a new childcare centre.

A site inspection was undertaken on 23 January 2024 by Broadcrest Pty Ltd consultant Cheyne Hudson (CEnvP). At the time of inspection, the site was occupied by a single-story residential structure, driveway and carport within a low-density residential setting. The dwelling has been constructed on bearers and joists connected to brick piers. The remainder of the site consists of lawn and scattered trees at the rear. There were no obvious visual indicators of site contamination.

Four (4) boreholes were drilled across the site – two (2) within the south-eastern portion of the site, one (1) within the central portion of the site and one (1) within the north-eastern portion of the site (Figure 2.7). The two (2) boreholes within the south-eastern portion of the site revealed shallow fill materials consisting primarily of coal-wash.

- The site is not listed on any NSW EPA Registers
- No significant potential risks to on-site receptors have been identified.
- No significant potential for migration of contamination has been identified.

Heavy Metals, Hydrocarbons (TRH / PAH), and BTEXN have been identified as potential contaminants of concern within coal-wash material imported and spread across the south-eastern site extent. The constituents of the coal wash depend on the nature of the surrounding geology and mining processes used. This can be a mixture of any rock or soil strata present in the coal seam being mined.

This material has been largely stabilised with vegetation but will likely be disturbed upon commencement of construction of the proposed childcare development, and as such represents an exposure risk to on-site receptors (via direct dermal contact and / or inhalation of dust). Future occupants of the property, including children, may also encounter the coal-wash whilst interaction with landscaped areas or gardening.

Based on the findings of this investigation, it is recommended that:

- The Areas of Concern outlined in Table 3.1 are investigated by way of a Detailed Site Investigation (DSI) to ascertain the suitability of imported coal-wash media to be retained on site. This investigation could be staged commencing with a reduced number of samples to first qualify and quantify the constituents of the coal wash. Subject to the outcome of the first stage, additional sampling and analysis may become necessary.
- 2. Any waste material from the site, including soil, be pre-classified in accordance with the NSW EPA Waste Classification Guidelines by a suitably qualified person prior to

- excavation or removal from site. If encountered, potentially hazardous materials must be handled by suitably licensed contractors and disposed at a licensed facility appropriate to their classification.
- 3. The property owners should commission a suitably licensed and experienced building inspector / hygienist or equivalent to inspect the existing residence on site prior to any alteration or demolition works. The subsequent demolition works follow the recommendations within that HAZMAT report and any requirements of Safework NSW. A **Clearance Certificate** prepared by a suitably qualified person must be provided clearly indicating the site has been cleared of potentially hazardous building materials.
- 4. If encountered, potentially hazardous materials must be handled by suitably licensed contractors per Safework NSW regulations and disposed at a licensed facility appropriate to their classification.
- 5. Should any unidentified or potentially contaminated material be excavated whilst on site it is recommended that the advice of a trained and experienced contaminated lands consultant be sought. The site foreman should be advised immediately for appropriate action.

5 DISCLAIMER

This report has been prepared for use by the client who has commissioned the works in accordance with the project brief only and has been based on information provided by the client. The advice herein relates only to this project and all results, and conclusions made should be reviewed by a competent and experienced person with experience in environmental investigations, before being used for any other purpose. Broadcrest Consulting Pty Ltd accepts no liability for use or interpretation by any person or body outside the consent authority. This report should not be reproduced or amended in any away without prior approval by the client or Broadcrest Consulting Pty Ltd and should not be relied upon by any other party, who should make their own independent enquiries.

The extent of sampling of soils and subsequent analysis has been necessarily limited and has been targeted towards areas where contamination is most likely based on the knowledge of the Site history and visual observation. This approach maximises the probability of identifying contaminants, however, it may not identify contamination which occurs in unexpected locations or from unexpected sources.

Further, soils rock and aquifer conditions are often variable, resulting in non-homogenous contaminant distributions across a site. Contaminant concentrations have been identified at chosen sample locations, however, conditions between samples locations can only be inferred based on the estimated geological and hydrogeological conditions and the nature and extent of identified contamination.

Boundaries between zones of variable contamination are often indistinct and have been interpreted based on available information and the application of professional judgement. The accuracy with which the subsurface conditions have been characterised depends on the frequency and methods of sampling and the uniformity of subsurface conditions and is therefore limited by the scope of works undertaken.

This report does not provide a complete assessment of the environmental status of the site and it is limited to the scope defined herein. Should information become available regarding conditions at the site including previously unknown sources of contamination, Broadcrest Consulting Pty Ltd reserves the right to review the report in the context of the additional information.

Broadcrest Consulting Pty Ltd accepts no liability for the unlawful disposal of waste materials from any site. Broadcrest Consulting Pty Ltd does not accept any responsibility for the material tracking, loading, management, transport or disposal of waste from the site.

Broadcrest Consulting Pty Ltd professional opinions are based upon its professional judgement, experience, training and results from analytical data. In some cases, further testing and analysis may be required, thus producing different results and/or opinions. Broadcrest Consulting Pty Ltd has limited investigation to the scope agreed upon with its client.

Broadcrest Consulting Pty Ltd has used a degree of care and skill ordinarily exercised in similar investigations by reputable member of the Environmental Industry within Australia. No other warranty, expressed or implied, is made or intended.

6 GLOSSARY

Abbreviation	Term
ANZECC	Australia and New Zealand Environment Conservation Council
AS	Australian Standard
AS/NZS	Combined Australian Standard and New Zealand Standard
BOD	Biological oxygen demand
DA	Development Application
DC	Development Consent
DEC	Department of Environment and Conservation (NSW)
EC	Electrical Conductivity
EIS	Environmental Impact Statement
EMP	Environmental Management Plan
EP&A Act	NSW Environmental Planning and Assessment Act 1979
EPA	Environment Protection Authority
ESA	Environmental Site Assessment
ESD	Ecologically Sustainable Development
ISO	International Organisation for Standardization
LEP	Local Environmental Plan
LGA	Local Government Area
Leachate:	Any liquid that, in the course of passing through matter, extracts soluble
	or suspended solids, or any other component of the material through
	which it has passed
mg/L	Milligrams per litre
NTU	Nominal Turbidity Units
PAH	Polyaromatic Hydrocarbons
RAP	Remediation Action Plan
REP	Regional Environmental Plan
RPD	Relative Percent Difference
SEPP	State Environmental Planning Policy
USEPA	United States Environment Protection Agency
μg/L	Micrograms per litre





ARTIST'S IMPRESSION ONLY

118 MAITLAND STREET **MUSWELLBROOK 2333**

CHILDCARE CENTRE

DEVELOPMENT APPLICATION

	ARCHITECTURAL DRAWING LIST - DA	A	
Sheet Number	Sheet Name	Current Revision	Curre Revision
DA00.00	COVER PAGE	Α	29.02.2
DA02.01	SITE PLAN / DEMOLITION	Α	29.02.2
DA03.01	BASEMENT FLOOR PLAN	Α	29.02.2
DA03.02	GROUND FLOOR PLAN	А	29.02.2
DA03.03	FIRST FLOOR PLAN	А	29.02.2
DA03.04	AREA CALCULATIONS	Α	29.02.2
DA04.01	EXTERNAL ELEVATIONS	Α	29.02.2
DA05.01	SECTIONS & EXTERNAL FINISHES	Α	29.02.2
DA06.02	SHADOW DIAGRAMS & VIEW FROM SUN	A	29.02.2
DA06.03	VIEW FROM THE SUN	А	29.02.2
DA06.04	OUTDOOR SOLAR ACCESS	А	29.02.2

A 29.02.2024 FOR CO-ORDINATION
ISSUE DATE DESCR DESCRIPTION

ASSOCIATED CONSULTANTS PLANNING AVENUE PLANNING TRAFFIC STANBURY TRAFFIC ACOUSTICS DAY DESIGN LANDSCAPE GREENSCAPE DESIGN **GEOTECH & PSI** BROADCREST CONSULTING PTY LTD CIVIL AND FLOOD

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PROJECT

CHILDCARE CENTRE

PROJECT ADDRESS

118 MAITLAND STREET MUSWELLBROOK 2333


SHEET NAME

COVER PAGE


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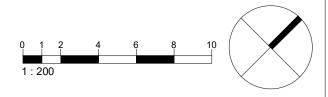
MUSWELLBROOK TA/MS1 MS/SS 29.02.2024



1 DEMOLITION PLAN
1:200

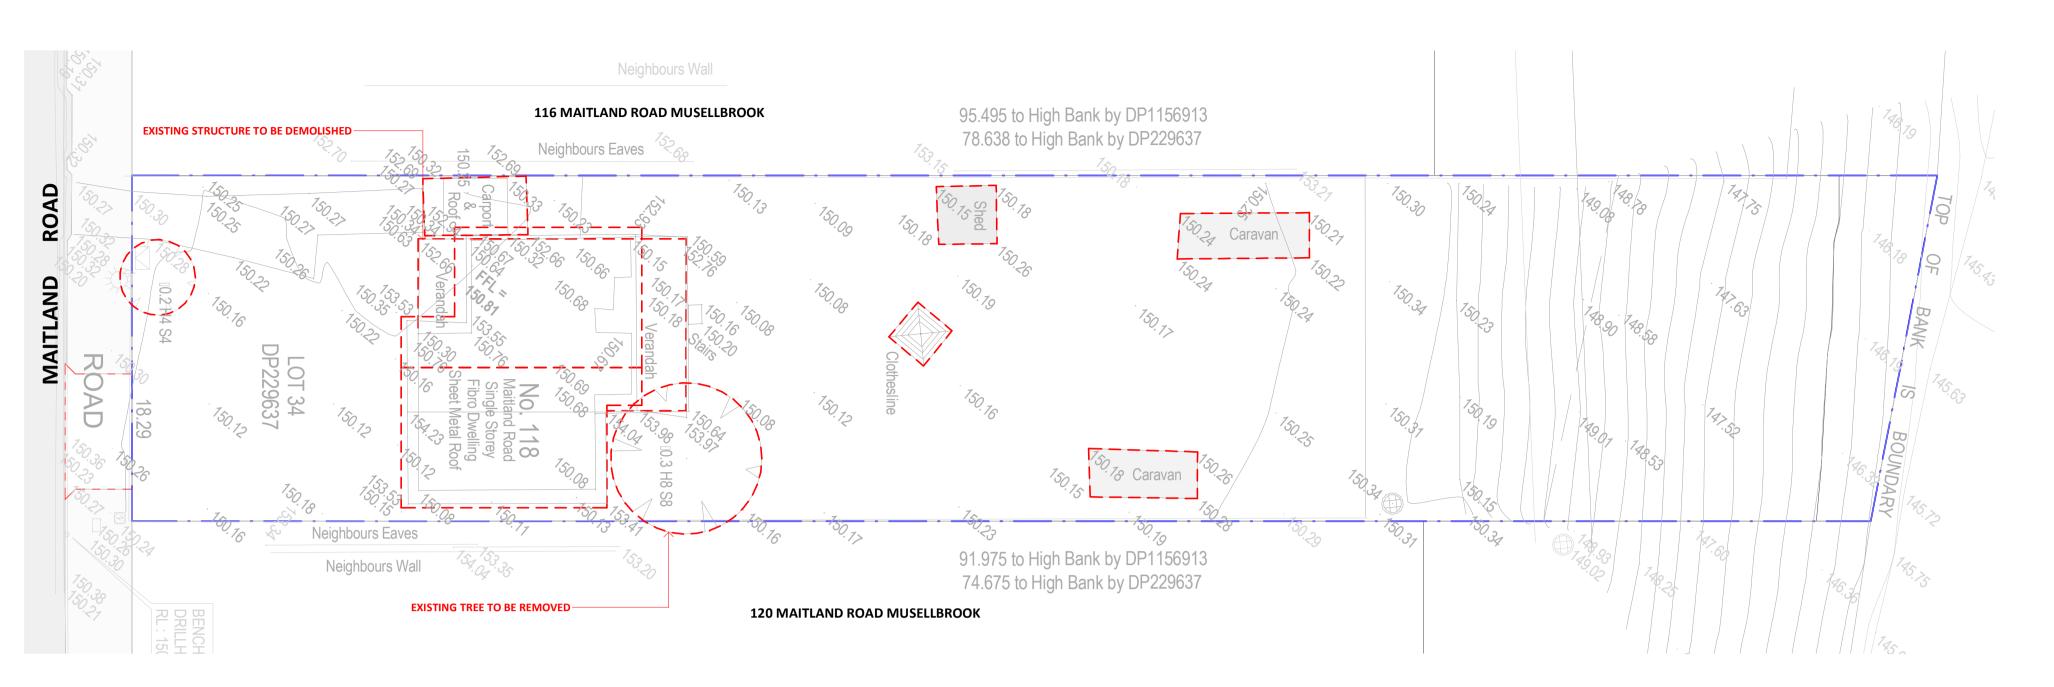

2 SITE PLAN 1:200

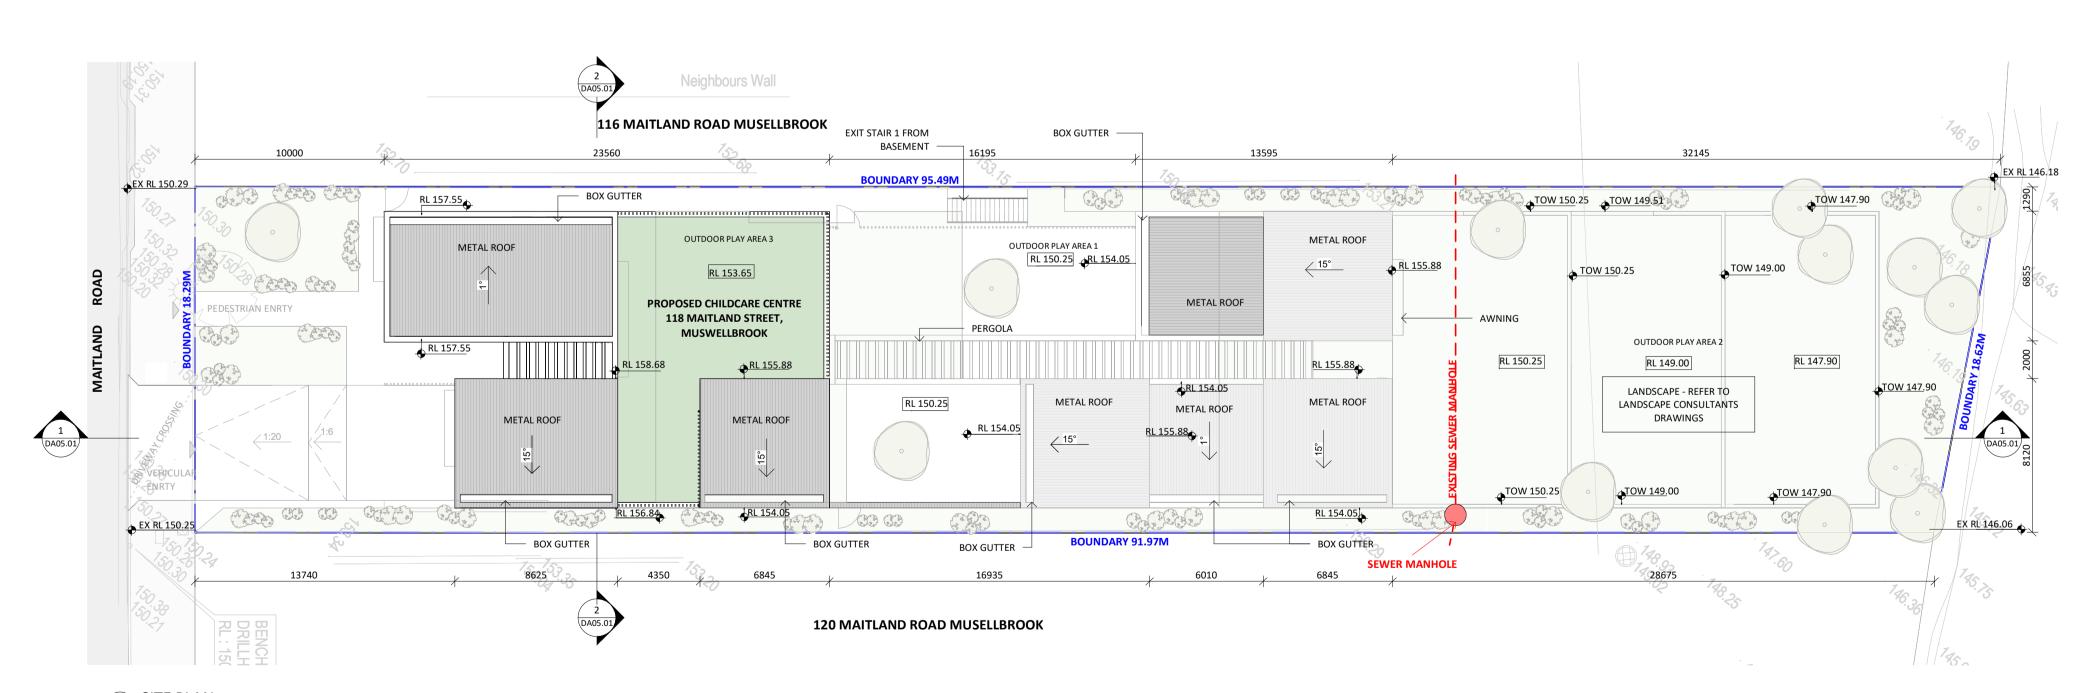

ABBREVIATIONS

ENG. - ENGINEER - EXISTING SLAB LEVEL

- EXTERIOR EXT - FINISH FLOOR LEVEL

- FINISH SURFACE LEVEL - GROUND LINE

- GLAZING EX.GL - EXISTING GROUND LINE REQ. - REQUIREMENTS

- PROPOSED LEVEL - EXISTING LEVEL XX.XX - SPOT LEVEL (PLAN) ▼ XX.XX - SPOT LEVEL (ELEVATION)

LANDSCAPE LEGEND

EXISTING TREE / TREE TO BE RETAINED

TREE TO BE REMOVED

NEW TREE

LANDSCAPING / BUFFER

TURF/ ARTIFICIAL TURF

EXTERNAL FLOOR FINISH

LINE OF STRUCTURAL ROOT ZONE (SRZ) — - - — LINE OF TREE EXCLUSION ZONE (TEZ) __ _ LINE OF TREE PROTECTION ZONE (TPZ) NOTE: REFER TO ARBORIST REPORT FOR FURTHER DETAILS

GENERAL NOTES

- ALL EXISTING BUILDING ELEMENTS TO BE CHECKED ON SITE U.N.O
- DEMOLITION TO BE IN ACCORDANCE WITH AUSTRALIAN STANDARDS AND TO BE CARRIED OUT BY A LICENCED CONTRACTOR U. N.O
- REFER TO SW DRAWINGS FOR DRAINAGE
- REFER TO LANDSCAPE DRAWINGS FOR LANDSCAPE DESIGN.
- KITCHEN AREA TO BE ACCORDANCE WITH NSW AS4674, FOOD ACT 2003, FOOD REGULATION 2015 AND FOOD STANDARD CODES 3.2.2 AND

A 29.02.2024 FOR CO-ORDINATION
ISSUE DATE DESCR DESCRIPTION

ASSOCIATED CONSULTANTS

PLANNING AVENUE PLANNING

TRAFFIC STANBURY TRAFFIC ACOUSTICS DAY DESIGN LANDSCAPE GREENSCAPE DESIGN

GEOTECH & PSI BROADCREST CONSULTING PTY LTD CIVIL AND FLOOD ACOR

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PROJECT

CHILDCARE CENTRE

PROJECT ADDRESS

118 MAITLAND STREET MUSWELLBROOK 2333

SHEET NAME

SITE PLAN / DEMOLITION


ISSUED FOR DEVELOPMENT APPLICATION

23714 DA02.01

Α Scale A1 As indicated MUSWELLBROOK

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CHILDCARE CENTRE

PROJECT ADDRESS

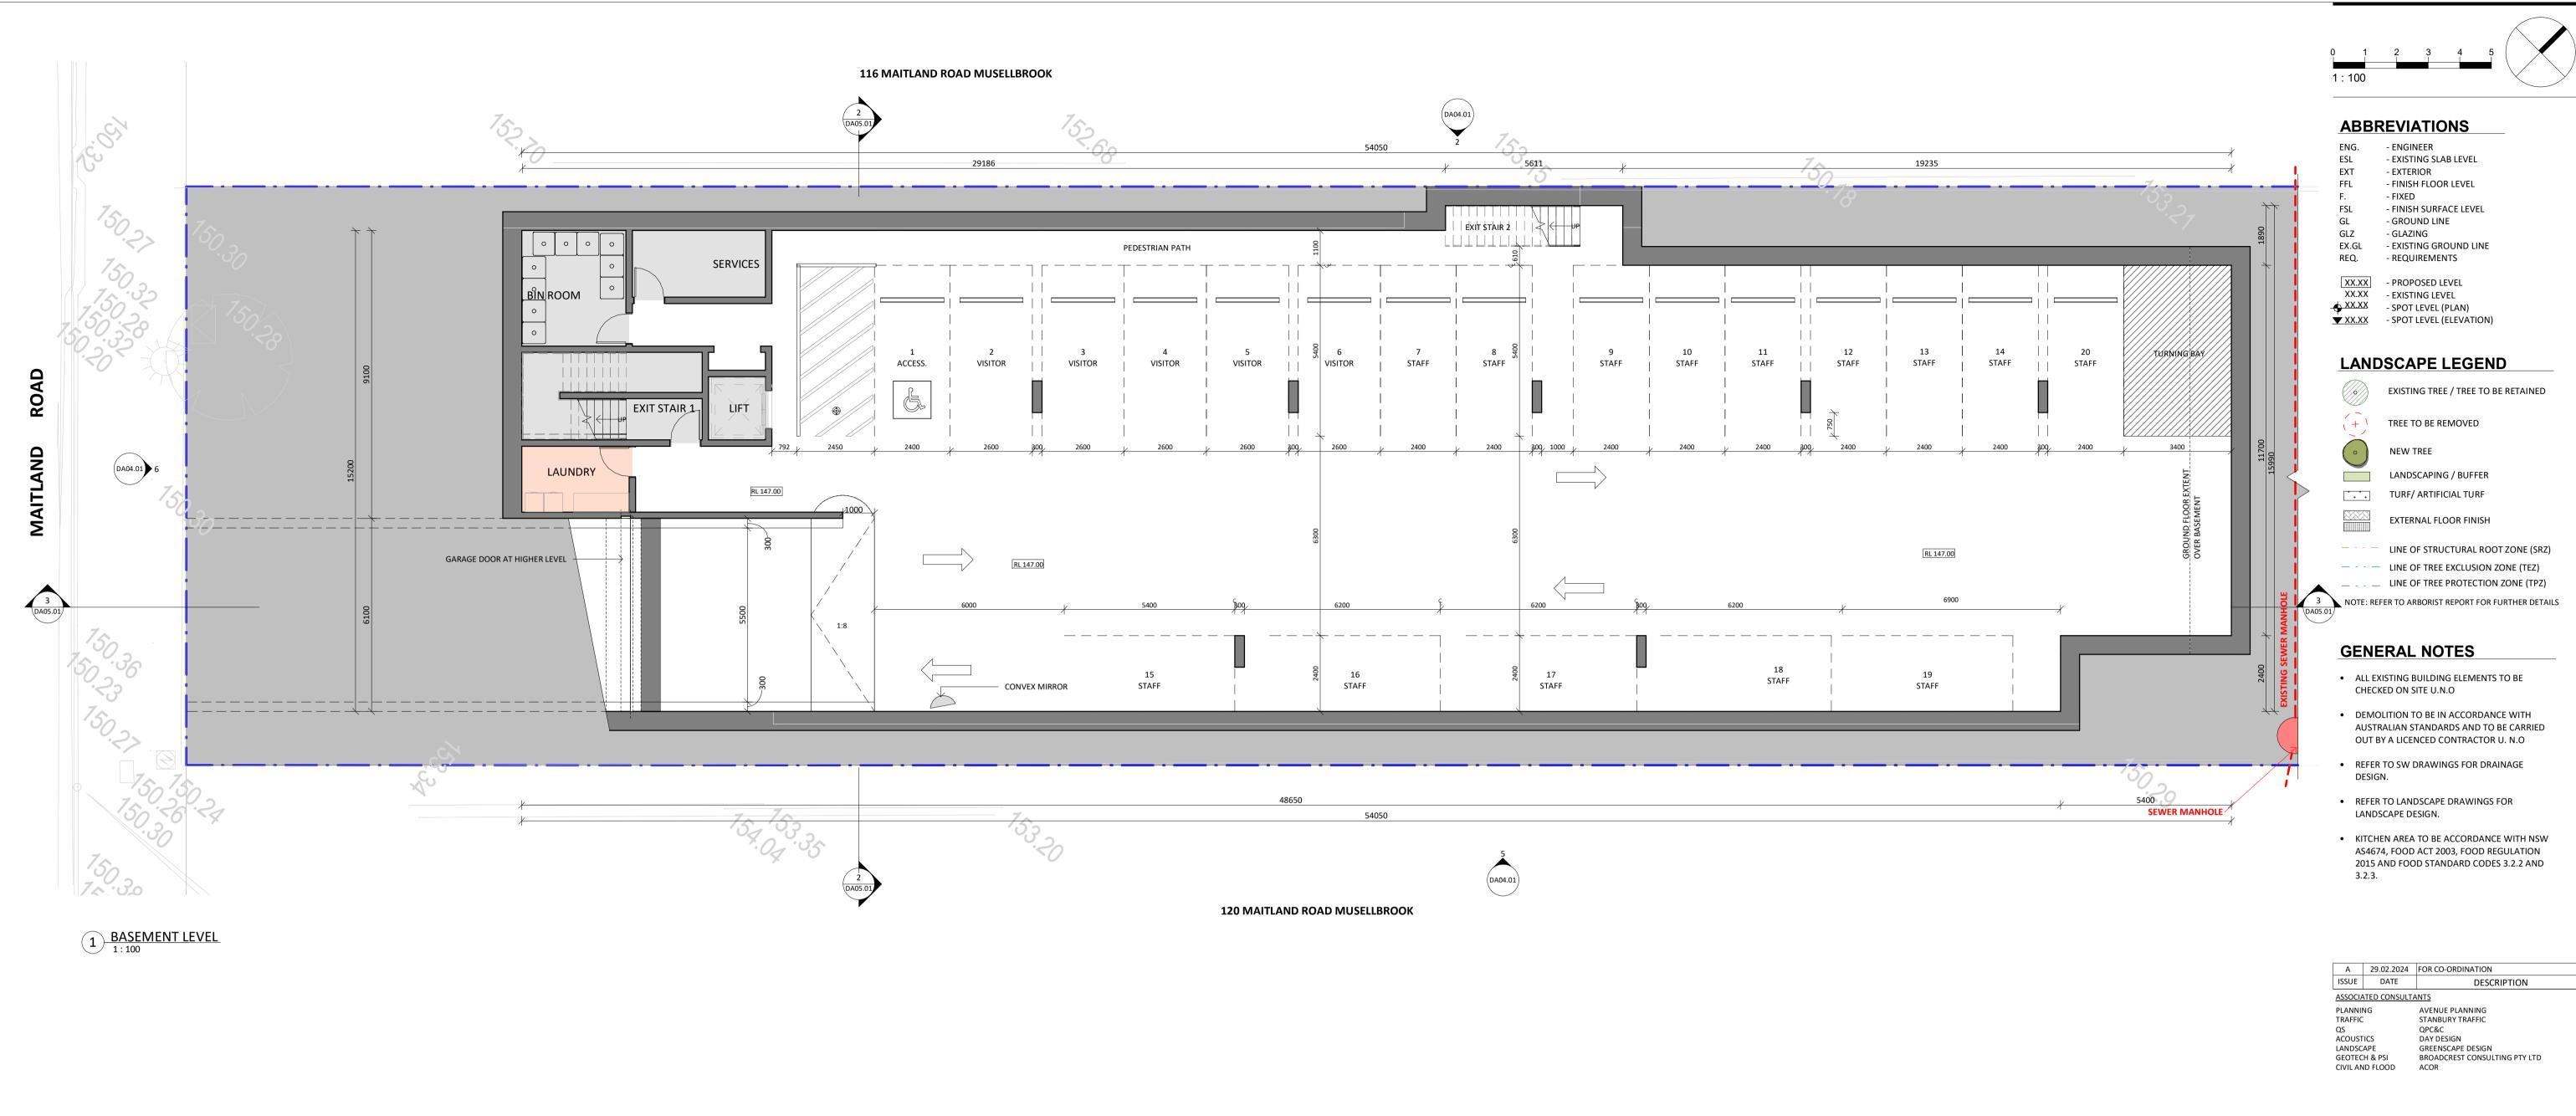118 MAITLAND STREET MUSWELLBROOK 2333

SHEET NAME

BASEMENT FLOOR PLAN


Project number Sheet No. Issue Phase 23714 DA03.01 A DA

Sheet Size Scale L.G.A.

As indicated MUSWELLBROOK

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Drawn By Checked By Date
TA/MS1 MS/SS 29.02.2024

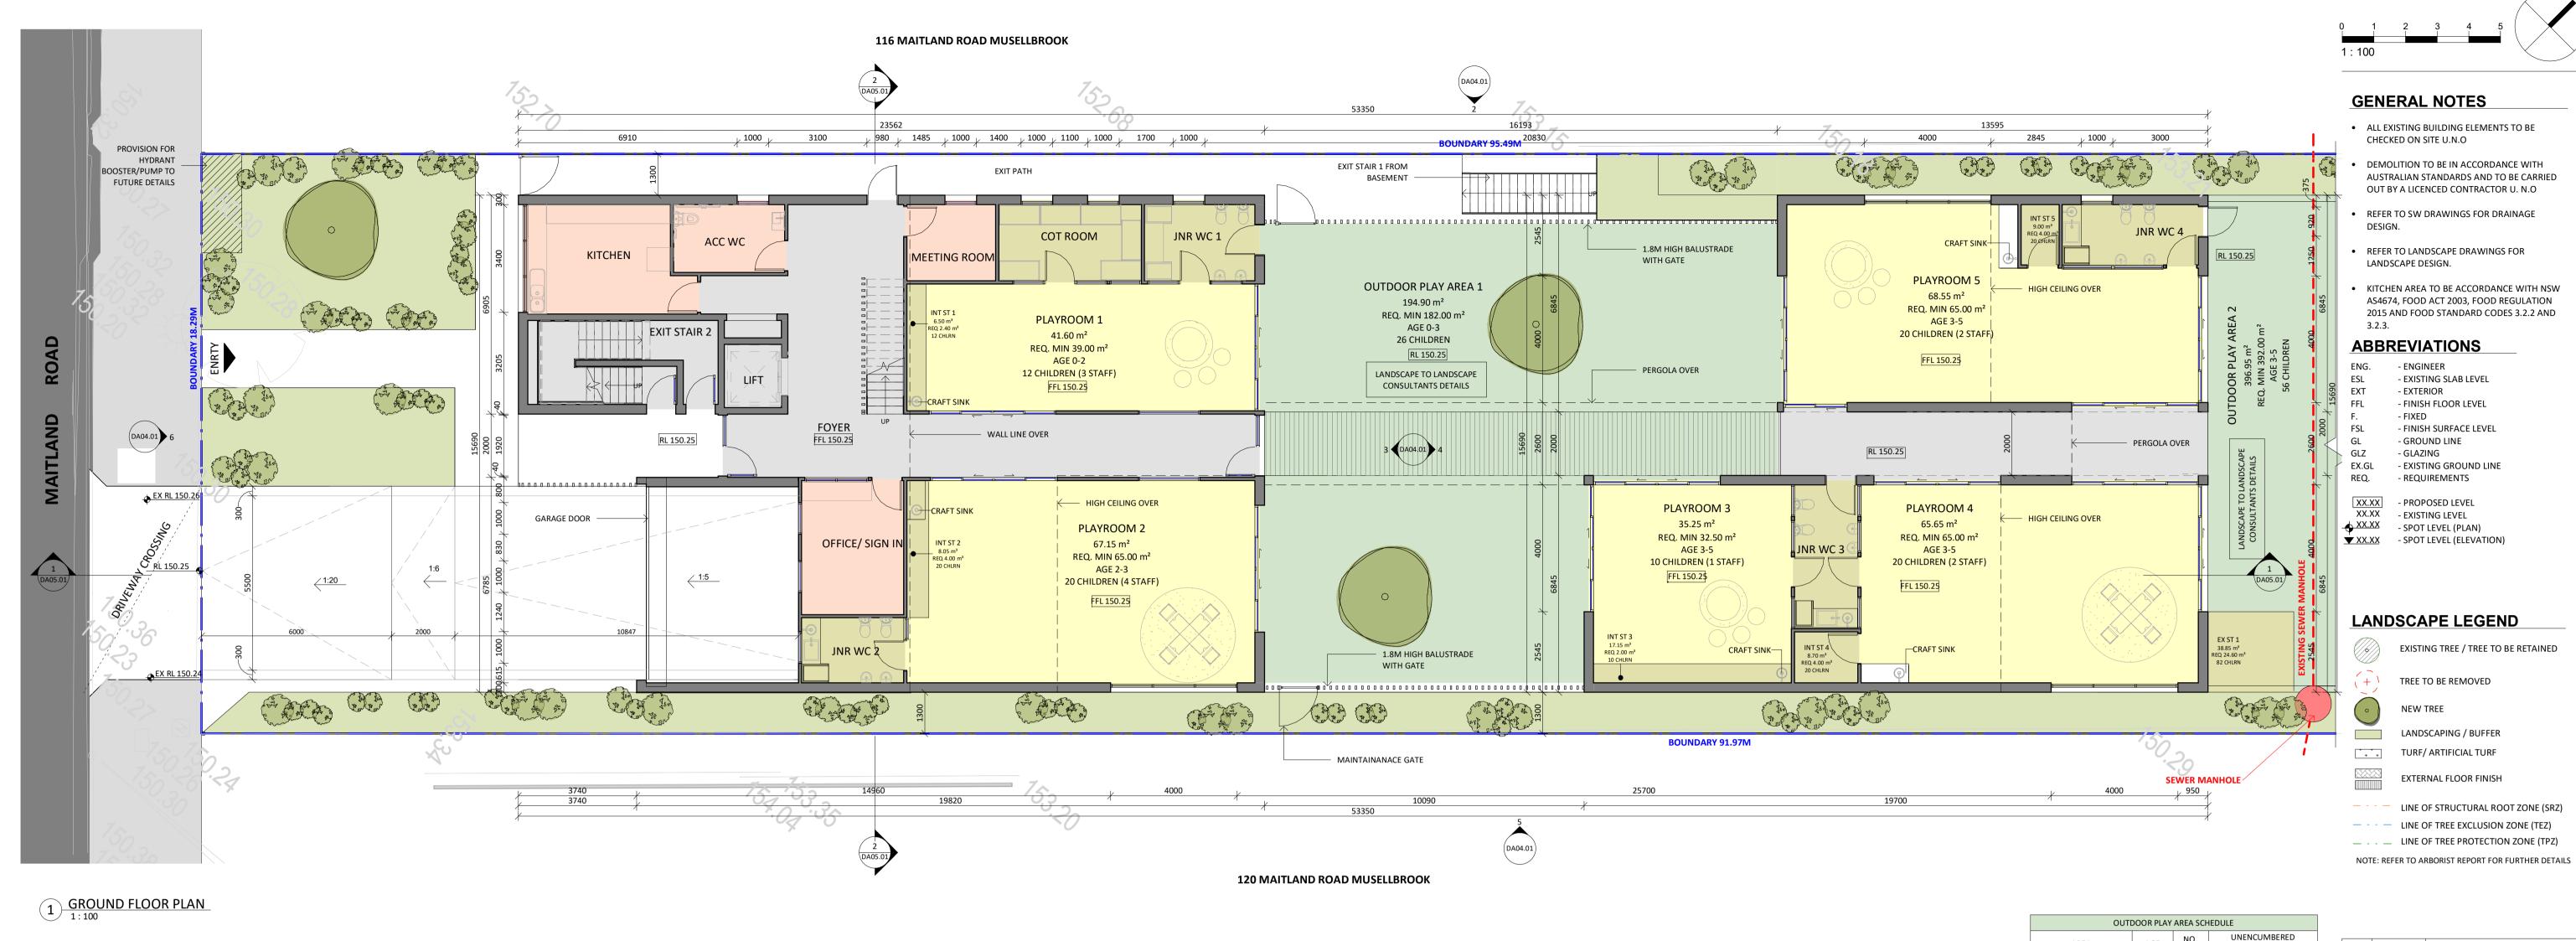

DA - FENCE LEGEND

— 1.2M HT BALUSTRADE

1.2M HT ACOUSTIC BARRIER

EG. 1.2M HT LAPPED & CAPPED BOUNDARY FENCE

8.8M HT LAPPED & CAPPED BOUNDARY FENCE

ALL ACOUSTIC BARRIERS IN ACCORDANCE WITH ACOUSTIC REPORT.

REFER TO SHEET A05.01 FOR FENCE DETAILS.

NO. OUTDOOR PLAY AREA 1 | AGE 0-3 | 26 | 182 m² | 194.90 m² OUTDOOR PLAY AREA 2 | AGE 3-5 | 56 | 392 m² | 396.95 m²
 OUTDOOR PLAY AREA 3
 AGE 3-5
 10
 70 m²
 119.50 m²
 92 644 m² 711.35 m² EXTERNAL STORAGE SCHEDULE NO. CHLDRN REQ VOL 24.60 m³ 38.85 m³

INDOOR PLAYROOM SCHEDULE						
ROOM	AGE	NO.	NO.	UNENCL	JMBERED	
KOOW	AGL	CHLDRN	STAFF	REQ AREA	AREA	
PLAYROOM 1	AGE 0-2	12	3	39 m²	41.60 m²	
PLAYROOM 2	AGE 2-3	20	4	65 m²	67.15 m²	
PLAYROOM 3	AGE 3-5	10	1	32.5 m²	35.25 m²	
PLAYROOM 4	AGE 3-5	20	2	65 m²	65.65 m²	
PLAYROOM 5	AGE 3-5	20	2	65 m²	68.55 m²	
PLAYROOM 6	AGE 3-5	10	1	32.5 m ²	37.15 m²	
TOTAL 92 13 299 m ² 315.40 m ²						

INTERNAL STORAGE SCHEDULE							
NAME	NO. CHLDRN	REQ VOL	VOL				
INT ST 1	12	2.40 m³	6.50 m³				
INT ST 2	20	4.00 m ³	8.05 m³				
INT ST 3	10	2.00 m ³	17.15 m³				
INT ST 4	20	4.00 m³	8.70 m ³				
INT ST 5	20	4.00 m ³	9.00 m³				
INT ST 6	10	2.00 m ³	7.05 m³				
TOTAL	92	18 40 m ³	56.45 m ³				

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ACOUSTICS DAY DESIGN GREENSCAPE DESIGN **GEOTECH & PSI** BROADCREST CONSULTING PTY LTD CIVIL AND FLOOD ACOR

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PROJECT

CHILDCARE CENTRE

PROJECT ADDRESS

118 MAITLAND STREET MUSWELLBROOK 2333

SHEET NAME

GROUND FLOOR PLAN

ISSUED FOR DEVELOPMENT APPLICATION 23714 DA03.02 A DA

Scale L.G.A. A1 As indicated MUSWELLBROOK TA/MS1 MS/SS 29.02.2024

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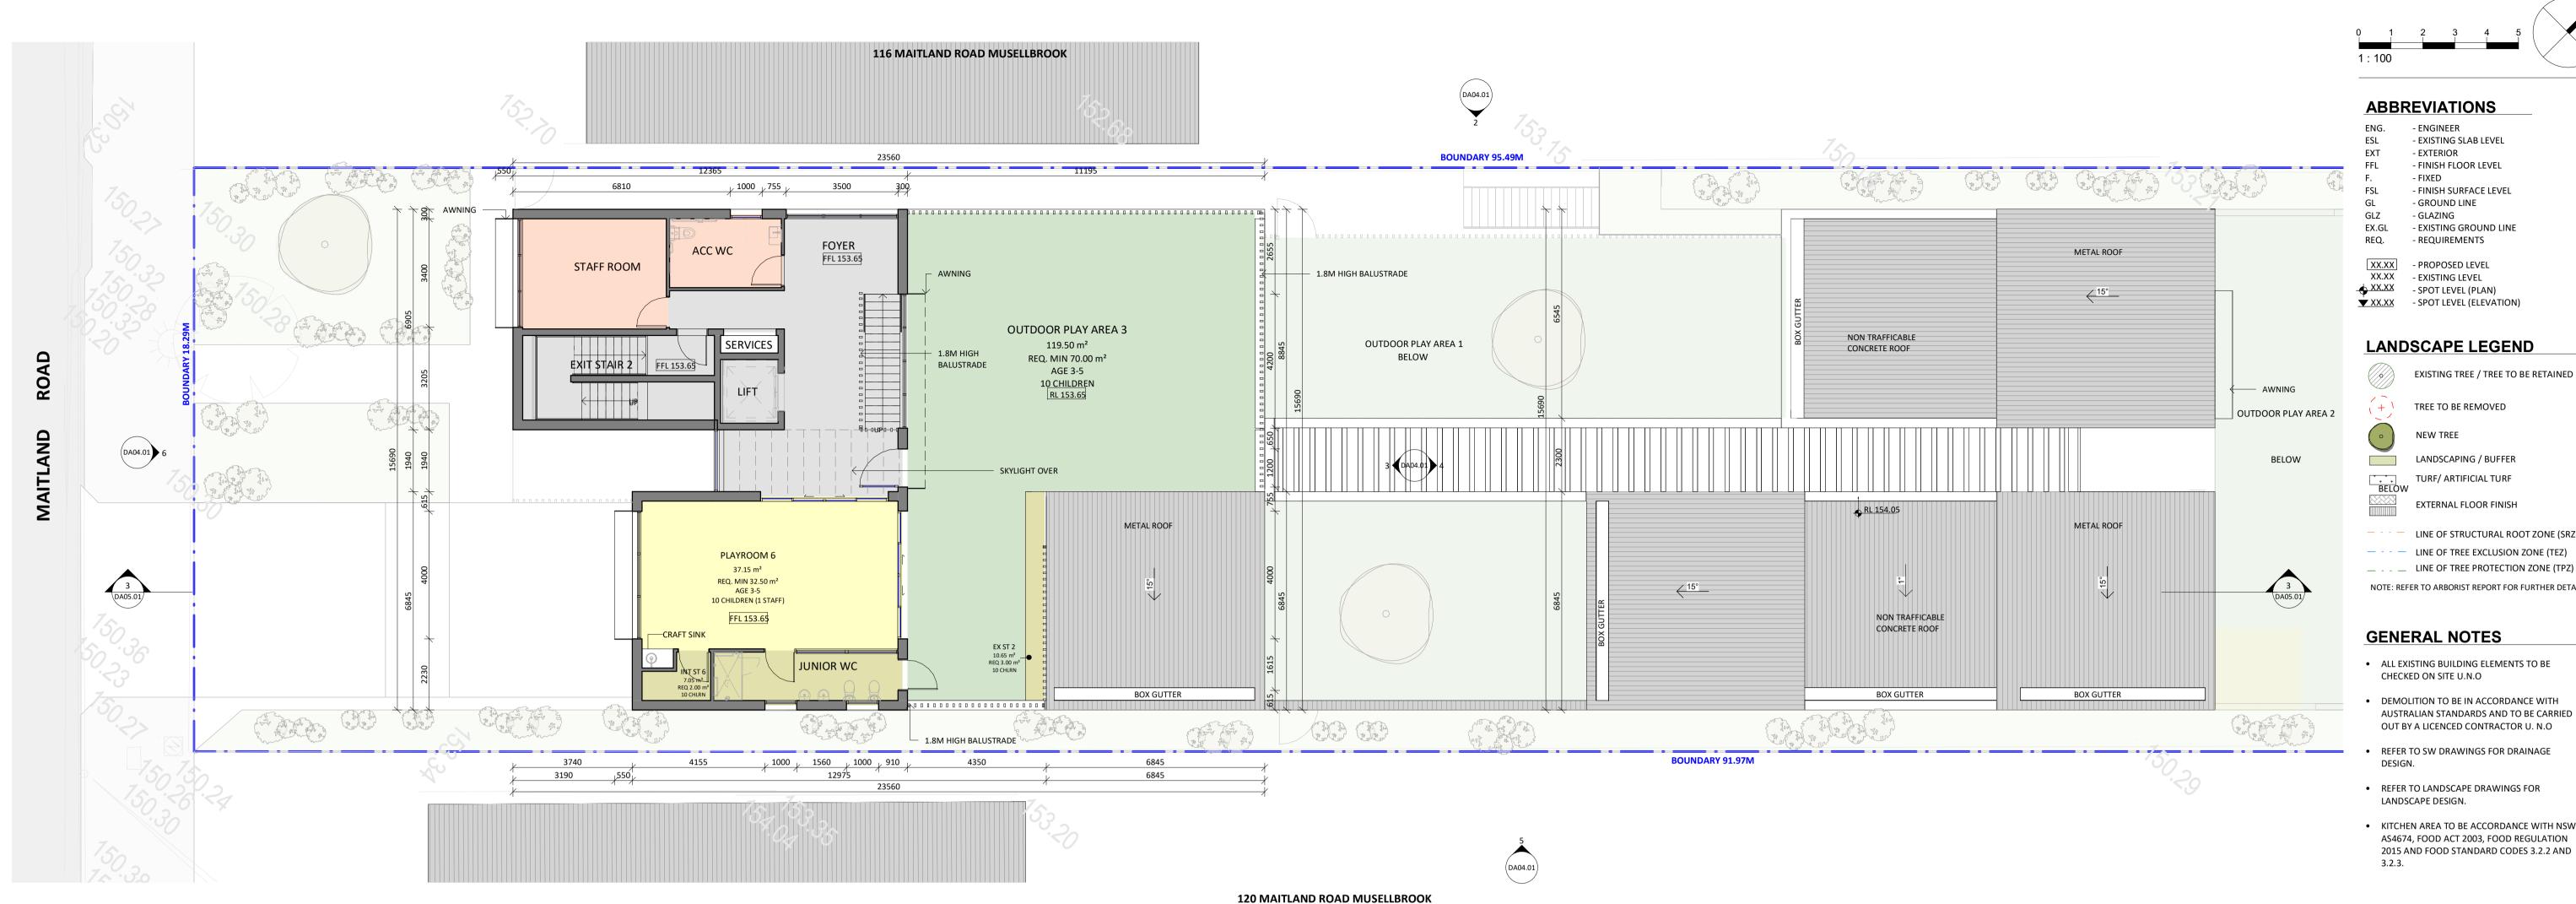
 3.00 m^3 10.65 m³ 27.60 m³ 49.50 m³

PLATROUIVI Z	AGE 2-3	20	4	05 111		67.15
PLAYROOM 3	AGE 3-5	10	1	32.5 r	n²	35.25
PLAYROOM 4	AGE 3-5	20	2	65 m	2	65.65
PLAYROOM 5	AGE 3-5	20	2	65 m	2	68.55
PLAYROOM 6	AGE 3-5	10	1	32.5 r	n²	37.15
TOTAL		92	13	299 n	1 ²	315.40
	INTERN	AL STORA	GE SCH	EDULE		
NAME	NO. CHLDR	N	REQ V	OL		VOL
INT ST 1	12		2.40 m ³			6.50 m³
INT ST 2	20		4.00 m³			8.05 m³
INT ST 3	10		2.00 m ³			17.15 m ³

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ARCHITECT







OUTDOOR PLAY AREA SCHEDULE						
AREA		AGE	AGE NO. UN		ENCUMBERED	
ANEA		AGE	CHLDRN	REQ AREA	AREA	
OUTDOOR PLAY	AREA 1	AGE 0-3	26	182 m²	194.90 m²	
OUTDOOR PLAY	AREA 2	AGE 3-5	56	392 m²	396.95 m²	
OUTDOOR PLAY AREA 3		AGE 3-5	10	70 m²	119.50 m²	
TOTAL			92	644 m²	711.35 m²	
	EXTERNAL STORAGE SCHEDULE					
NAME NO. CHLDRN		LDRN	REQ V	OL	VOL	
EX ST 1	82		24.60	m³	38.85 m³	
EX ST 2 10)	3.00 r	n³	10.65 m³	

INDOOR PLAYROOM SCHEDULE							
ROOM	AGE	NO.	NO.	UNENCL	JMBERED		
ROOM	AGE	CHLDRN	STAFF	REQ AREA	AREA		
PLAYROOM 1	AGE 0-2	12	3	39 m²	41.60 m²		
PLAYROOM 2	AGE 2-3	20	4	65 m²	67.15 m²		
PLAYROOM 3	AGE 3-5	10	1	32.5 m ²	35.25 m²		
PLAYROOM 4	AGE 3-5	20	2	65 m²	65.65 m²		
PLAYROOM 5	AGE 3-5	20	2	65 m²	68.55 m²		
PLAYROOM 6	AGE 3-5	10	1	32.5 m²	37.15 m²		
TOTAL	TOTAL 92 13 299 m ² 315.40 m ²						

INTERNAL STORAGE SCHEDULE				
NAME	NO. CHLDRN	REQ VOL	VOL	
NT ST 1	12	2.40 m³	6.50 m³	
NT ST 2	20	4.00 m ³	8.05 m ³	
NT ST 3	10	2.00 m ³	17.15 m³	
NT ST 4	20	4.00 m ³	8.70 m ³	
NT ST 5	20	4.00 m ³	9.00 m³	
NT ST 6	10	2.00 m ³	7.05 m ³	
ΓΩΤΛΙ	92	19.40 m ³	56.45 m ³	



ABBREVIATIONS - ENGINEER

- EXISTING SLAB LEVEL - EXTERIOR

- FINISH FLOOR LEVEL - FIXED - FINISH SURFACE LEVEL

- GROUND LINE - GLAZING - EXISTING GROUND LINE - REQUIREMENTS

- PROPOSED LEVEL - EXISTING LEVEL - SPOT LEVEL (PLAN) ▼ XX.XX - SPOT LEVEL (ELEVATION)

LANDSCAPE LEGEND

EXISTING TREE / TREE TO BE RETAINED

TREE TO BE REMOVED

NEW TREE LANDSCAPING / BUFFER

TURF/ ARTIFICIAL TURF EXTERNAL FLOOR FINISH

LINE OF STRUCTURAL ROOT ZONE (SRZ)

__ _ LINE OF TREE PROTECTION ZONE (TPZ) NOTE: REFER TO ARBORIST REPORT FOR FURTHER DETAILS

GENERAL NOTES

 ALL EXISTING BUILDING ELEMENTS TO BE CHECKED ON SITE U.N.O

> DEMOLITION TO BE IN ACCORDANCE WITH AUSTRALIAN STANDARDS AND TO BE CARRIED OUT BY A LICENCED CONTRACTOR U. N.O

REFER TO SW DRAWINGS FOR DRAINAGE

 REFER TO LANDSCAPE DRAWINGS FOR LANDSCAPE DESIGN.

 KITCHEN AREA TO BE ACCORDANCE WITH NSW AS4674, FOOD ACT 2003, FOOD REGULATION 2015 AND FOOD STANDARD CODES 3.2.2 AND

A 29.02.2024 FOR CO-ORDINATION ISSUE DATE DESCRIPTION

ASSOCIATED CONSULTANTS PLANNING AVENUE PLANNING

TRAFFIC STANBURY TRAFFIC QPC&C ACOUSTICS DAY DESIGN LANDSCAPE GREENSCAPE DESIGN

GEOTECH & PSI BROADCREST CONSULTING PTY LTD CIVIL AND FLOOD ACOR

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Architect Sherif Saad. Registration No. 7867 PROJECT

CHILDCARE CENTRE

PROJECT ADDRESS

118 MAITLAND STREET MUSWELLBROOK 2333

SHEET NAME

FIRST FLOOR PLAN

ISSUED FOR DEVELOPMENT APPLICATION 23714 DA03.03 A DA

Scale L.G.A. A1 As indicated MUSWELLBROOK

29.02.2024

TA/MS1 MS/SS

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L.G.A. Scale 1:200 MUSWELLBROOK TA/MS1 MS/SS 29.02.2024

D FOR DEVELOPMENT APPLICATIO				
t number	Sheet No.	Issue	Ph	
71/1	DAU3U4	Δ	Г	

AREA CALCULATIONS

ISSUED FOR D	EVELOPME	NT APPLICA	ATIC
Project number	Sheet No.	Issue	Pl

A 29.02.2024 FOR CO-ORDINATION
ISSUE DATE DESCR

AVENUE PLANNING STANBURY TRAFFIC

GREENSCAPE DESIGN

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CHILDCARE CENTRE

118 MAITLAND STREET MUSWELLBROOK 2333

BROADCREST CONSULTING PTY LTD

QPC&C

ACOR

DAY DESIGN

ASSOCIATED CONSULTANTS

PLANNING TRAFFIC

ACOUSTICS

LANDSCAPE

NOTES

CLIENT

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PROJECT

PROJECT ADDRESS

SHEET NAME

507/50 Holt St, Surry Hills NSW 2010

GEOTECH & PSI

CIVIL AND FLOOD

DESCRIPTION

DCP - FSR (SITE AREA 1714.42)

PROPOSED - FSR

253.60 m² GROUND FLOOR LEVEL 0.147926 81.90 m² GROUND FLOOR LEVEL 0.047772 119.30 m² GROUND FLOOR LEVEL 0.069575 109.60 m² FIRST FLOOR LEVEL 0.063931

PERMITTED AREA

571.50 m²

ISSUED FOR D	EVELOPME	NT APPLICA	NOITA
Project number	Sheet No.	Issue	Phase

1330ED FOR DEVELOPINIENT APPLICATION			
Project number	Sheet No.	Issue	Phase
23714	DA03.04	Α	DA

Project number	Sheet No.	Issue	Phase
23714	DA03.04	Α	DA

3 PRIMARY BUILDING - REAR ELEVATION 1:200

PC-01 | CL-01

BK-01



ARTIST'S IMPRESSION

PC-01

CL-01 BK-01

1 EAST ELEVATION 1:200

UPPER RIDGE 158.660

FIRST FLOOR LEVEL 153.650


GROUND FLOOR LEVEL

BASEMENT LEVEL 147.000

156.350

BASEMENT OUTLINE ————

6 WEST ELEVATION 1:200

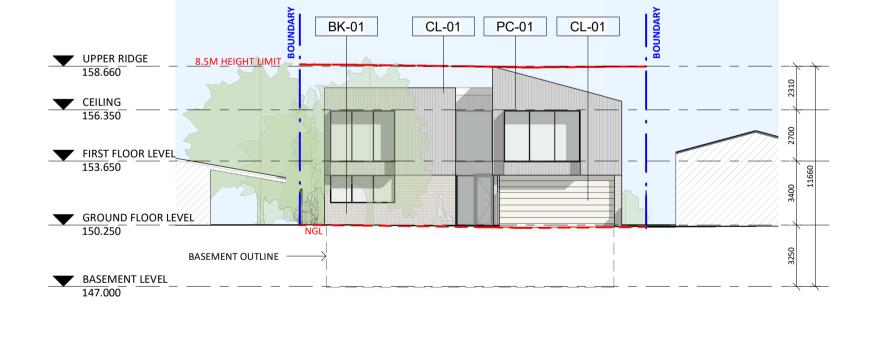

CL-01

CL-01 BK-01

5 SOUTH ELEVATION
1:200


UPPER RIDGE 158.660

FIRST FLOOR LEVEL 153.650


GROUND FLOOR LEVEL

BASEMENT LEVEL
147.000

CEILING 156.350

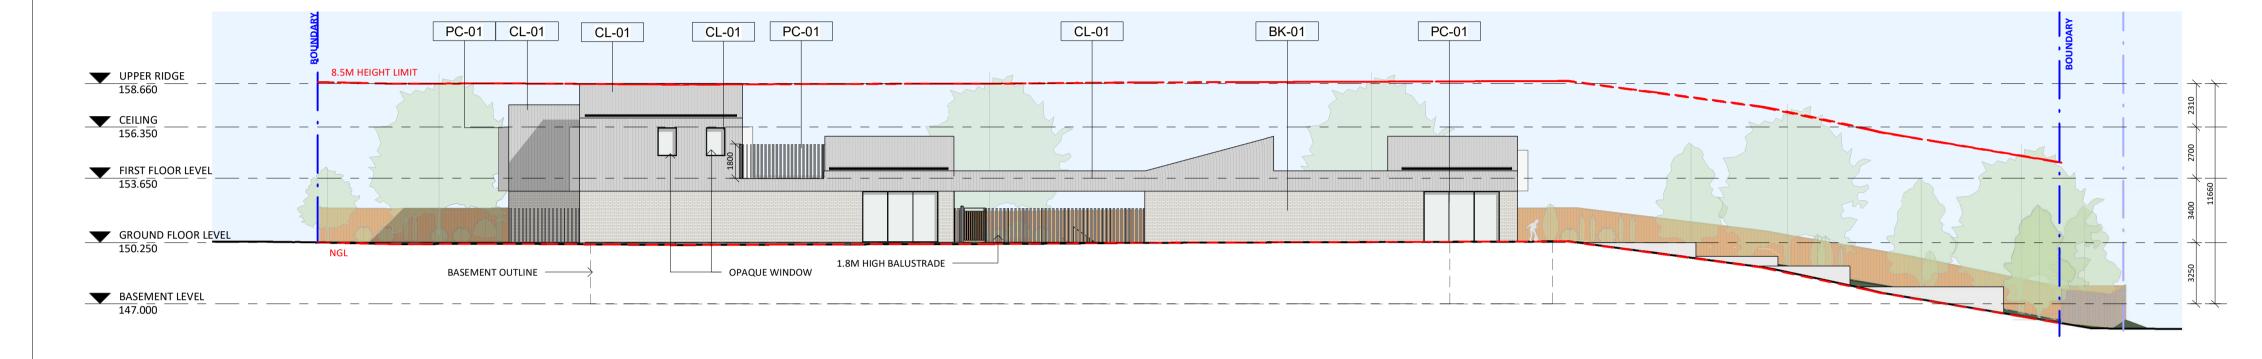

2 NORTH ELEVATION 1:200

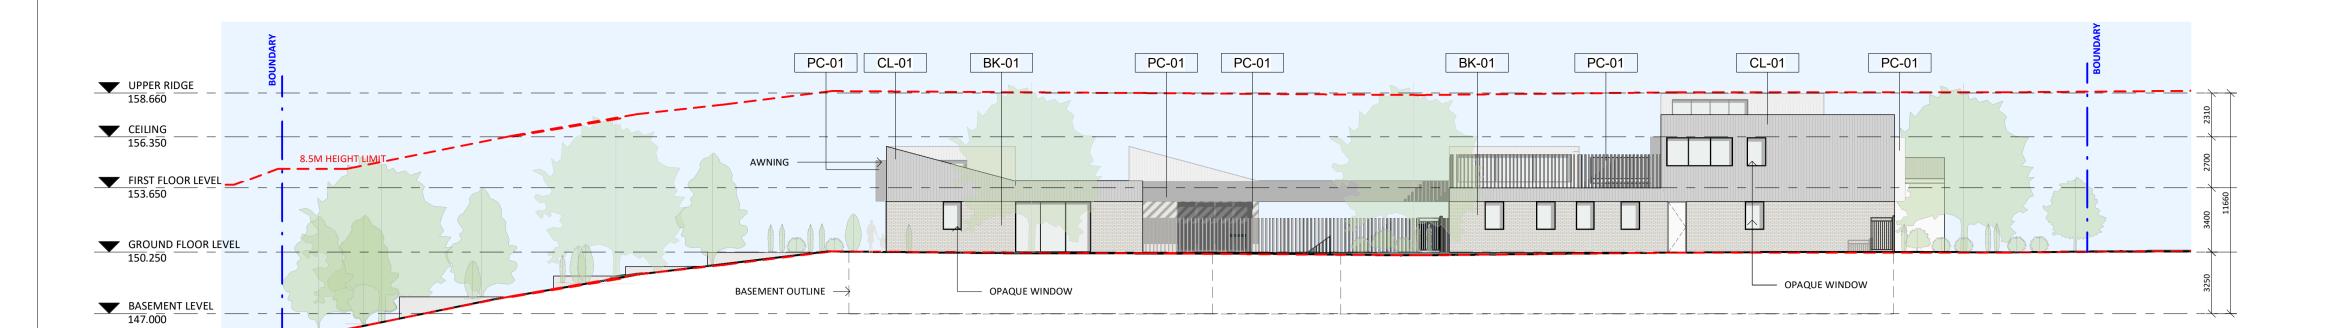

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TA/MS1 MS/SS 29.02.2024

AVENUE PLANNING

STANBURY TRAFFIC

GREENSCAPE DESIGN

BROADCREST CONSULTING PTY LTD

DAY DESIGN

ACOR

DESCRIPTION

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ASSOCIATED CONSULTANTS

PLANNING

TRAFFIC

ACOUSTICS

LANDSCAPE

GEOTECH & PSI

CIVIL AND FLOOD

EXTERNAL FINISHES

BRICK BAGGED

SIMILAR

COLOUR: NATURAL WHITE OR

COLORBOND LONG LINE COLOUR: SHALE GREY OR SIMILAR

ALUMINIUM WINDOW & DOOR

STANDING SEAM, ROOF

FRAMES,PERGOLA DURALLOY POWDERCOAT COLOUR: SHALE GREY OR SIMILAR

J. ANGELOVSKA AND L ABAUNADER

ARCHITECT

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CHILDCARE CENTRE

118 MAITLAND STREET

MUSWELLBROOK 2333

EXTERNAL ELEVATIONS

ISSUED FOR DEVELOPMENT APPLICATION

23714 DA04.01

As indicated MUSWELLBROOK

4 HEIGHT DIAGRAM

NOT FOR CONSTRUCTION

1:100 MUSWELLBROOK TA/MS1 MS/SS 29.02.2024

ISSUED FOR DEVELOPMENT APPLICATION 23714 DA05.01 A DA L.G.A.

SECTIONS & EXTERNAL FINISHES

A 29.02.2024 FOR CO-ORDINATION
ISSUE DATE DESCR

AVENUE PLANNING STANBURY TRAFFIC

GREENSCAPE DESIGN

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118 MAITLAND STREET MUSWELLBROOK 2333

BROADCREST CONSULTING PTY LTD

QPC&C

ACOR

DAY DESIGN

ASSOCIATED CONSULTANTS

PLANNING

ACOUSTICS

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PROJECT

PROJECT ADDRESS

SHEET NAME

|507/50 Holt St, Surry Hills NSW 2010

GEOTECH & PSI CIVIL AND FLOOD

TRAFFIC

DESCRIPTION

EXTERNAL FINISHES

BK-01

COLOUR: NATURAL WHITE OR

STANDING SEAM, ROOF COLORBOND LONG LINE COLOUR: SHALE GREY OR SIMILAR

ALUMINIUM WINDOW & DOOR

FRAMES,PERGOLA DURALLOY POWDERCOAT COLOUR: SHALE GREY OR SIMILAR

3 <u>SECTION A-A - CONT</u> 1:100

CEILING 156.350

FIRST FLOOR LEVEL
153.650

GROUND FLOOR LEVEL 150.250

BASEMENT LEVEL

1 SECTION A-A 1:100

2 <u>SECTION B-B</u> 1:100

— PERGOLA BEAM


____ 1.8M HIGH BALUSTRADE WITH GATE

PLAYROOM 3


- EXIT STAIR 1

RL 154.05

BASEMENT PARKING

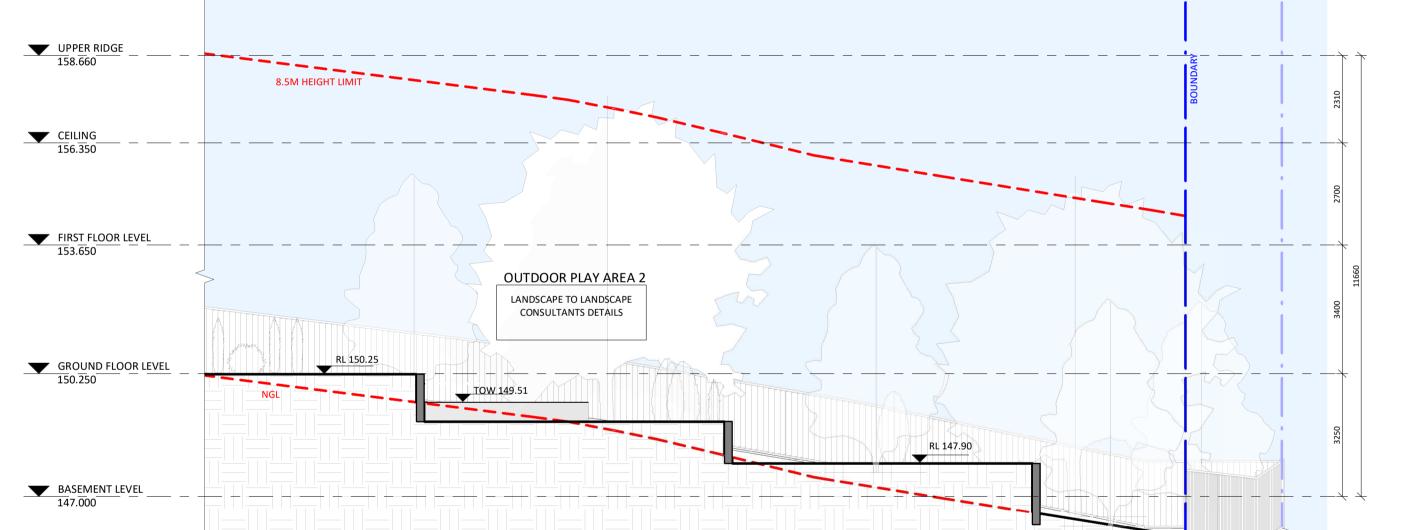

PLAYROOM 6

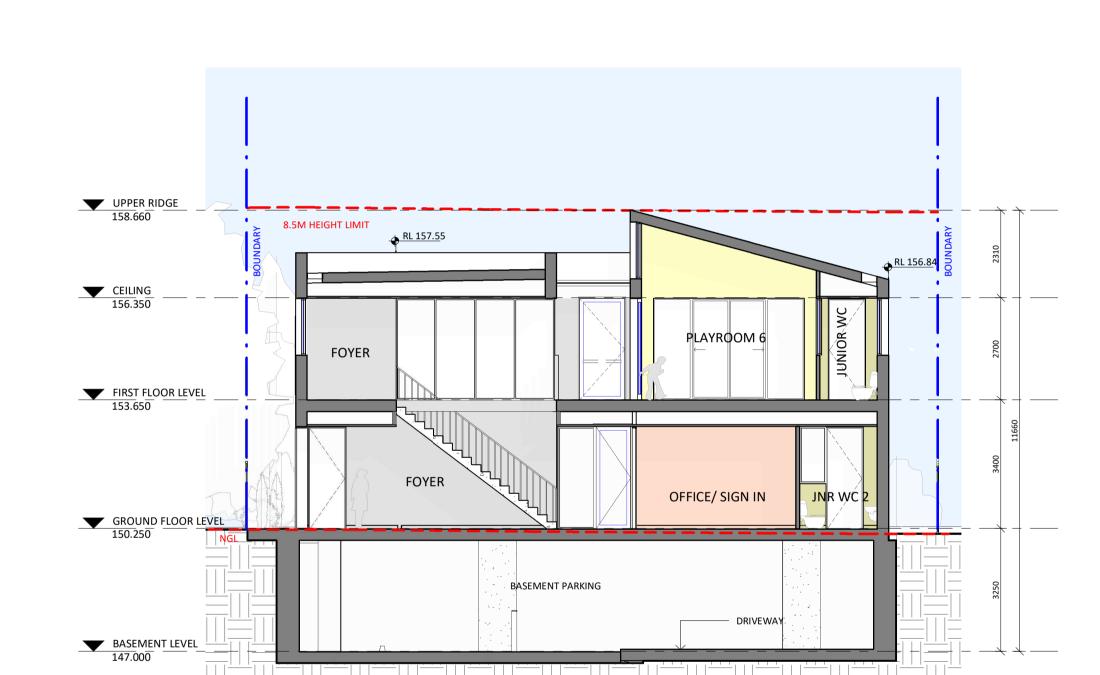

PLAYROOM -

OUTDOOR PLAY AREA 3

PLAYROOM 2



NOT FOR CONSTRUCTION

L.G.A. 1:200 MUSWELLBROOK TA/MS1 MS/SS 29.02.2024

SUN ISSUED FOR DEVELOPMENT APPLICATION

23714 DA06.02 A DA

SHEET NAME SHADOW DIAGRAMS & VIEW FROM

MUSWELLBROOK 2333

PROJECT ADDRESS 118 MAITLAND STREET

CHILDCARE CENTRE

PROJECT

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BROADCREST CONSULTING PTY LTD

ASSOCIATED CONSULTANTS AVENUE PLANNING STANBURY TRAFFIC PLANNING TRAFFIC QPC&C ACOUSTICS DAY DESIGN LANDSCAPE GREENSCAPE DESIGN

ACOR

A 29.02.2024 FOR CO-ORDINATION
ISSUE DATE DESCR DESCRIPTION

LEGEND NEIGHBOUR SHADOW EXISTING SHADOW

PROPOSED SHADOW

3 WINTER SOLSTICE - JUNE 21 - 3PM

1 WINTER SOLSTICE - JUNE 21 - 9AM

NOT FOR CONSTRUCTION

23714 DA06.03 A DA MUSWELLBROOK

29.02.2024

ISSUED FOR DEVELOPMENT APPLICATION

TA/MS1 MS/SS

VIEW FROM THE SUN

SHEET NAME

PROJECT ADDRESS

118 MAITLAND STREET MUSWELLBROOK 2333

CHILDCARE CENTRE

PROJECT

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DESCRIPTION ASSOCIATED CONSULTANTS AVENUE PLANNING STANBURY TRAFFIC PLANNING



2 WINTER SOLSTICE - JUNE 21 - 12PM

CLIENT

ARCHITECT


TRAFFIC

ACOUSTICS DAY DESIGN LANDSCAPE GREENSCAPE DESIGN **GEOTECH & PSI** BROADCREST CONSULTING PTY LTD CIVIL AND FLOOD ACOR


A 29.02.2024 FOR CO-ORDINATION

ISSUE DATE DESCRIB

2 SOLAR CALCULATION - JUNE 21 - 3PM 1:200

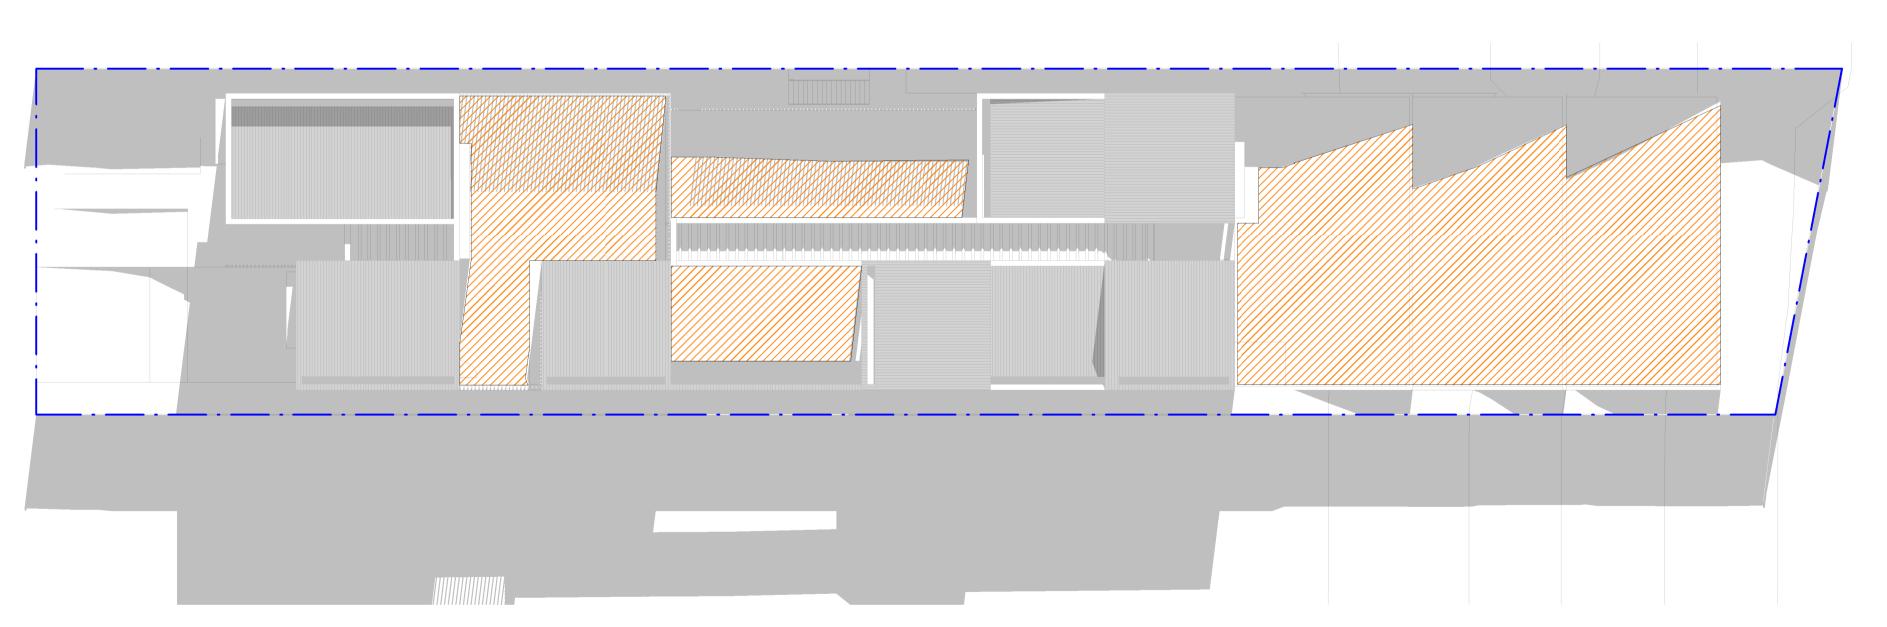

1 SOLAR CALCULATION - JUNE 21 - 12PM

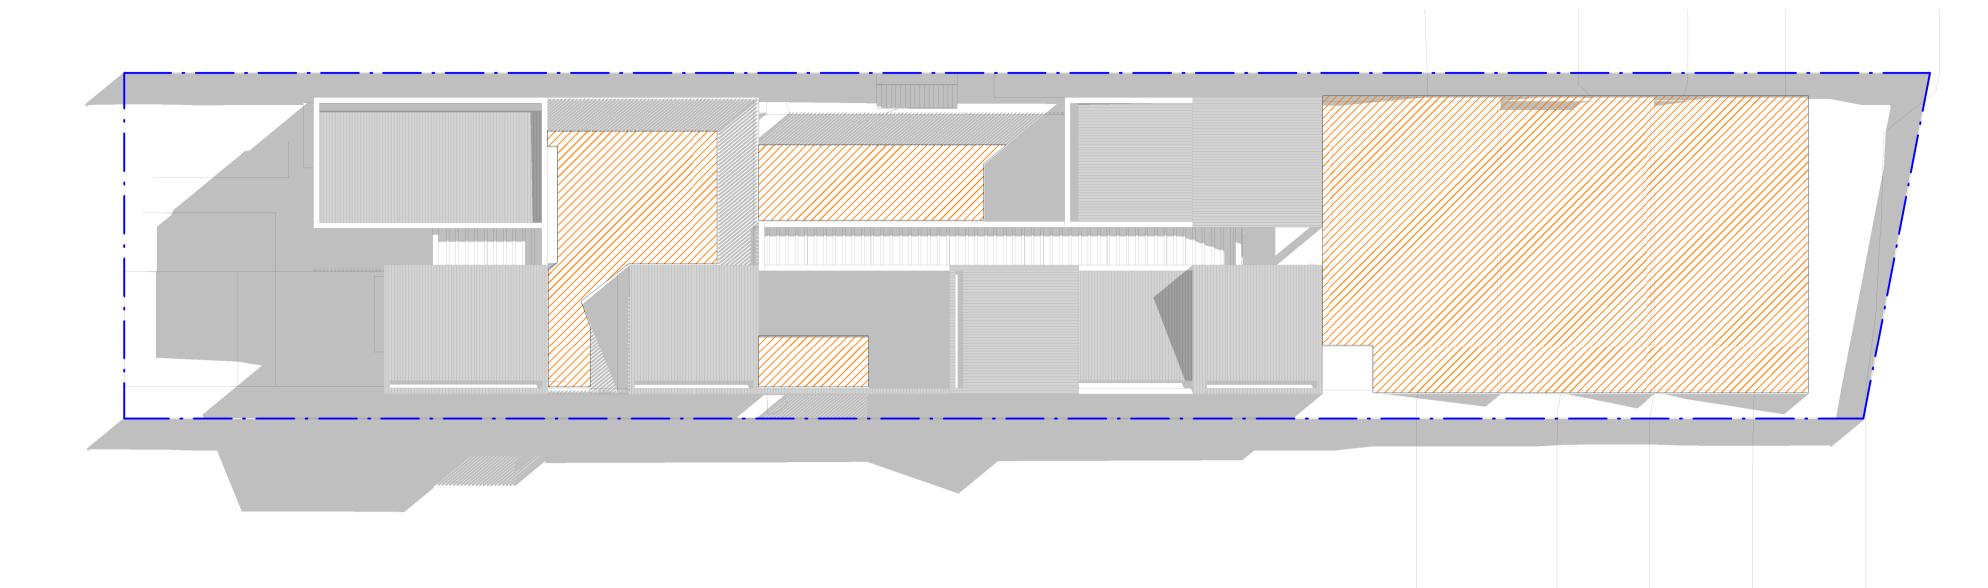

NOT FOR CONSTRUCTION

1:200 MUSWELLBROOK 29.02.2024 MS/SS

MUSWELLBROOK 2333

L.G.A.

A 29.02.2024 FOR CO-ORDINATION
ISSUE DATE DESCRI

AVENUE PLANNING STANBURY TRAFFIC QPC&C

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CHILDCARE CENTRE

118 MAITLAND STREET

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PROJECT

PROJECT ADDRESS

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LANDSCAPE GEOTECH & PSI CIVIL AND FLOOD

DESCRIPTION

DAY DESIGN
GREENSCAPE DESIGN
BROADCREST CONSULTING PTY LTD

LEGEND

WINTER SOLSTICE 12AM WINTER SOLSTICE 3PM

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=644M² =193.2M² (30%)

=536M² (83%) =520.962M² (78.45%)

ISSUED FOR DEVELOPMENT APPLICATION 23714 DA06.04 A DA

OUTDOOR SOLAR ACCESS

APPENDIX B: SPATIAL ANALYSIS REPORT





MAPPING & SPATIAL SERVICES

LOCATION: 118 Maitland Street, Muswellbrook

REPORT 3410

DATE 31.1.2024

SITE AREA 0.1371 ha (approx)

Disclaimer

Broadcrest Consulting has taken all reasonable care in collating and providing the data within this report on the basis that any person given access to this report are responsible for assessing the relevance of the content. The purpose of this report is to provide an overview of the site based on some data collated from various government, public and private sources. You should obtain independent advice before you make any decision based on the information in this report.

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Client	Мар
Jacky Angelovska	Site Aerial Photograph
Location	LGA
118 Maitland Street, Muswellbrook LOT: 34 DP 229637	MUSWELLBROOK SHIRE COUNCIL

Data Source

Base m

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Scale 1:2,250







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Client	Map
Jacky Angelovska	Site Location with Terrain
Location	LGA
118 Maitland Street, Muswellbrook	MUSWELLBROOK SHIRE COUNCIL

Data Source Geoscience Australia

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Client	Map
Jacky Angelovska	Topography
Location	LGA
118 Maitland Street, Muswellbrook	MUSWELLBROOK SHIRE COUNCIL

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Scale








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Client	Map
Jacky Angelovska	Slope Heat Map
Location	LGA
118 Maitland Street, Muswellbrook	MUSWELLBROOK SHIRE COUNCIL

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Client	Map
Jacky Angelovska	Land Zone Map
Location	LGA
118 Maitland Street, Muswellbrook	MUSWELLBROOK SHIRE COUNCIL

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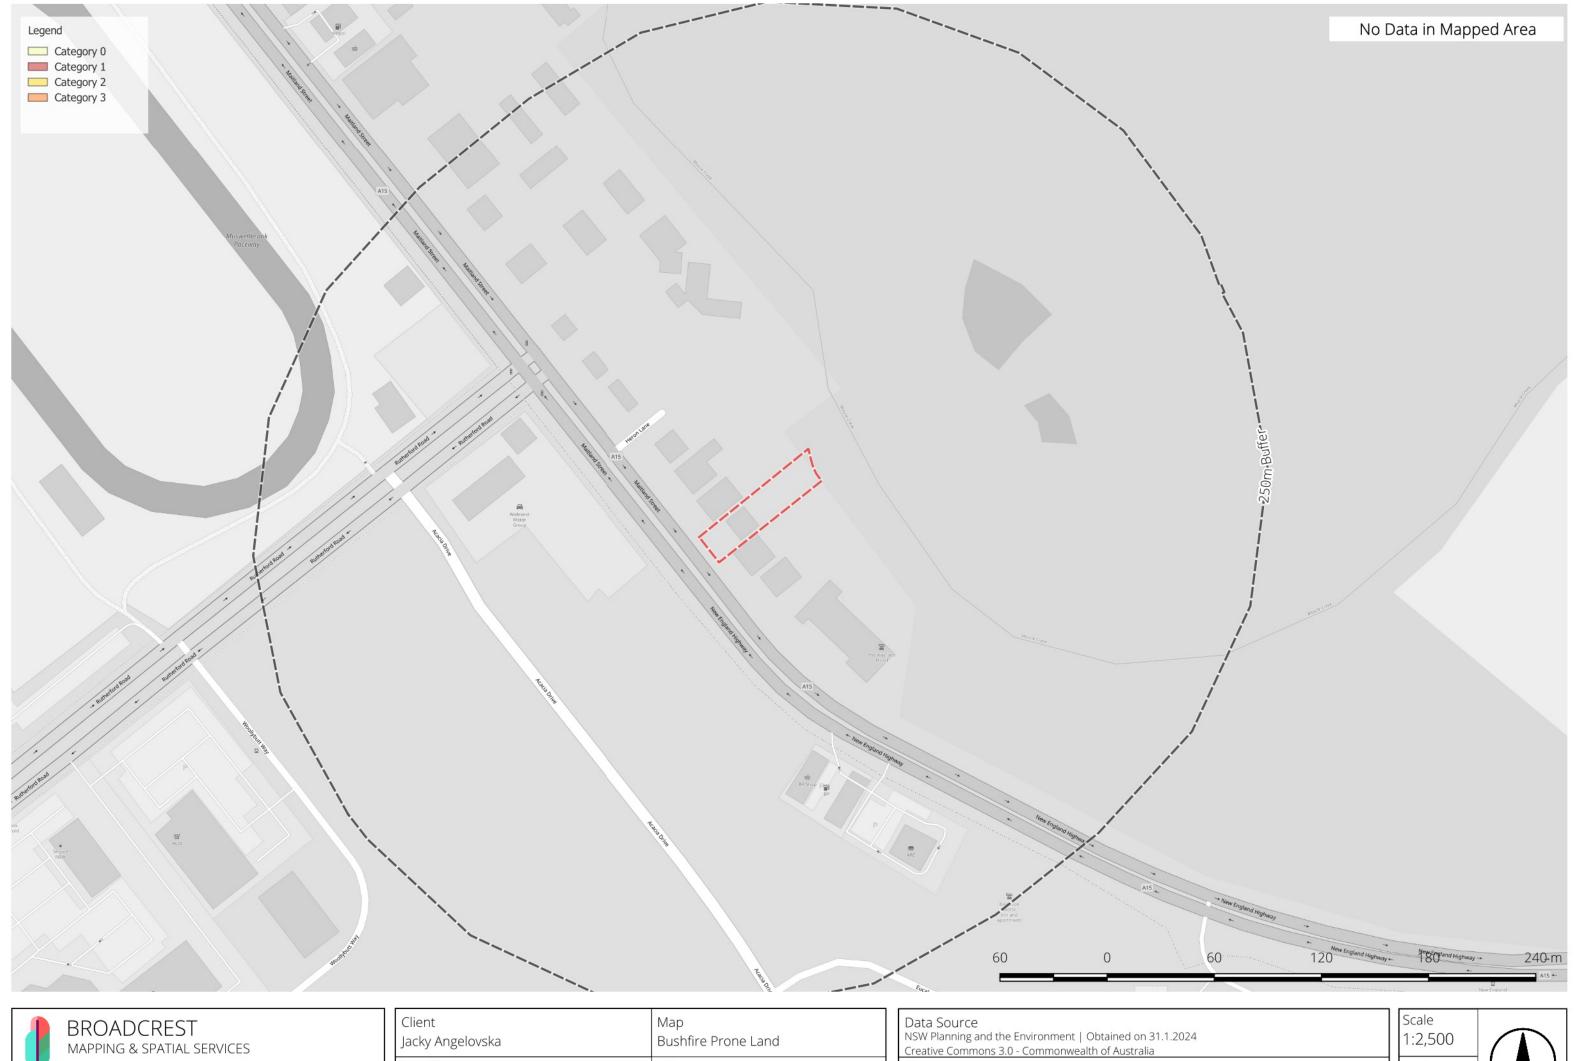
Client	Map
Jacky Angelovska	Heritage Listed Sites
Location	LGA
118 Maitland Street, Muswellbrook	MUSWELLBROOK SHIRE COUNCIL

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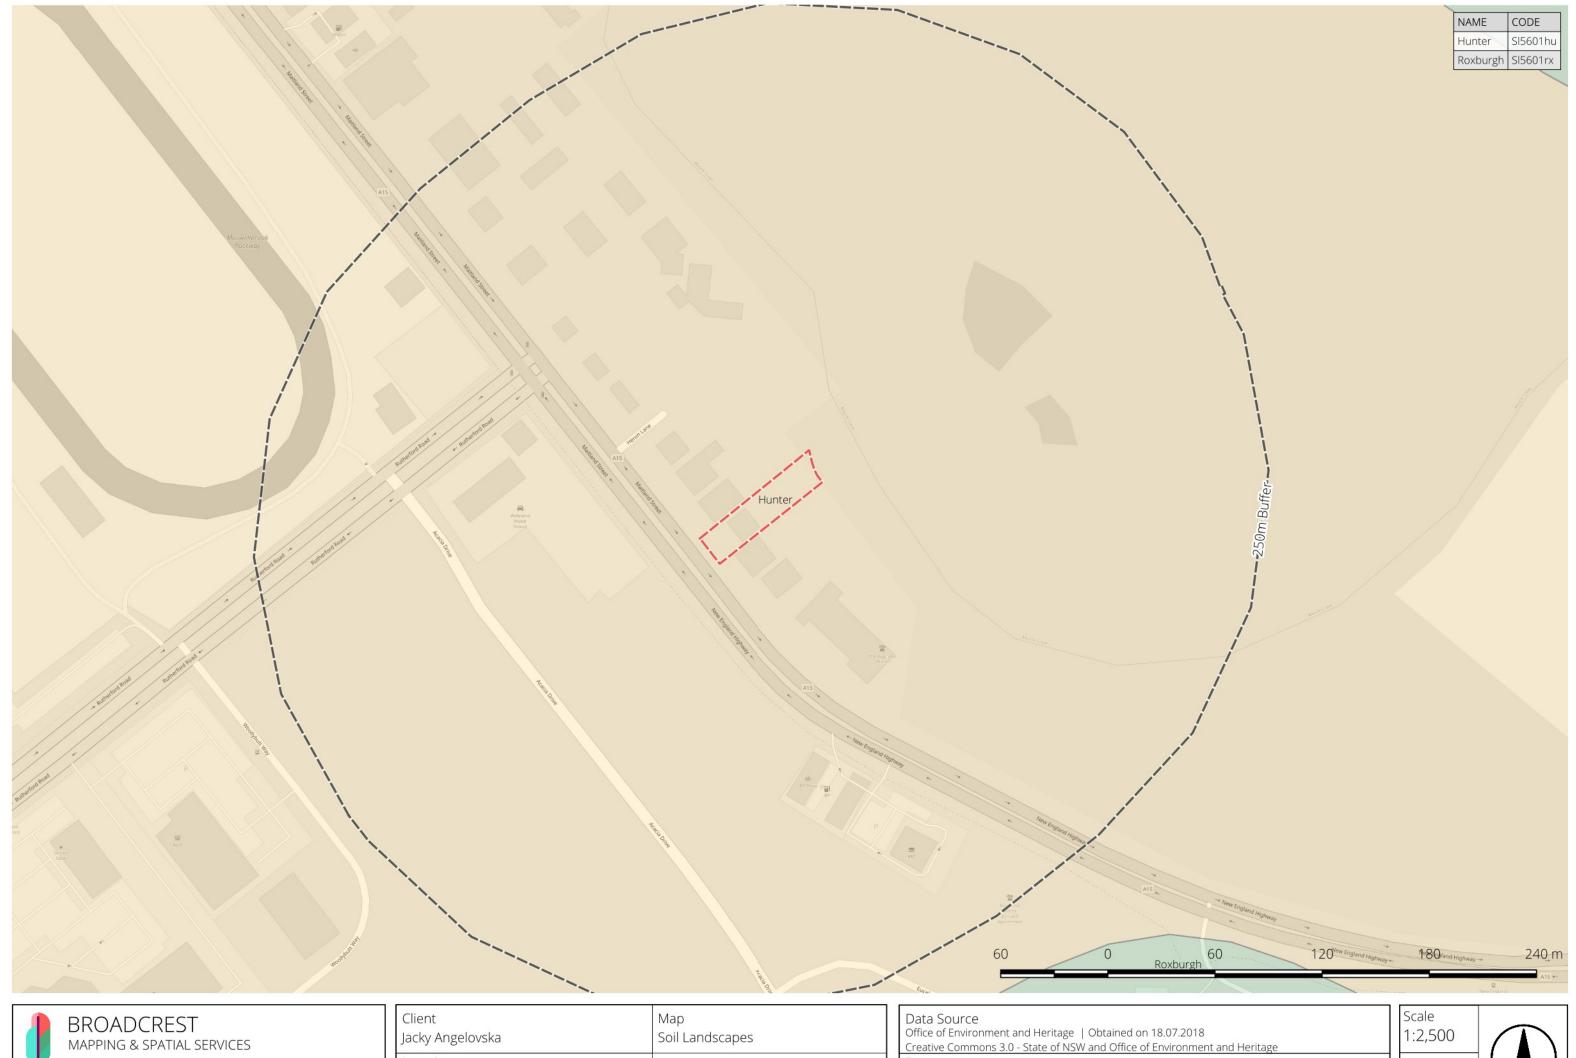
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Client	Map
Jacky Angelovska	Bushfire Prone Land
Location	LGA
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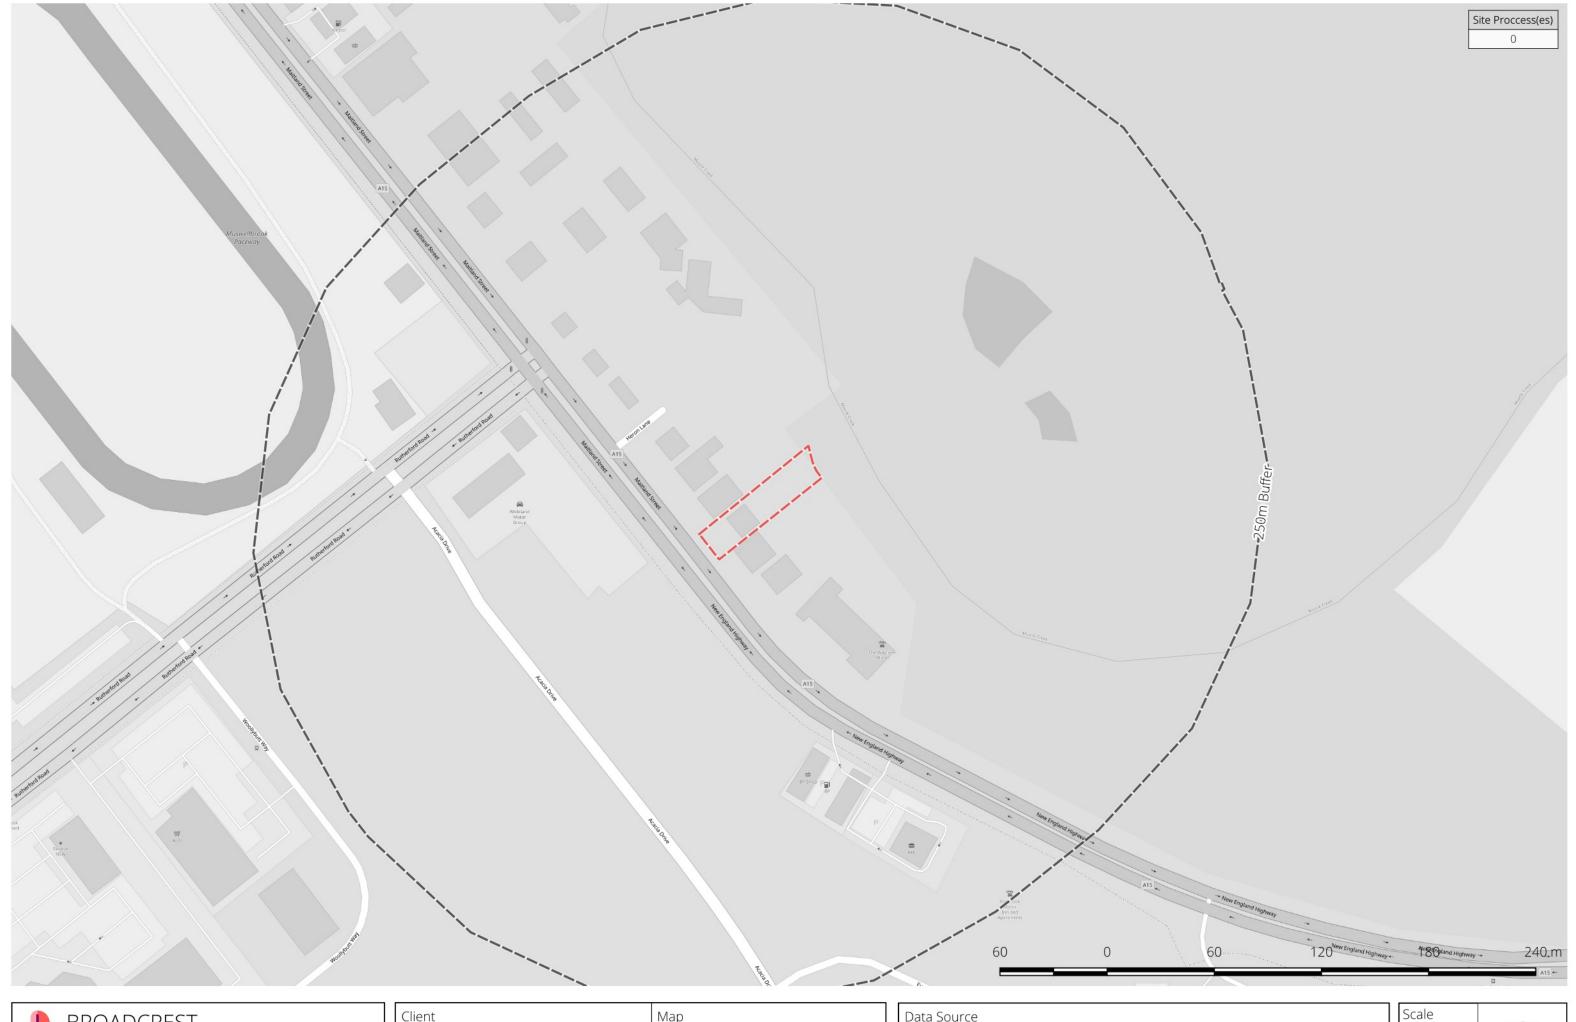
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Client	Map
Jacky Angelovska	Soil Landscapes
Location	LGA
118 Maitland Street, Muswellbrook	MUSWELLBROOK SHIRE COUNCIL

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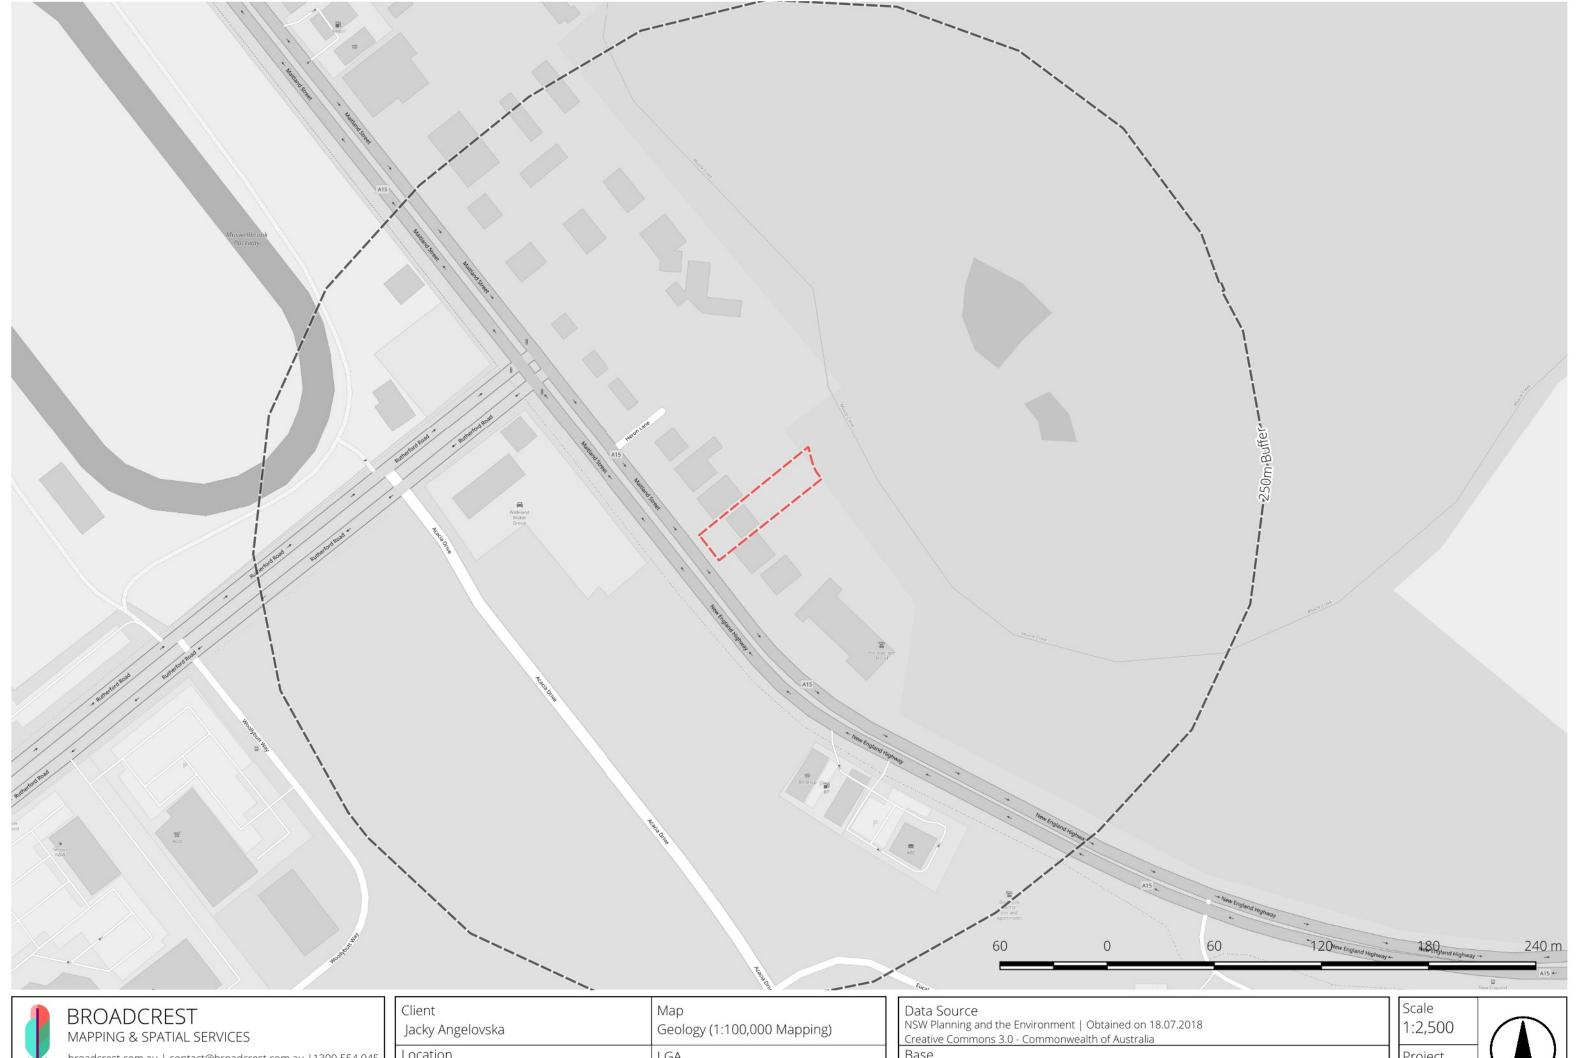
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Client	Map
Jacky Angelovska	Soil Formation
Location	LGA
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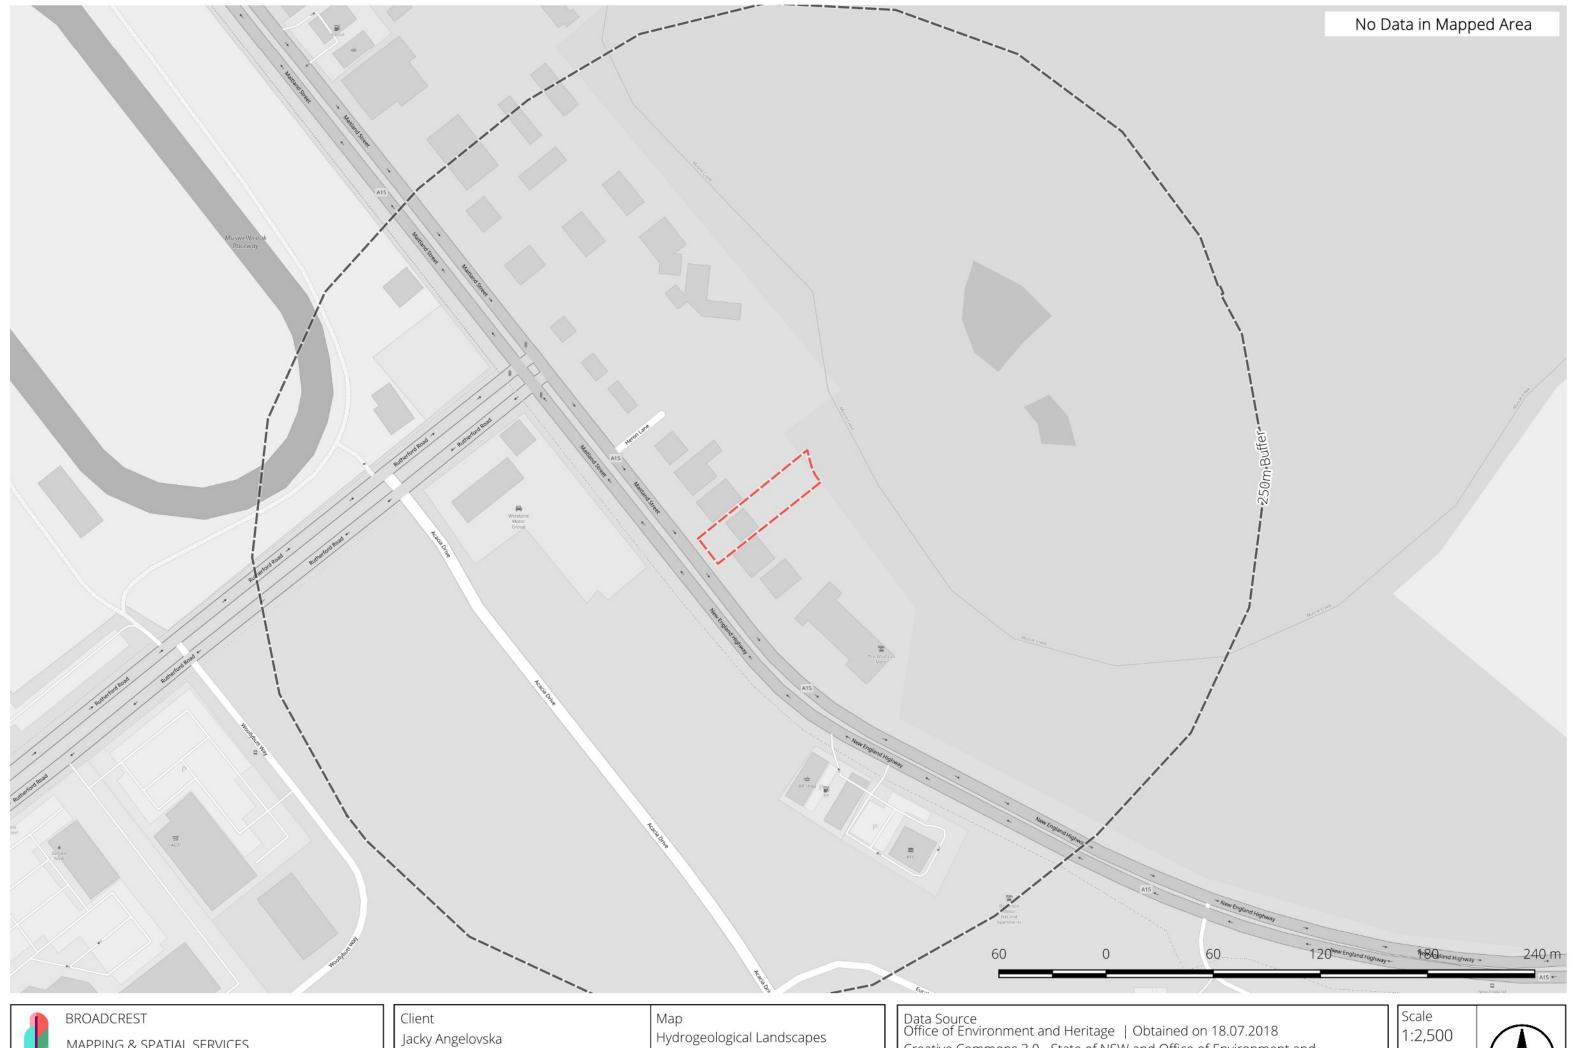

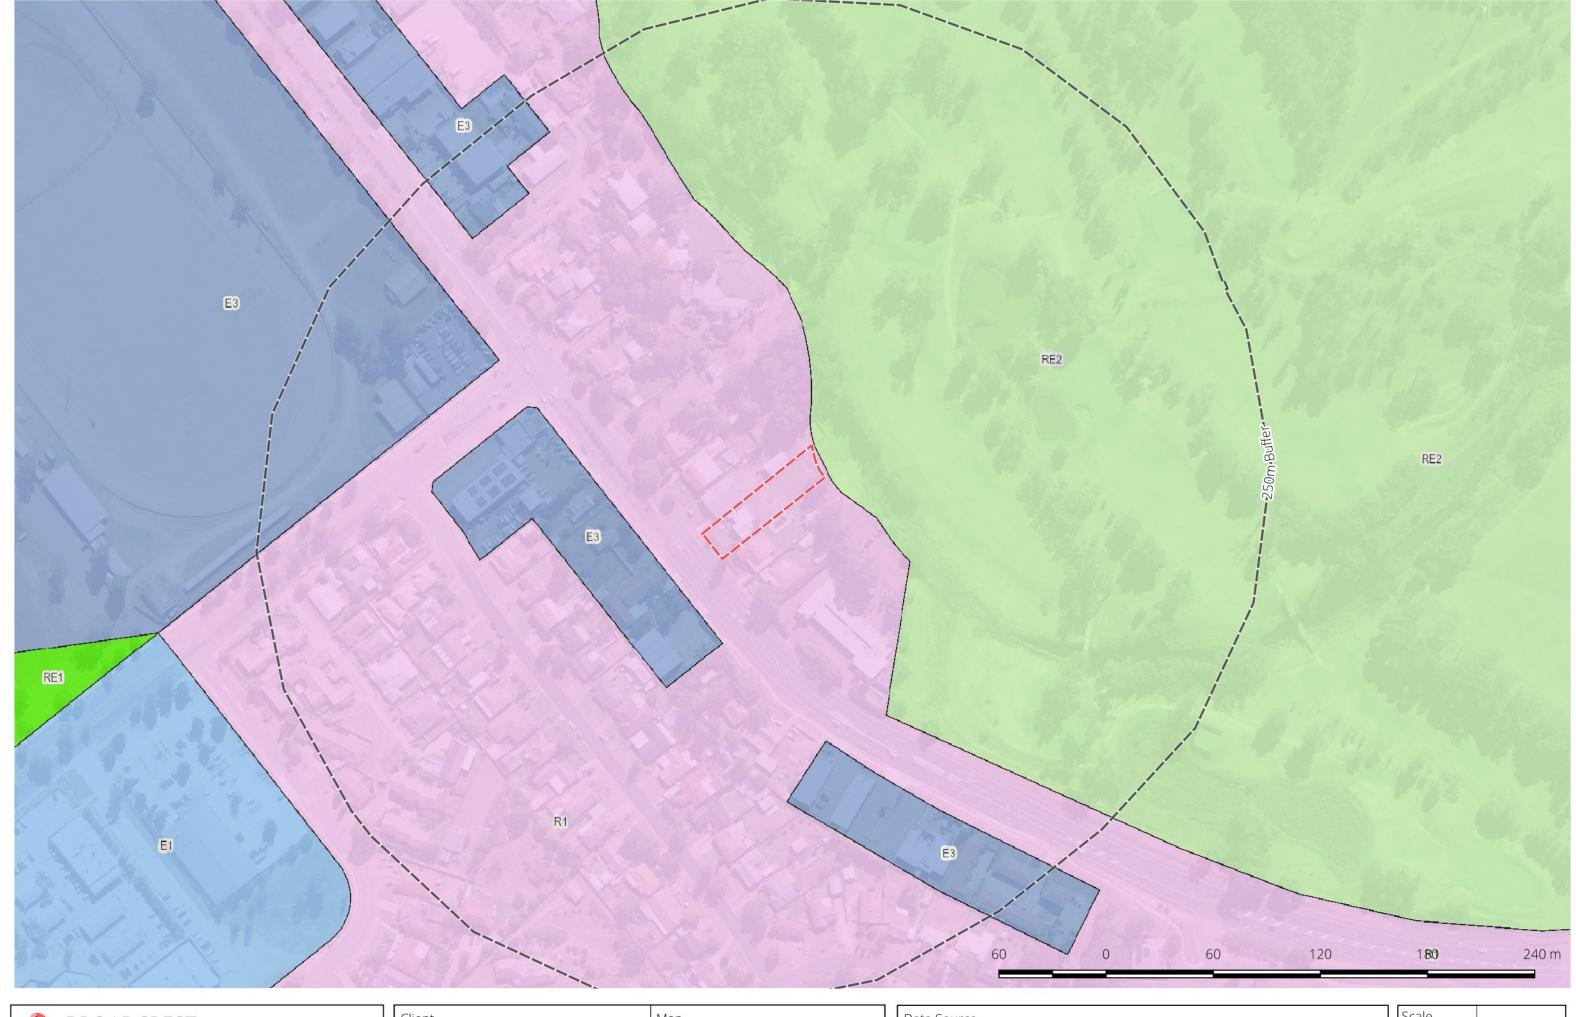
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Client	Map
Jacky Angelovska	Geology (1:100,000 Mapping)
Location	LGA
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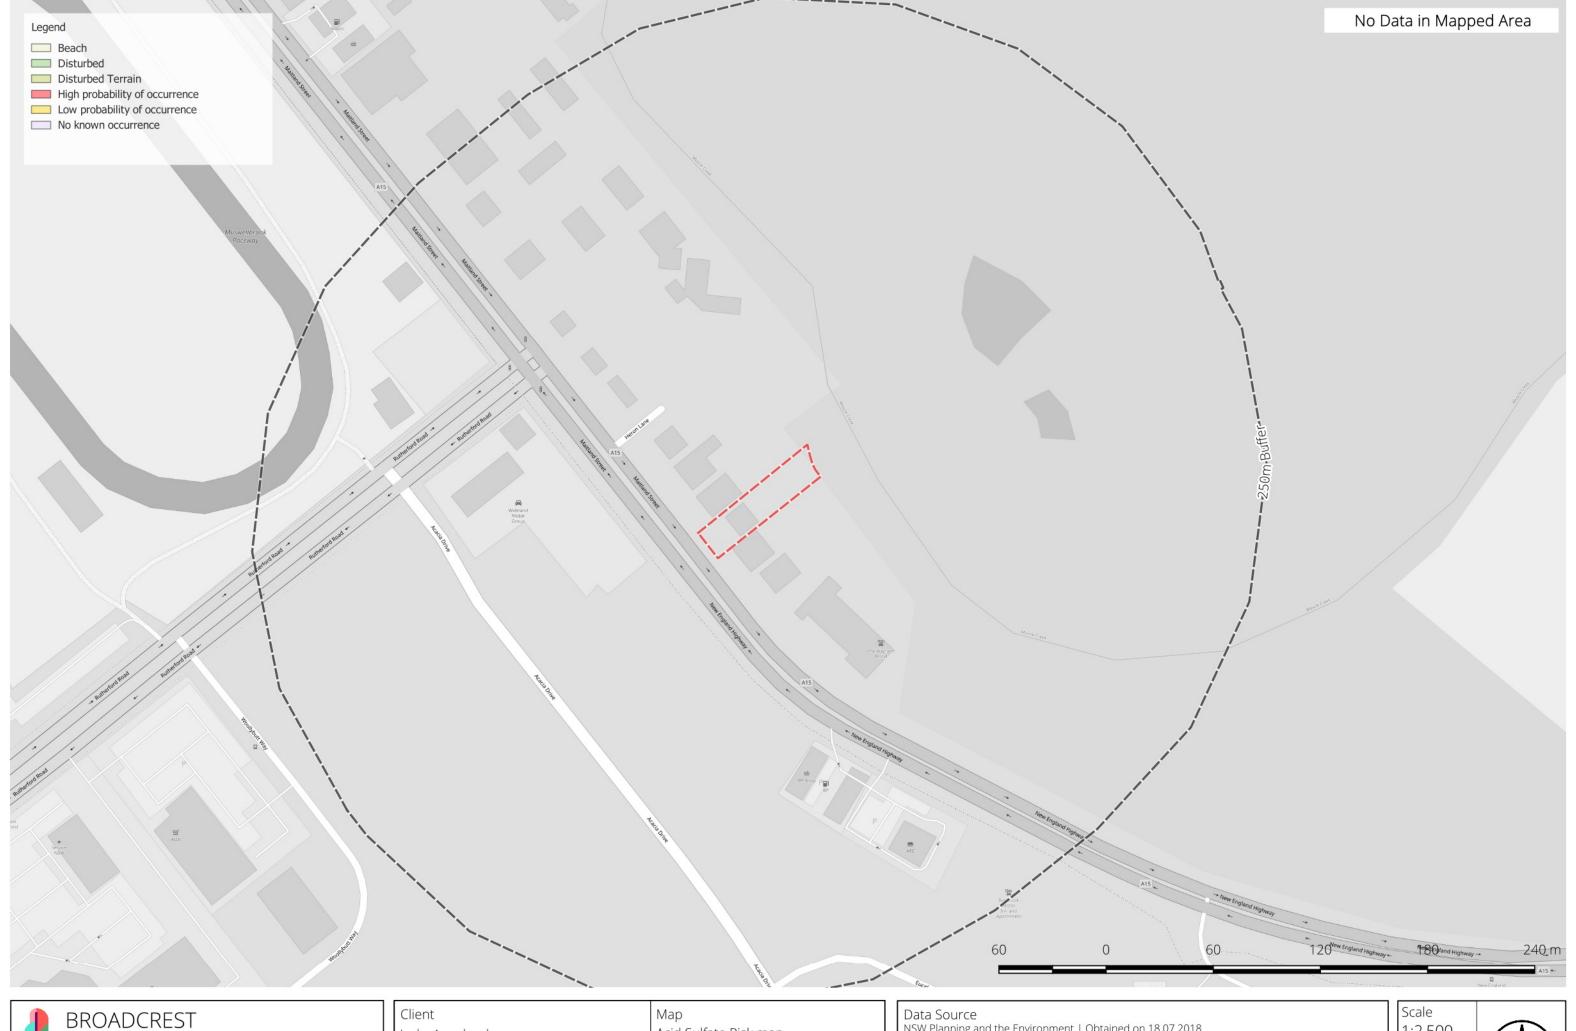


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b1399८555t €45nsulting Pty Ltd | -ABN: 622 508 187

	Map Hydrogeological Landscapes
Location 118 Maitland Street, Muswellbrook	LGA MUSWELLBROOK SHIRE COUNCIL

Data Source
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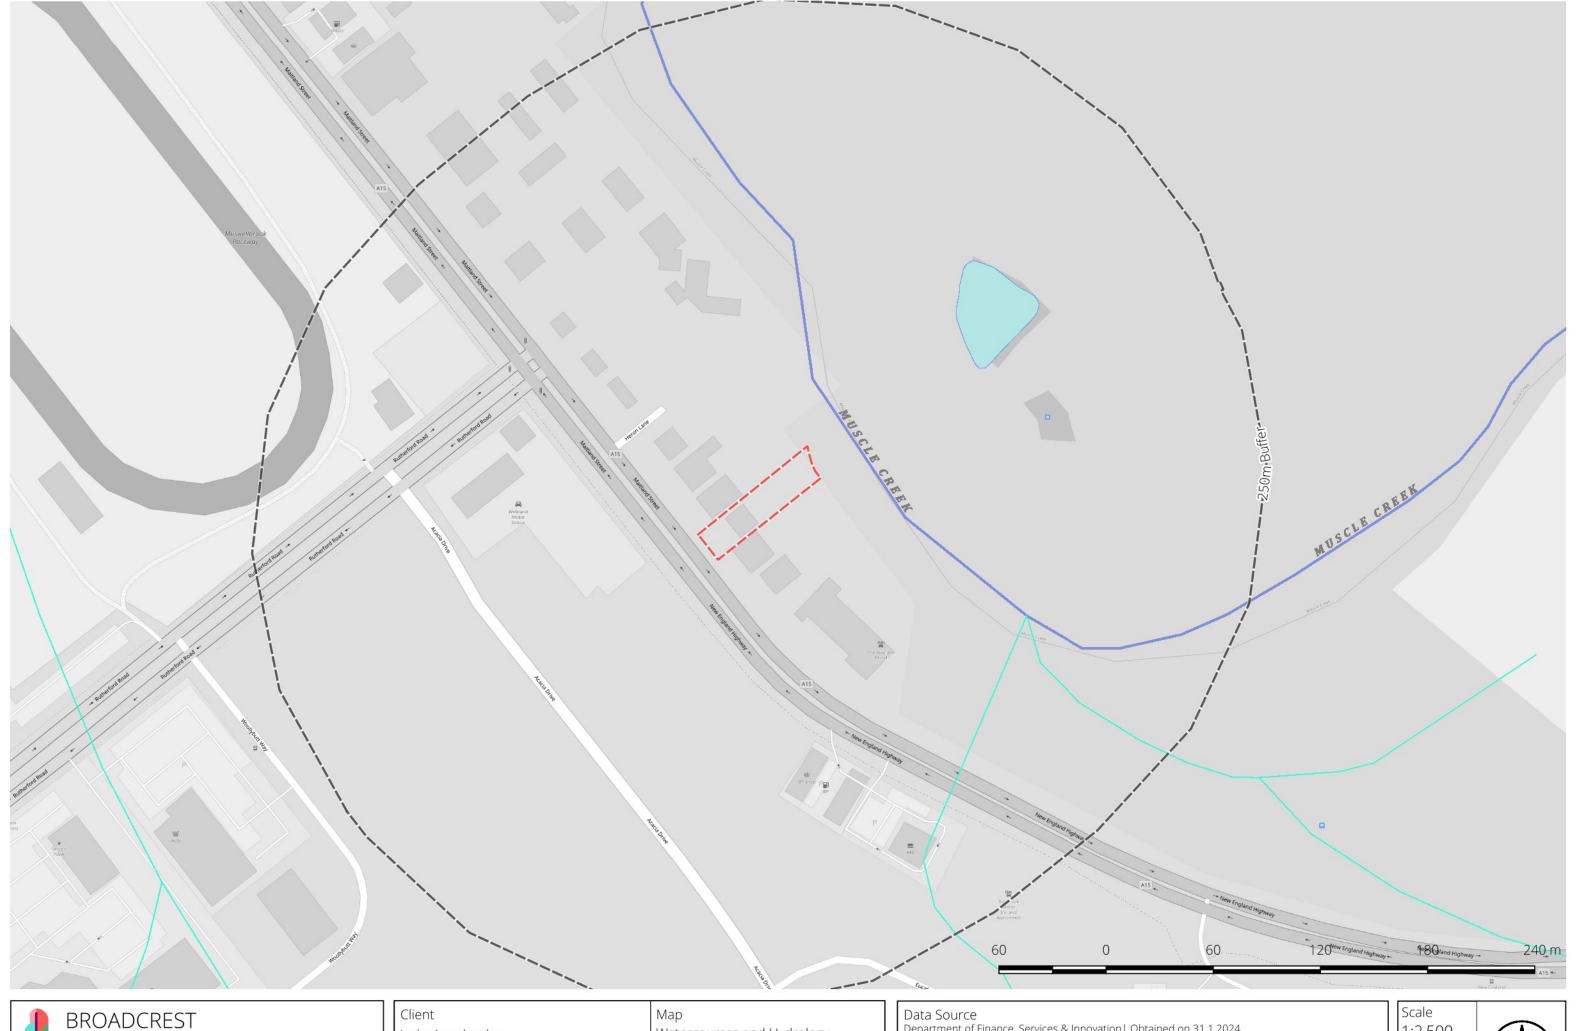


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Client	Мар
Jacky Angelovska	Acid Sulfate Risk map
Location 118 Maitland Street, Muswellbrook	LGA MUSWELLBROOK SHIRE COUNCIL

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Client	Мар
Jacky Angelovska	Watercourses and Hydrology
Location 118 Maitland Street, Muswellbrook	LGA MUSWELLBROOK SHIRE COUNCIL

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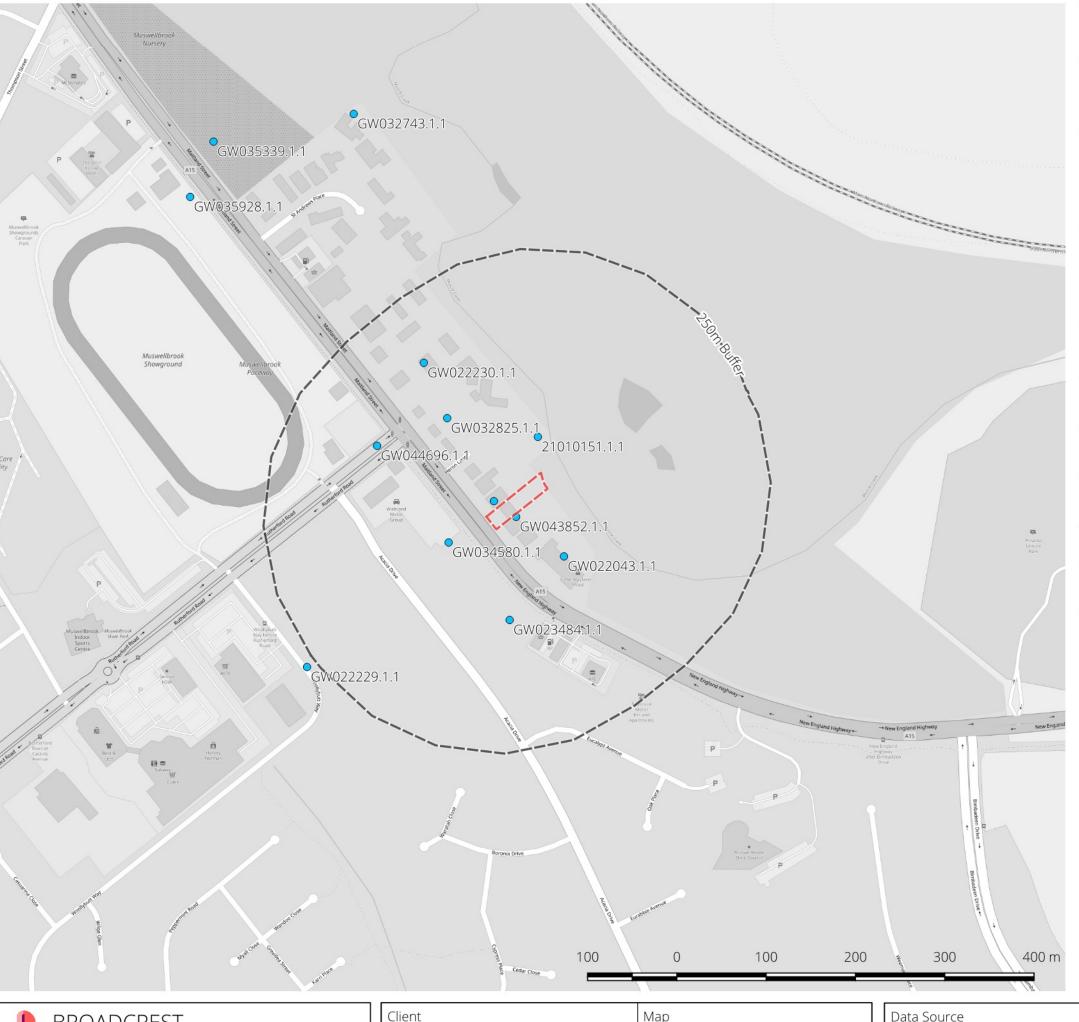
broadcrest.com.au | contact@broadcrest.com.au |1300 554 945 Broadcrest Consulting Pty Ltd | ABN: 622 508 187

Client	Map
Jacky Angelovska	Rainfall Overland Flow Paths
Location	LGA
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Data Source Derived from LiDAR Data | Geoscience Australia Creative Commons 3.0 - Commonwealth of Australia இத்த Street Maps | Obtained on 31.1.2024 Creative Commons 3.0 - OpenStreetMap Contributors

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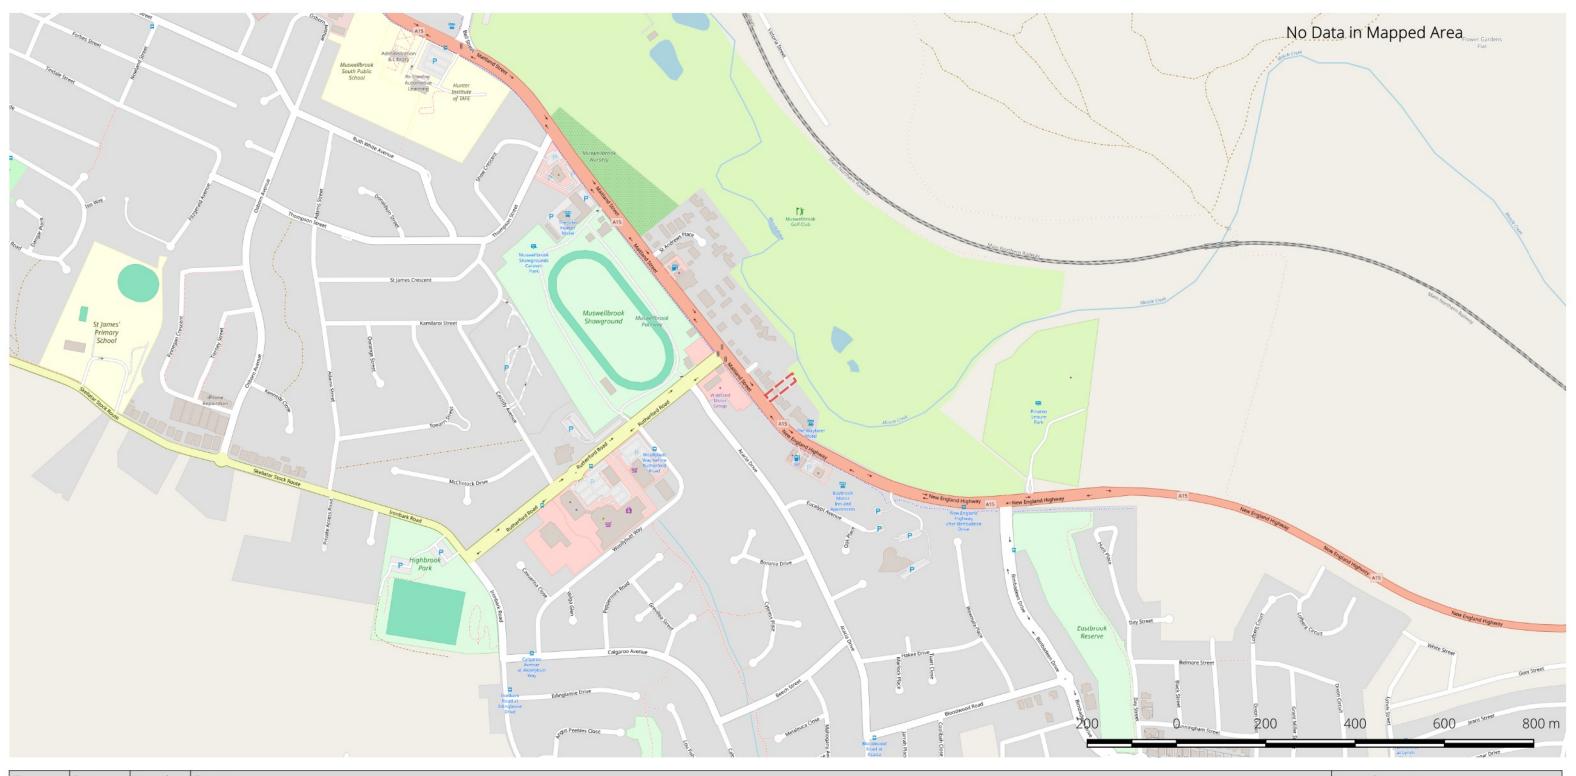
HydroCode	Depth	Strata Description	Bore Data
21010151.1.1	NULL	NULL	Ref Elevation: 150.3 AHD Purpose: Unknown
GW022043.1.1	0m - 0.3m 0.3m - 0.91m 0.91m - 1.22m 1.22m - 1.83m 1.83m - 5.49m 5.49m - 6.1m	Soil Clay Gravel Clay Loam sandy Clay stones	Date Drilled: 01/08/1964 Ref Elevation: 151.73 AHD Purpose: Irrigation
GW022229.1.1	0m - 0.91m 0.91m - 3.05m 3.05m - 10.06m	Soil Clay Sand gravel	Date Drilled: 01/08/1963 Ref Elevation: 160.69 AHD Drill Depth: 10.1m Purpose: Irrigation
GW022230.1.1	NULL	NULL	Date Drilled: 01/01/1965 Ref Elevation: 151.33 AHD Drill Depth: 6.7m Purpose: Irrigation
GW023484.1.1	NULL	NULL	Date Drilled: 01/01/1965 Ref Elevation: 153.12 AHD Drill Depth: 7.6m Purpose: Irrigation
GW029528.1.1	0m - 0.3m 0.3m - 1.52m 1.52m - 6.4m	Soil Clay Sand gravel	Date Drilled: 01/05/1967 Ref Elevation: 151.24 AHD Drill Depth: 6.4m Purpose: Irrigation
GW032743.1.1	NULL	NULL	Date Drilled: 01/04/1968 Ref Elevation: 152.34 AHD Drill Depth: 5.7m Purpose: Irrigation
GW032825.1.1	NULL	NULL	Date Drilled: 1800/01/01 Ref Elevation: 151 AHD Drill Depth: 6m Purpose: Irrigation
GW034580.1.1	NULL	NULL	Date Drilled: 1800/01/01 Ref Elevation: 152.64 AHD Drill Depth: 9.1m Purpose: Irrigation
GW035339.1.1	NULL	NULL	Date Drilled: 01/08/1972 Ref Elevation: 153.13 AHD Drill Depth: 9.1m Purpose: Irrigation
GW035928.1.1	0m - 7.62m 7.62m - 8.07m	Clay Gravel river	Date Drilled: 01/02/1973 Ref Elevation: 153 AHD Purpose: Irrigation
GW043852.1.1	NULL	NULL	Date Drilled: 01/05/1967 Ref Elevation: 151.72 AHD Drill Depth: 6m Purpose: Irrigation
GW044696.1.1	NULL	NULL	Date Drilled: 01/07/1975 Ref Elevation: 152.44 AHD Drill Depth: 7.3m Purpose: Water Supply



Client	Map
Jacky Angelovska	Groundwater Bores
Location	LGA
118 Maitland Street, Muswellbrook	MUSWELLBROOK SHIRE COUNCIL

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ID Date Hazard Synopsis Impact Comments

No data in mapped area.


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Client	Map	
Jacky Angelovska	Recorded Landslides	
Location	LGA	
118 Maitland Street, Muswellbrook	MUSWELLBROOK SHIRE COUNCIL	

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Licence No. Licence Status Organisation Name Scheduled Activity Fee-Based Activity Location Name Location Address

No data in mapped area.

Legend O POEO Public Register

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	ng Pty Ltd ABN: 622 508 187	

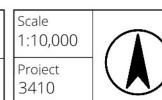Client	Map
Jacky Angelovska	EPA POEO Public Register
Location	LGA
118 Maitland Street, Muswellbrook	MUSWELLBROOK SHIRE COUNCIL

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300

400 m

100

Data Source

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Monitoring and Discharge Points

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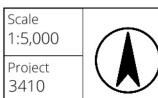
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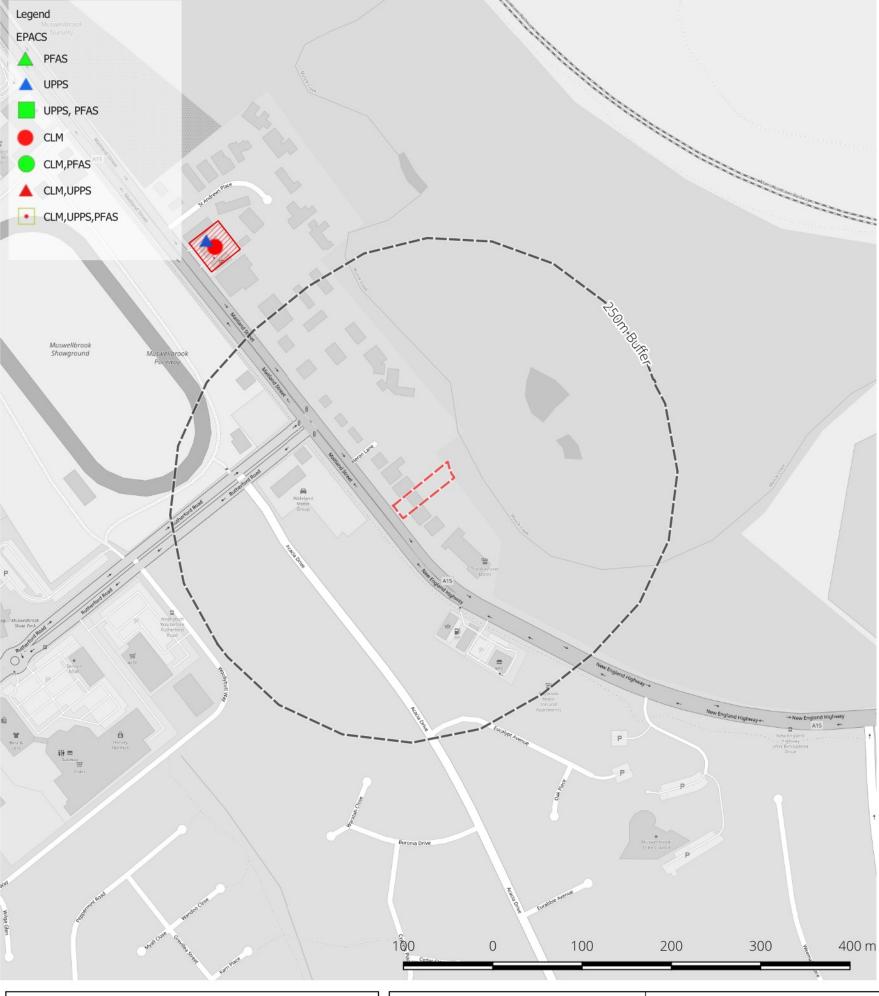
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Client	Map
Jacky Angelovska	EPA Licenced Premises
Location	LGA
118 Maitland Street, Muswellbrook	MUSWELLBROOK SHIRE COUNCIL

Data Source		0
NSW Environment Protection Authority Obtained on 31.1.2024		,
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	EPACS
Site id	SiteName
9782	Caltex Muswellbrook Service Station
19605	Caltex Muswellbrook




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	MAPPING & SPATIAL SERVICES
1	broadcrest.com.au contact@broadcrest.com.au 1300 554 945 Broadcrest Consulting Pty Ltd ABN: 622 508 187

Client	Map
Jacky Angelovska	EPA Contaminated Sites List
Location	LGA
118 Maitland Street, Muswellbrook	MUSWELLBROOK SHIRE COUNCIL

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				POEO	Notices
Number	Name	Location	Туре	Issued date	precision
1550862	MUSWELLBROOK SHIRE COUNCIL	Muswellbrook Water Treatment Plant	s.91 Clean Up Notice	7/04/2017	Rooftop



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	Broadcrest Consulting Ptv Ltd. LABN: 622 508 187

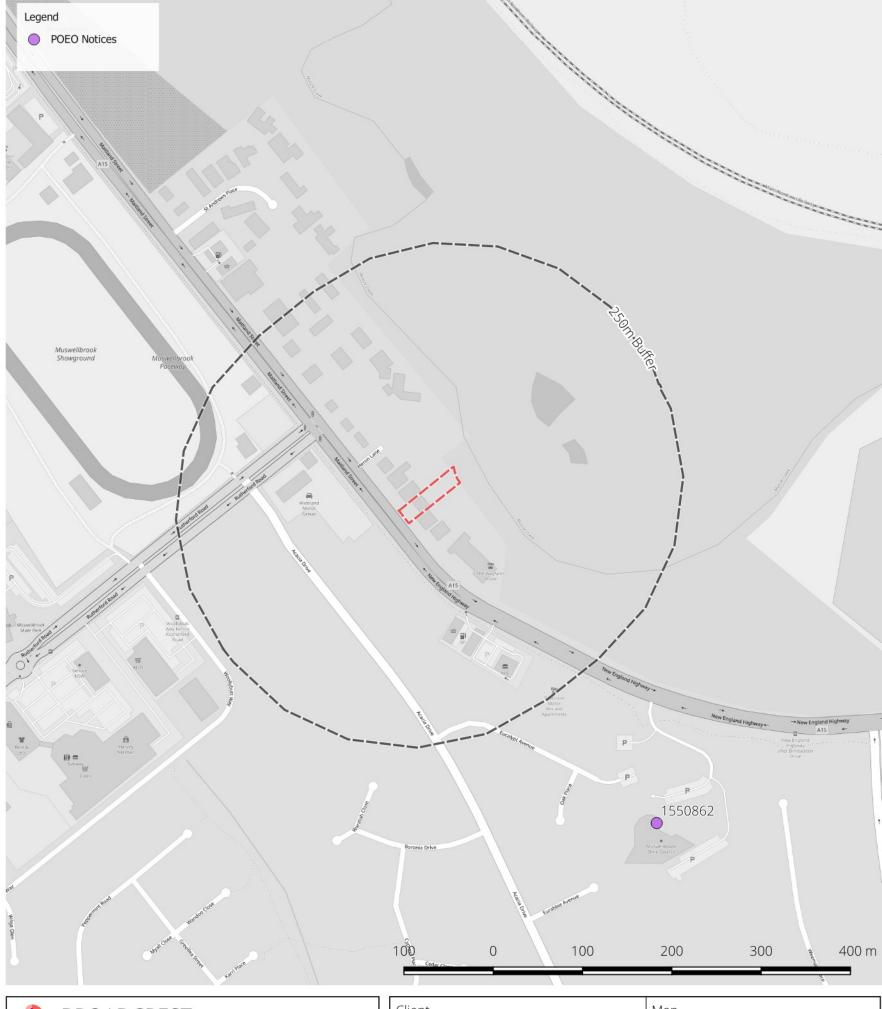Client	Map
Jacky Angelovska	EPA POEO Notices
Location	LGA
118 Maitland Street, Muswellbrook	MUSWELLBROOK SHIRE COUNCIL

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APPENDIX C: PHOTOGRAPHS



Figure C1: On-site residential structure, as viewed from Maitland Street facing north-east.



Figure C2: Carport and residential structure, as viewed from central portion of site facing southwest.



Figure C3: Empty cleaning solvent 'Pacer - Gun Wash' drums, located adjacent the residential structure, viewed facing south-west.



Figure C4: Rear yard, viewed facing west.



Figure C5: Rear yard and site boundary, as viewed facing north.



Figure C6: Drilling in the backyard



Figure C7: Fill materials, consisting of imported coal-wash, encountered within BH01 and BH04

APPENDIX D: SECTION 10.7 CERTIFICATE



PLANNING CERTIFICATE UNDER SECTION 10.7 (2) & (5) ENVIRONMENTAL PLANNING AND ASSESSMENT ACT 1979

 Enquiries
 Planning

 Contact
 02 6549 3700

 Receipt no.
 1569028

Your reference 118 Maitland Street
Muswellbrook

Date: 25 January 2024

Assessment: 39420 Cert No: 23723

Broadcrest Consulting Pty Ltd 101 Pyramid Street Emu Plains NSW 2750 Owner (as recorded by Council)

L Abounader & J Angelovska

Property Description: 118 Maitland Street MUSWELLBROOK 2333

LOT: 34 DP: 229637

Land to which the certificate relates

The information contained in this certificate relates only to the lot or lots described on this certificate. Separate planning certificates can be obtained upon application for the other lots, those certificates may contain different information than is contained in this certificate.

This certificate provides information on how the relevant parcel of land may be developed, including the planning policies that may apply to development of the land, on the date the certificate is issued.

CERTIFICATE UNDER SECTION 10.7(2) ENVIRONMENTAL PLANNING & ASSESSMENT ACT

1. NAMES OF RELEVANT PLANNING INSTRUMENTS AND DEVELOPMENT CONTROL PLANS

STATE ENVIRONMENTAL PLANNING POLICIES

The following State Environmental Planning Policies apply to land within the Muswellbrook Shire LGA:

SEPP (Biodiversity and Conservation) 2021 – This policy contains:

- Planning rules and controls for the clearing of native vegetation in NSW on land zoned for urban and environmental purposes that is not linked to a development application.
- The land use planning and assessment framework for koala habitat (Chapter 4).

<u>SEPP (Exempt and Complying Development Codes) 2008</u> – The policy provides exempt and complying codes that have State-wide application, identifying types of development that are of minimal environmental impact that may proceed without development consent, but may require a complying development certificate.

<u>SEPP No. 65 (Design Quality of Residential Apartment Development)</u> – This policy aims to raise the design quality of residential flat development through the application of a series of design principles.

<u>SEPP (Housing) 2021</u> - This policy supports the development of diverse housing types, including affordable housing and purpose-built rental housing, reinforce the importance of designing housing for climate, hazards and to reflect the locality it is being built in, and to mitigate the loss of affordable rental housing.

<u>SEPP (Industry and Employment) 2021</u> – This policy contains planning provisions for advertising signage in NSW.



Date: 25 January 2024

Cert No: 23723

SEPP (Planning Systems) 2021 - This policy:

- Identifies State or Regionally significant development, State significant infrastructure, and critical State significant infrastructure (Chapter 2).
- Provides consideration of development delivery plans by local Aboriginal land councils (Chapter 3).
- Allows the Planning Secretary to elect to be the concurrence authority for certain development (Chapter 4).

<u>SEPP (Precincts - Regional) 2021</u> – This policy contains planning provisions for precinct planning for a specified geographic area. The precincts in this SEPP are located outside the Greater Sydney Region Plan.

SEPP (Primary Production) 2021 – This policy contains planning provisions:

- To manage primary production and rural development including supporting sustainable agriculture.
- For the protection of prime agricultural land of state and regional significance as well as regionally significant mining and extractive resources.

SEPP (Resilience and Hazards) 2021 – This policy contains planning provisions:

- To manage hazardous and offensive development (Chapter 3).
- To provide a state-wide planning framework for the remediation of contaminated land and to minimise the risk of harm (Chapter 4).

SEPP (Resources and Energy) 2021 – This policy contains planning provisions:

- For mining, petroleum production and extractive material resource proposals in NSW.
- The locations where open cut mining and coal seam gas projects are prohibited.
- To facilitate the development of extractive resources in proximity to the population of the Sydney.

<u>SEPP (Sustainable Buildings) 2022 – This policy contains planning provisions:</u>

- To encourage the design and delivery of sustainable buildings.
- To minimise the consumption of energy.
- To reduce greenhouse gas emissions.
- To minimise the consumption of mains-supplied potable water.

The provisions apply to residential development (Chapter 2) and non-residential development (Chapter 3).

<u>SEPP (Transport and Infrastructure) 2021</u> – This policy contains planning provisions:

- For infrastructure, such as hospitals, roads, railways, emergency services, water supply and electricity delivery (Chapter 2).
- For child-care centres, schools, TAFEs and Universities (Chapter 3).



Date: 25 January 2024

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Further details regarding these State Environmental Planning Policies and the circumstances in which they may apply to the subject and can be found on the Department of Planning's website.

REGIONAL PLANNING INSTRUMENTS

Hunter Regional Plan 2041 Upper Hunter Strategic Land Use Regional Plan 2012

LOCAL PLANNING INSTRUMENTS

The provisions of Muswellbrook Local Environmental Plan 2009 apply to this land.

Employment Zones Reform

On 26 April 2023, Business and Industrial zones were replaced by Employment zones within standard instrument local environmental plans.

A two-year transitional arrangement exists to continue land use permissibility where the translation to employment zones altered the land use permissibility. Until 26 April 2025, a land use that was permissible with consent under a former zone (for instance, the B2 Local Centre zone) that will not be permissible under the translated zone, will continue to be permissible through the transitional provision.

DEVELOPMENT CONTROL PLANS

The provisions of Muswellbrook Development Control Plan 2009 apply to this land.

2. ZONING AND LAND USE

LOCAL ENVIRONMENTAL PLANS

PLANNING INSTRUMENT Muswellbrook Local Environmental Plan 2009

LAND USE ZONING R1 General Residential

PERMITTED WITHOUT CONSENT

Home occupations

PERMITTED WITH CONSENT

Attached dwellings; Bed and breakfast accommodation; Boarding houses; Building identification signs; Business identification signs; Child care centres; Community facilities; Dual occupancies; Dwelling houses; Educational establishments; Environmental facilities; Environmental protection works; Exhibition homes; Exhibition villages; Flood mitigation works; Group homes; Health consulting rooms; Home-based child care; Home businesses; Home industries; Hostels; Kiosks; Multi dwelling housing; Neighbourhood shops; Oyster aquaculture; Places of public worship; Pond-based aquaculture; Recreation areas; Residential flat buildings; Respite day care centres; Roads; Secondary dwellings; Semi-detached dwellings; Seniors housing; Sewage reticulation systems; Shop top housing; Tankbased aquaculture; Water recycling facilities; Water supply systems.



Date: 25 January 2024

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PROHIBITED

Any development not specified above.

MINIMUM LAND DIMENSIONS FOR THE ERECTION OF A DWELLING

Under the provisions of the Muswellbrook Local Environmental Plan 2009, the minimum subdivision lot size IS NOT TO BE LESS than 600m2.

WHETHER THE LAND INCLUDES OR COMPRISES CRITICAL HABITAT

The subject land has not been declared as critical habitat.

WHETHER THE LAND IS IN A CONSERVATION AREA

The subject land is not within a conservation area.

WHETHER AN ITEM OF ENVIRONMENTAL HERITAGE IS SITUATED ON THE LAND

The land is NOT affected by any known or listed heritage item.

3. CONTRIBUTION PLANS

The Muswellbrook Section 94 Contributions Plan 2001 and Muswellbrook Section 94A Contributions Plan 2009 apply to all land within the Muswellbrook Shire Local Government Area.

The land is not within a special contributions area under the EP&A Act, Division 7.1.

4. COMPLYING DEVELOPMENT

Complying development may be carried out on the land under each of the following codes for complying development, to the extent stated, because of the provisions of clauses 1.17A(1)(c) to (e), (2), (3) and (4), 1.18 (1) (c3) and 1.19 of State Environmental Planning Policy (Exempt and Complying Development Codes) 2008.

INFORMATION SET OUT IN CLAUSE 4 OF SCHEDULE 2 OF THE ENVIRONMENTAL PLANNING & ASSESSMENT REGULATIONS

Part 3 General Housing Code

YES. Complying development specified in the General Housing Code may be carried out on this land in certain circumstances pursuant to Clause 1.19 of State Environmental Planning Policy (Exempt and Complying Development Codes) 2008.

Part 3A Rural Housing Code

Not applicable to the land to which this certificate relates.

Part 4 Housing Alterations Code

YES. Complying development specified in the Housing Alterations Code may be carried out on this land in certain circumstances pursuant to Clause 1.19 of State Environmental Planning Policy (Exempt and Complying Development Codes) 2008.



Date: 25 January 2024

Cert No: 23723

Part 4A General Development Code

YES. Complying development specified in the General Development Code may be carried out on this land in certain circumstances pursuant to Clause 1.19 of State Environmental Planning Policy (Exempt and Complying Development Codes) 2008.

Part 5 Commercial and Industrial Alterations Code

Not applicable to the land to which this certificate relates.

Part 5A Commercial and Industrial (New Buildings and Additions) Code

Not applicable to the land to which this certificate relates.

Part 6 Subdivision Code

YES. Complying development specified in the Subdivision Code may be carried out on this land in certain circumstances pursuant to Clause 1.19 of State Environmental Planning Policy (Exempt and Complying Development Codes) 2008.

Part 7 Demolition Code

YES. Complying development specified in the Demolition Code may be carried out on this land in certain circumstances pursuant to Clause 1.19 of State Environmental Planning Policy (Exempt and Complying Development Codes) 2008.

Part 8 Fire Safety Code

YES. Complying development specified in the Fire Safety Code may be carried out on this land in certain circumstances pursuant to Clause 1.19 of State Environmental Planning Policy (Exempt and Complying Development Codes) 2008.

5. EXEMPT DEVELOPMENT

The land is land on which exempt development may be carried out under the exempt development codes under SEPP (Exempt and Complying Development Codes) 2008.

6. AFFECTED BUILDING NOTICES AND BUILDING PRODUCT RECTIFICATION ORDERS

- (a) There are NO building product rectification order of which the council is aware that is in force in respect of the land and has not been fully complied with, and
- (b) There are NO notice of intention to make a building product rectification order of which the council is aware has been given in respect of the land and is outstanding.

7. LAND RESERVED FOR ACQUISITION

There are NO environmental planning instruments; deemed environmental planning instruments or draft environmental planning instruments applying to the land that provide for the acquisition of the land by a public authority, as referred to in section 27 of the Environmental Planning and Assessment Act 1979.



Date: 25 January 2024

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8. ROAD WIDENING AND ROAD REALIGNMENT

The subject land IS NOT affected by any road widening or road realignment under:

- (a) Division 2 of Part 3 of the Roads Act 1993, or
- (b) Any environmental planning instrument, or
- (c) Any resolution of the council.

9. FLOOD RELATED DEVELOPMENT CONTROLS INFORMATION

The land is within a flood planning area and any development on the land is subject to flood-related development controls in the Muswellbrook Floodplain Risk Management Study and Plan and Muswellbrook DCP 2009.

10. COUNCIL AND OTHER PUBLIC AUTHORITY POLICIES ON HAZARD RISK RESTRICTIONS

The land IS NOT affected by a policy adopted by the council, or adopted by any other public authority that restricts the development of the land because of the likelihood of land slip, bushfire, tidal inundation, subsidence, acid sulphate soils or any other risk (other than flooding). Muswellbrook DCP 2009 contains requirements for new development to consider the issues of potentially contaminated land, and land use buffers to premises that may emit odours.

11. BUSH FIRE PRONE LAND

The land IS NOT bush fire prone land.

12. LOOSE-FILL ASBESTOS INSULATION

There are NO residential premises located on this land that are listed on the register that are required to be maintained under Division 1A of Part 8 of the *Home Building Act 1989*.

13. MINE SUBSIDENCE

The land IS NOT WITHIN a Mine Subsidence District proclaimed under section 15 of the Mine Subsidence Compensation Act, 1961.

14. PAPER SUBDIVISION INFORMATION

There is NOT an adopted development plan or subdivision order that applies to the land.

15. PROPERTY VEGETATION PLANS

Council has NOT been notified of the existence of such a plan or if the land is land to which a property vegetation plan under the Native Vegetation Act 2003 applies.

16. BIODIVERSITY STEWARDSHIP SITES

Council has NOT been notified that the land is a biodiversity stewardship site under a biodiversity stewardship agreement under the Biodiversity Conservation Act 2016.

17. BIODIVERSITY CERTIFIED LAND

The land IS NOT biodiversity certified under the Biodiversity Conservation Act 2016.



Date: 25 January	y 2024	

Cert No: 23723

18. ORDERS UNDER TREES (DISPUTES BETWEEN NEIGHBOURS) ACT 2006

Council has NOT been notified of any order made under the Trees (Disputes Between Neighbours) Act 2006 to carry out work in relation to a tree on the land.

19. ANNUAL CHARGES UNDER THE LOCAL GOVERNMENT ACT 1993 FOR COASTAL PROTECTION SERVICES

The Coastal Management Act 2016 DOES NOT apply to this council area.

20. WESTERN SYDNEY AEROTROPOLIS

State Environmental Planning Policy (Precincts – Western Parkland City) 2021 DOES NOT apply to this council area.

21. DEVELOPMENT CONSENT CONDITIONS FOR SENIORS HOUSING

There is NOT a current site compatibility certificate (of which the council is aware), issued under clause 25 of State Environmental Planning Policy (Housing for Seniors or People with a Disability) 2004 in respect of proposed development on the land.

22. SITE COMPATIBILITY CERTIFICATES AND CONDITIONS FOR AFFORDABLE RENTAL HOUSING

There is NOT a current site compatibility certificate for affordable rental housing (of which the council is aware), issued under clause 39 of State Environmental Planning Policy (Housing) 2021 in respect of proposed development on the land.

The accuracy and currency of the details provided by agencies external to Council have not be verified by Muswellbrook Shire Council and should be verified by the applicant.

ADDITIONAL INFORMATION PURSUANT TO SECTION 10.7(5) OF THE ACT

Council is unaware of any other relevant matters that may affect the land.

For further information, please contact Planning, Environment & Regulatory Services on (02) 6549 3700.

D Finnigan General Manager

Per:	5



Date: 25 January 2024

Cert No: 23723

MUNICIPALITY OF MUSWELLBROOK

PLAN OF SANITARY DRAINAGE

Drainage Plan No. 2629	
Detail Plan No.	Fees \$22-00 PAID
For Heblen MINING CO	CONTRACTOR OF THE CONTRACTOR O
Post Plan to HEBDEN MINING CO	P.D. Box 269, Muswarthook

This plan is the property of the owner and must be returned to him on completion of the work.


All plumbing and drainage work shown an the plan must be carried out by a licensed plumber and drainer, strictly in accordance with the provisions of Ordinance 46 of the Local Government Act 1919, and to the satisfaction of Council's Health Inspector. No alteration is to be made to this drainage plan unless prior consent is given by Council's Health Inspector. All drainage work must be inspected by Council's Health Inspector prior to covering in.

A certificate of satisfactory completion must be obtained upon application.

RAIN OR SURFACE WATER MUST NOT BE DISCHARGED INTO SEWER.

			REFERENCE		
I.V.	Induct Vent	E.V.	Educt Vent	K.S.	Kitchen Sink
	Boundary Trap	S.V.P.	Soil Vent Pipe	Bth.	Bath
I.S.	Inspection Shaft	V.P.	Vent Pipe	Bsn.	Basin
•	Disconnector Trap	W.C.	Water Closet	S.B.	Shower Bath
G.T.	Grease Trap	T.	Laundry Tubs	S./R.	Shower Recess

Junction about 18.8 Metres from Pour stream manhole, Approx. depth. 900 mm 1:500 METRIC .

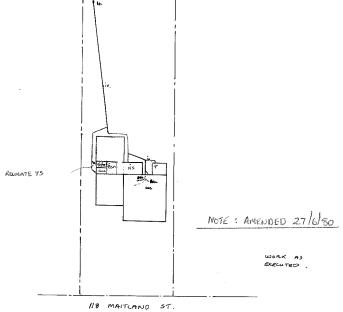


Health Surveyor

APPENDIX E: HISTORICAL TITLES SEARCH (INFOTRACK PTY LTD)



Cadastral Records Enquiry Report: Lot 34 DP 229637

Locality : MUSWELLBROOKParish : BROUGHAMLGA : MUSWELLBROOKCounty : DURHAM

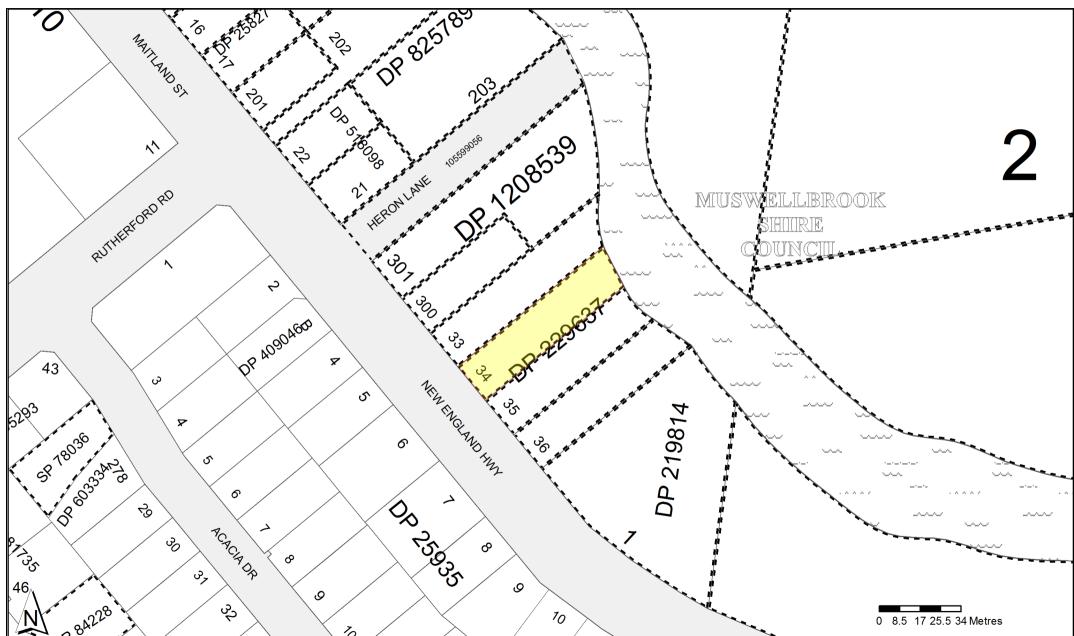

Report Generated 11:24:04 AM, 23 January, 2024 Copyright © Crown in right of New South Wales, 2017

This information is provided as a searching aid only. Whilst every endeavour is made to ensure that current map, plan and titling information is accurately reflected, the Registrar General cannot guarantee the information provided. For ALL ACTIVITY PRIOR TO SEPTEMBER 2002 you must refer to the RGs Charting and Reference Maps



Form 2 — This form must NOT be used where any Dedication, Drainage Reserve or Public Garden and Recreation Space is provided. — See Form 3, WARNING: CREASING OR FOLDING WILL LEAD TO REJECTION. DP229637 D.P 229637 Registered: 0 m. 4 19/7/1966 Q C.A.: No 468 of 14466 Title System: Torrens Purpose: Subdivision Ref. Map: Parish Last Plan. D. P. 219814 PLAN OF Subdivision of DR ZESZY 10+ 2 of 0.0. 210BIA Scale: SO feer to an Inch D.P. 21084

CONVERSION TABLE ADDED IN REGISTRAR GENERAL'S DEPARTMENT

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I, Bruce Richard Davies, Registror General for New South Wales, certify that this negative is a photograph made as a permanent record of a document in my custedy this 15th day of June, 1977


Req:R803753 /Doc:CT 09615-098 CT /Rev:14-Jan-2011 /NSW LRS /Pgs:ALL /Prt: © Office of the Registrar-General /Src:InfoTrack /Ref:118 Maitland Street G. 4 NEW SOUTH WALES.

> Appln. No. 2778 Prior Title Vol.

FICATE OF TITLE RTY ACT, 1900, as amended.

/Prt:23-Jan-2024 11:48



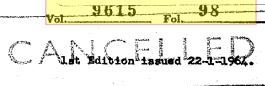

I certify that the person described in the First Schedule is the registered proprietor of the undermentioned estate in the land within described subject nevertheless to such exceptions encumbrances and interests as are shown in the Second Schedule.

Witness


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S 961

PERSONS ARE CAUTIONED AGAINST ALTERING OR ADDING TO THIS CERTIFICATE OR ANY NOTIFICATION HEREON

7226 Fol. 60



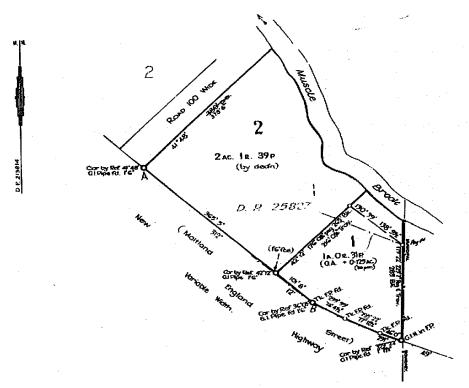

ESTATE AND LAND REFERRED TO

2 in Deposited Plan 219814 in the Municipality of Muswellbrook Parish of Estate in Fee Simple in Lot Brougham and County of Durham being part of Portion 2 granted to Francis Forbes on 9-4-1835 excepting thereout the minerals excepted by Transfer No. 0279132.

FIRST SCHEDULE (Continued overleaf)

HERBERT WALTER HOLLINS, of Muswellbrook, Labourer.

Registrar General.

SECOND SCHEDULE (Continued overleaf)

- Reservations and conditions, if any, contained in the Crown Grant(s) referred to in the said Deposited
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- Entered 12-8-1959-

Registrar General

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FORM No. 181A

(Page 2 of 2 pages)

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LAND TITLES OFFICE

NEW SOUTH WALES

Appln. No. 2778 Prior Title Vol. 9615 Fol. 98

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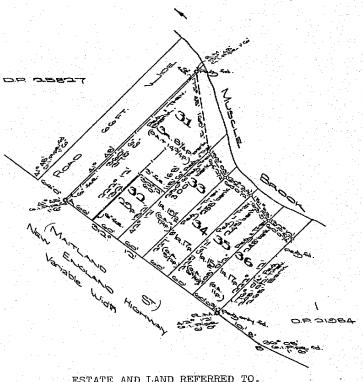
Edition issued 2-8-1966.

I certify that the person described in the First Schedule is the registered proprietor of the undermentioned estate in the land within

Witness

described subject nevertheless to such exceptions encumbrances and interests as are shown in the Second Schedule. 3. OSullivan.

Registrar General. PLAN SHOWING LOCATION OF LAND SEE AUTO FOLIS



ESTATE AND LAND REFERRED TO.

Estate in Fee Simple in Lot 34 in Deposited Plan 229637 in the Municipality of Muswellbrook, Parish of Brougham and County of Durham being part of Portion 2 granted to Francis Forbes on 9-4-1835 Estate in Fee Simple in Lot excepting thereout the minerals excepted by Transfer No. G279132.

FIRST SCHEDULE (Continued overleaf)

SECOND SCHEDULE (Continued overleaf)

1. Reservations and conditions, if any, contained in the Crown Grant above referred to.

2. Mortgage No. J738 to Rural Bank of New South Wales. Entered 21-8-1964. Doctors Tato Rural Bank of New South Wales. Entered 21-8-1964. Deschazed Kueruzz

Registrar General.

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		SECOND SCHEDULE (continued)				
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NOTE: ENTRIES RULED THROUGH AND AUTHENTICATED BY THE SEAL OF THE REGISTRAR-GENERAL ARE CANCELLED



NEW SOUTH WALES LAND REGISTRY SERVICES - HISTORICAL SEARCH

SEARCH DATE

23/1/2024 11:21AM

FOLIO: 34/229637

First Title(s): SEE PRIOR TITLE(S)
Prior Title(s): VOL 10366 FOL 232

Recorded	Number	Type of Instrument	C.T. Issue
5/6/1987		TITLE AUTOMATION PROJECT	LOT RECORDED FOLIO NOT CREATED
7/4/1988		CONVERTED TO COMPUTER FOLIO	FOLIO CREATED CT NOT ISSUED
22/6/1993	1426686	MORTGAGE	EDITION 1
29/2/1996 29/2/1996	0947781 0947782	DISCHARGE OF MORTGAGE MORTGAGE	EDITION 2
18/4/2008 18/4/2008 18/4/2008	AD898851 AD898852 AD898853	DISCHARGE OF MORTGAGE DISCHARGE OF MORTGAGE TRANSFER	
18/4/2008	AD898854	MORTGAGE	EDITION 3
29/9/2010	DP1156913	DEPOSITED PLAN	
20/4/2011	AG140728	TRANSFER GRANTING EASEMENT	EDITION 4
13/9/2013	AI18414	DEPARTMENTAL DEALING	
11/9/2017	AM714679	CONVERSION TO CORD	EDITION 5 CORD ISSUED
13/10/2017	AM802488	DISCHARGE OF MORTGAGE	
13/10/2017	AM802489	TRANSFER WITHOUT MONETARY CONSIDERATION	
13/10/2017	AM802490	MORTGAGE	EDITION 6 CORD ISSUED
21/12/2022	AS750783	DISCHARGE OF MORTGAGE	
21/12/2022	AS750784	TRANSFER	
21/12/2022	AS750785	MORTGAGE	EDITION 7

*** END OF SEARCH ***

118 Maitland Street

PRINTED ON 23/1/2024

Req:R803470 /Doc:DL AD898853 /Rev:18-Apr-2008 /NSW LRS /Pgs:ALL /Prt:23-Jan-2024 11:21 /Seq:1 of 2 © Office of the Registrar-General /Src:InfoTrack /Ref:118 Maitland Street Form: 01T TRANSFER Release: 2:1 www.lpi.nsw.gqv.au **New South Wales** AD898853D Real Property Act 1900 PRIVACY NOTE: this information is legally required and will become part of the public record NSW Treasury STAMP DUTY Office of State Revenue use only Client No: 93363039 1641 Trans No. 4719549 (A) TORRENS TITLE FOLIO IDENTIFIER 34/229637 (B) LODGED BY Name, Address or DX and Tele BOS BPA PTY LTD Delivery CODES 25 PIERSON ST LOCKLEY'S SA 5032 Box 25 TEL: 132558 LLPN: 123002H Reference: (Sheriff (C) TRANSFEROR LYNDON THEO PIEFKE AND SHARON LEE PIEFKE (D) CONSIDERATION The transferor acknowledges receipt of the consideration of \$ 200,000.00 and as regards **ESTATE** the land specified above transfers to the transferee an estate in fee simple (E) SHARE TRANSFERRED (G) Encumbrances (if applicable): (H) TRANSFEREE GREGORY LYNNE HALL AND LINDA EMILY HALL **(I)** Joint Tenants **(J)** DATE I certify that the person(s) signing opposite, with whom Certified correct for the purposes of the Real I am personally acquainted or as to whose identity I am Property Act 1900 by the transferor. otherwise satisfied, signed this instrument in my presence. Signature of witness: Signature of transferor: Name of witness: See Annexure Address of witness: Certified for the purposes of the Real Property Act 1900 by the person whose signature appears below. Signature: Signatory's name: ALEXANDER JOHN IRVING Signatory's capacity: transferee's solicitor Page 1 of number additional

All handwriting must be in block capitals.

pages sequentially

Land and Property Information NSW.

01TWC Form: Licence: 01-05-127 LEAP Legal Software Pty Limited Licensee: without monetary conside Kate Mailer Solicitor Firm name: **New South Wales** AM802489P Real Property Act 1900 PRIVACY NOTE: Section 31B of the Real Property Act 1900 (RP Act) authorises the Registrar General to collect the information required by this form for the establishment and maintenance of the Real Property Act Register. Section 368 RP Act regulars that the Register is made available to any person for search upon payment of a fee, if any. (NSW) Office of State Revenue use only STAMP DUTY Client No: 123775070 3804 Duty: EXEMPT Trans No. 9182344 - 401 s 68(1) (A) TORRENS TITLE 34/229637 (B) LODGED BY Document Name, Address or DX, Telephone, and Customer Account Number if any CODES Collection Box SAI GLOBAL DX 855 LLPN:123854C 535G SYDNEY 9210 0700 Reference: LINDA EMILY HALL (C) TRANSFEROR Pursuant to an order of the Federal Circuit Court of Australia dated 15 November, 2016 (D) CONSIDERATION and as regards the land specified above transfers to the transferee an estate in fee simple (E) ESTATE (F) SHARE whole **TRANSFERRED** (G) Encumbrances (if applicable): (H) TRANSFEREE GREGORY LYNNE HALL TENANCY: (1)DATE 4 october 2017 I certify that I am an eligible witness and that the transferor Certified correct for the purposes of the Real Property Act signed this dealing in my presence. 1900 by the transferor. [See note* below] Signature of witness: Signature of transferor: PROMUMBANTE Name of witness: Address of witness: / 127 Wrenfoolst Certified correct for the purposes of the Real Property Act (9,0NE NOW 2387 1900 on behalf of the transferee by the person whose signature appears below. Signature: rmau Signatory's name: Kate Mailer Signatory's capacity: Solicitor The transferee certifies that the eNOS data relevant to this dealing has been submitted and stored under KateMake Mall eNOS ID No. Full name: 141983 Signature:

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Req:R803471

Office of





NEW SOUTH WALES LAND REGISTRY SERVICES - TITLE SEARCH

FOLIO: 34/229637

EDITION NO DATE SEARCH DATE TIME _____ ____ -----____ 21/12/2022 23/1/2024 11:20 AM 7

LAND

LOT 34 IN DEPOSITED PLAN 229637 LOCAL GOVERNMENT AREA MUSWELLBROOK PARISH OF BROUGHAM COUNTY OF DURHAM TITLE DIAGRAM DP229637

FIRST SCHEDULE

TITLIANNE ABOUNADER JACKY ANGELOVSKA

AS JOINT TENANTS

(T AS750784)

SECOND SCHEDULE (5 NOTIFICATIONS)

- RESERVATIONS AND CONDITIONS IN THE CROWN GRANT(S)
- 2 G279132 LAND EXCLUDES MINERALS
- G279132 RIGHTS TO MINE 3
- AG140728 EASEMENT TO DRAIN SEWAGE 3 WIDE AFFECTING THE PART SHOWN DESIGNATED (Z) IN DP1156913
- 5 AS750785 MORTGAGE TO AMP BANK LIMITED

NOTATIONS

UNREGISTERED DEALINGS: NIL

*** END OF SEARCH ***

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